**KNOCKHARLEY LANDFILL LTD.** 

ENVIRONMENTAL IMPACT ASSESSMENT REPORT (EIAR)

FOR THE PROPOSED DEVELOPMENT AT KNOCKHARLEY LANDFILL

**VOLUME 4 - DRAWINGS** 

**NOVEMBER 2018** 





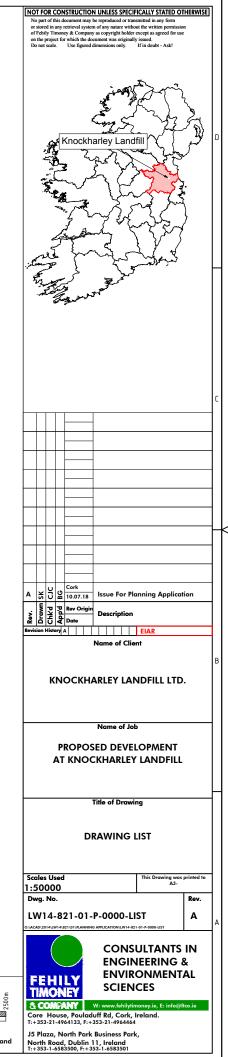




Sheet FTC-A1-2015 rev. A (template filed in O:Acad\Templates\Autocad) (Dec 2015) - template externally referenced

Drawing Number	Drawing List					
Wild-Red   Color   C	Drawing Number			Scale	Size	Drawing Pack
W14-821-01-P-0000-000	LW14-821-01-P-0000-LIST	DRAWING LIST		n/a	n/a	Planning
W14-422-01-P-0000-001	LW14-821-01-P-0000-BDY	OWNERSHIP BOUNDARY LAYOUT		1:7,500	A3	Planning
Wil-4821-01-0000-003	LW14-821-01-P-0000-000	1:50,000 SITE LOCATION MAP		1:50,000	А3	Planning
INVISED 19-00000001   PROPOSED SITE LAYOUT FAIN   13,750	LW14-821-01-P-0000-001	1:10,000 SITE LOCATION MAP		1:10,000	А3	Planning
MUNI-1422-10-1-P0000-005   PROPOSED STIL LAUGH FLAN SHEET 1 OF 8   1,1,000	LW14-821-01-P-0000-002	EXISTING SITE LAYOUT		1:3,750	A1	Planning
MIM-62-01-0-0000-005   PROPOSED STIE LANDUE PLAN SHEET 2 OR 8   1.1,000   A1   Planning   MIM-62-01-01-0000-006   PROPOSED STIE LANDUE PLAN SHEET 3 OR 8   1.1,000   A1   Planning   MIM-62-01-0-0000-007   PROPOSED STIE LANDUE PLAN SHEET 3 OR 8   1.1,000   A1   Planning   MIM-62-01-0-0000-008   PROPOSED STIE LANDUE PLAN SHEET 5 OR 8   1.1,000   A1   Planning   MIM-62-01-0-0000-009   PROPOSED STIE LANDUE PLAN SHEET 5 OR 8   1.1,000   A1   Planning   MIM-62-01-0-0000-009   PROPOSED STIE LANDUE PLAN SHEET 5 OR 8   1.1,000   A1   Planning   MIM-62-01-0-0000-010   PROPOSED STIE LANDUE PLAN SHEET 8 OR 8   1.1,000   A1   Planning   MIM-62-01-0-0000-010   PROPOSED STIE LANDUE PLAN SHEET 8 OR 8   1.1,000   A1   Planning   MIM-62-01-0-0000-012   PROPOSED STIE LANDUE PLAN SHEET 8 OR 8   1.1,000   A1   Planning   MIM-62-01-0-0000-012   PROPOSED STIE LANDUE PLAN SHEET 8 OR 8   1.1,000   A1   Planning   MIM-62-01-0-0000-013   PROPOSED STIE LANDUE PLAN SHEET 8 OR 8   1.1,000   A1   Planning   MIM-62-01-0-0000-013   PROPOSED STIE MANDE PLAN SHEET 8 OR 8   1.1,000   A1   Planning   MIM-62-01-0-0000-013   PLAN SHOWN PROPOSED DIRECTARD CURRENT PLAN SHOWN PROPOSED PLAN SHOWN	LW14-821-01-P-0000-003	PROPOSED SITE LAYOUT PLAN		1:3,750	A1	Planning
MIN4-92-10-P-0000-006   PROPOSED STIE LANDUE FAM SHEET 3 OF 8   1.1,000	LW14-821-01-P-0000-004	PROPOSED SITE LAYOUT PLAN SHEET 1	OF 8	1:1,000	A1	Planning
MINI-142-10-1-P.0000-007   PROPOSED STE LAVOUT FAMS SEETS OF 8   1.1,000	LW14-821-01-P-0000-005	PROPOSED SITE LAYOUT PLAN SHEET 2	OF 8	1:1,000	A1	Planning
WH4 821-01-P0000-008   PROPOSED STE LANDUT PLAN SHEET 5 OF 8	LW14-821-01-P-0000-006	PROPOSED SITE LAYOUT PLAN SHEET 3	OF 8	1:1,000	A1	Planning
WITH 4821-01-0000-009	LW14-821-01-P-0000-007	PROPOSED SITE LAYOUT PLAN SHEET 4	OF 8	1:1,000	A1	Planning
INVITED   PROPOSED SITE LAYOUT PLAN SHEET FOR 8	LW14-821-01-P-0000-008	PROPOSED SITE LAYOUT PLAN SHEET 5	OF 8	1:1,000	A1	Planning
MUH4 821-01-0000-011	LW14-821-01-P-0000-009	PROPOSED SITE LAYOUT PLAN SHEET 6	OF 8	1:1,000	A1	
INVITABLE   101-0000-012   ASSESSMENT OF ALTERNATIVES   1,3,750					A1	
INVITABLE 2014 P.0000-013				-	A1	Planning
LW14821-01-P-0050-001   EXISTING MONITORING LOCATIONS   13,750						
INVITABLE   11-PO050-002   PROPOSED ENVIRONMENTAL MONITORING LOCATIONS   13,750   A1   ELAR   INVITABLE   11-PO050-003   EXISTING FORESTATION PROPOSED FELING & NEW PLANTING   13,750   A1   ELAR   INVITABLE   11-PO050-004   EXISTING STIE LAYOUT PLAN WITH INFRASTRUCTURE LOCATIONS   13,750   A1   ELAR   INVITABLE   11-PO050-005   PROPOSED STE LAYOUT PLAN WITH INFRASTRUCTURE LOCATIONS   13,750   A1   ELAR   INVITABLE   11-PO050-005   PROPOSED STE LAYOUT PLAN WITH INFRASTRUCTURE LOCATIONS   13,750   A1   ELAR   INVITABLE   11-PO050-005   PROPOSED STE LAYOUT PLAN WITH INFRASTRUCTURE LOCATIONS   13,750   A1   ELAR   INVITABLE   11-PO050-005   INVITABLE   11-PO050-00						Planning
EMITHAGE   10-P-0050-001						
W14 821-01-P-0050-005   PROPOSED SITE LAYOUT WITH INFRASTRUCTURE LOCATIONS   13,750   A1   EAR   INV14-821-01-P-0050-005   PROPOSED SITE LAYOUT PLAN WITH INFRASTRUCTURE LOCATIONS   13,750   A1   EAR   INV14-821-01-P-0050-006   PROPOSED SITE LAYOUT PLAN WITH INFRASTRUCTURE LOCATIONS   13,750   A1   EAR   INV14-821-01-P-0050-007   TRAFFIC MANAGEMENT ISA FACILITY   1:500   A1   EAR   INV14-821-01-P-0050-008   TRAFFIC MANAGEMENT ISA FACILITY   1:500   A1   EAR   INV14-821-01-P-0050-009   TRAFFIC MANAGEMENT EACHATE MANAGEMENT FACILITY   1:500   A1   EAR   INV14-821-01-P-0050-009   TRAFFIC MANAGEMENT EACHATE MANAGEMENT FACILITY   1:500   A1   EAR   INV14-821-01-P-0050-001   PROPOSED LELI FILLING   1:2,500   A1   Planning & EAR   INV14-821-01-P-0050-001   CUT/FILL PHASING PLAN   1:5,000   A1   Planning & EAR   INV14-821-01-P-0103-001   PROPOSED STE CROSS SECTIONS   1:5,000   A1   Planning & EAR   INV14-821-01-P-0103-001   PROPOSED STE CROSS SECTIONS   1:5,000   A1   Planning & EAR   INV14-821-01-P-0103-001   PROPOSED STE CROSS SECTIONS   1:5,000   A1   Planning & EAR   INV14-821-01-P-0103-002   PROPOSED STE CROSS SECTIONS   1:5,000   A1   Planning & EAR   INV14-821-01-P-0103-003   PROPOSED STE CROSS SECTIONS   1:5,000   A1   Planning & EAR   INV14-821-01-P-0103-003   PROPOSED STE CROSS SECTIONS   1:5,000   A1   Planning & EAR   INV14-821-01-P-0103-003   PROPOSED STE CROSS SECTIONS   1:5,000   A1   Planning & EAR   INV14-821-01-P-0103-003   PROPOSED STE CROSS SECTIONS   1:5,000   A1   Planning & EAR   INV14-821-01-P-0500-0001   PROPOSED MANAGEMENT PLAN OF SURFACE WATER MANAGEMENT INFRASTRUCTURE   1:000   A1   Planning & EAR   INV14-821-01-P-0500-0001   PROPOSED SURFACE WATER MANAGEMENT INFRASTRUCTURE   1:000   A1   Planning & EAR   P						
INVITABLE 21-01-P-0050-005   PROPOSED ISTE LAYOUT PLAN WITH INFRASTRUCTURE LOCATIONS   13,750   A1   Planning   Planning   PROPOSED ISTE CHOST PLAN WITH INFRASTRUCTURE LOCATIONS   1,500   A1   Planning   Pla						
LW14-821-01-P-0050-006   PROPOSED IBA FACILITY BUILDING LOCATION AND CROSS SECTION   1:500						
W14-821-01-P-0050-007						
LW14-821-01-P-0050-008   TRAFFIC MANAGEMENT BIOLOGICAL TREATMENT FACILITY   1:500						
LW14-821-01-P-0050-009   TRAFFIC MANAGEMENT LEACHATE MANAGEMENT FACILITY   1:500   A1   EIAR						
1500   A1   EAR			NT FACILITY			
LW14-821-01-P-0050-011					A1	
LW14-821-01-P-0050-012				1:2,500	A1	Planning & EIAR
W14-821-01-P-0103-001   PROPOSED SITE CROSS SECTIONS   1:1000				1:7,500	A1	Planning & EIAR
LW14-821-01-P-0103-002   PROPOSED SITE CROSS SECTIONS   1:000				1:5,000	A1	
LW14-821-01-P-0103-004   PROPOSED CROSS SECTIONS of POND And LEACHATE LAGOONS   1:200   A1   Planning   LW14-821-01-P-0500-002   SURFACE WATER MANAGEMENT INFRASTRUCTURE LAYOUT PLANS   1:200   A1   Planning   LW14-821-01-P-0500-003   PROPOSED SURFACE WATER INFRASTRUCTURE LAYOUT PLANS   1:200   A1   Planning   LW14-821-01-P-0500-004   LAMP STANDARD, GAS EXTRACTION AND SWALE INLET DETAILS   Vary   A1   Planning   LW14-821-01-P-0500-005   DETAILS OF SULT FERNCE   1:20   A1   Planning   LW14-821-01-P-0500-006   SITE LAYOUT WITH EXISTING STREAM STRUCTURES   1:5000   A1   Planning   LW14-821-01-P-0600-001   PROPOSED LEACHATE MANAGEMENT FACILITY   1:500   A1   Planning   LW14-821-01-P-0600-002   TANK FARM And LEACHATE TREATMENT EQUIPMENT ELEVATIONS   1:200   A1   Planning   LW14-821-01-P-0600-003   TANK FARM And LEACHATE TREATMENT EQUIPMENT ELEVATIONS   1:200   A1   Planning   LW14-821-01-P-0600-003   TANK FARM And LEACHATE TREATMENT EQUIPMENT PLAN   1:200   A1   Planning   LW14-821-01-P-0600-005   PROPOSED LEACHATE TREATMENT EQUIPMENT PLAN   1:200   A1   Planning   LW14-821-01-P-0600-005   PROPOSED WHEEL WASH DETAILS   1:500   A1   Planning   LW14-821-01-P-0000-005   PROPOSED WHEEL WASH DETAILS   1:500   A1   Planning   LW14-821-01-P-1700-000   OVERVIEW OF BIOLOGICAL TREATMENT FACILITY AND IBA FACILITY BUILDING   n/a   A1   Planning   LW14-821-01-P-1700-001   SITE LAYOUT PLAN OF PROPOSED BIOLOGICAL TREATMENT FACILITY GROUND FLOOR PLAN   1:200   A1   Planning   LW14-821-01-P-1700-002   PROPOSED BIOLOGICAL TREATMENT FACILITY GROUND FLOOR PLAN   1:200   A1   Planning   LW14-821-01-P-1700-005   PROPOSED BIOLOGICAL TREATMENT FACILITY FROM PLAN   1:200   A1   Planning   LW14-821-01-P-1700-005   PROPOSED BIOLOGICAL TREATMENT FACILITY FROM PLAN   1:200   A1   Planning   LW14-821-01-P-1700-005   PROPOSED BIOLOGICAL TREATMENT FACILITY ELEVATIONS   1:200   A1   Planning   LW14-821-01-P-1700-006   PROPOSED BIOLOGICAL TREATMENT FACILITY CROSS SECTIONS   1:200   A1   Planning   LW14-821-01-P-1700-007   DETAILS OF FULL RETENTION O						Planning
LW14-821-01-P-0103-004   PROPOSED CROSS SECTIONS of POND And LEACHATE LAGOONS   1:200						Planning
LW14-821-01-P-0103-004   PROPOSED CROSS SECTIONS of POND And LEACHATE LAGOONS   1:200	LW14-821-01-P-0103-003	PROPOSED SITE CROSS SECTIONS		1:200	A1	Planning
LW14-821-01-P-0500-002         SURFACE WATER MANAGEMENT INFRASTRUCTURE LAYOUT PLANS         1:200         A1         Planning & EIAR           LW14-821-01-P-0500-003         PROPOSED SURFACE WATER INFRASTRUCTURE CROSS SECTIONS         1:1000         A1         Planning           LW14-821-01-P-0500-004         LAMP STANDARD, GAS EXTRACTION AND SWALE INLET DETAILS         Vary         A1         Planning           LW14-821-01-P-0500-005         DETAILS OF SILT FENCE         1:20         A1         Planning           LW14-821-01-P-0500-006         SITE LAYOUT WITH EXISTING STREAM STRUCTURES         1:5000         A1         Planning           LW14-821-01-P-0600-001         PROPOSED LEACHATE TREATMENT EQUIPMENT ELEVATIONS         1:200         A1         Planning           LW14-821-01-P-0600-002         TANK FARM AND LEACHATE TREATMENT EQUIPMENT ELEVATIONS         1:200         A1         Planning           LW14-821-01-P-0600-003         TANK FARM AND LEACHATE TREATMENT EQUIPMENT PLAN         1:200         A1         Planning           LW14-821-01-P-0600-004         CROSS SECTIONS THROUGH FLOATING COVER LAGOONS         1:500         A1         Planning           LW14-821-01-P-1700-000         OVERVIEW OF BIOLOGICAL TREATMENT FACILITY AND IBBA FACILITY BUILDING         n/a         A1         Planning           LW14-821-01-P-1700-001						Planning
SURFACE WATER MANAGEMENT INTRASTRUCTURE LAYOUT PLANS   1:200   A1   Planning		PROPOSED MANAGEMENT PLAN OF SURFACE WATER MANAG	EMENT INFRASTRUCTURE	1:1000	A1	Planning
LW14-821-01-P-0500-004         LAMP STANDARD, GAS EXTRACTION AND SWALE INLET DETAILS         Vary         A1         Planning           LW14-821-01-P-0500-005         DETAILS OF SILT FENCE         1:20         A1         Planning           LW14-821-01-P-0500-006         SITE LAYOUT WITH EXISTING STREAM STRUCTURES         1:5000         A1         Planning           LW14-821-01-P-0600-001         PROPOSED LEACHATE MANAGEMENT FACILITY         1:500         A1         Planning           LW14-821-01-P-0600-002         TANK FARM And LEACHATE TREATMENT EQUIPMENT ELEVATIONS         1:200         A1         Planning           LW14-821-01-P-0600-003         TANK FARM And LEACHATE TREATMENT EQUIPMENT PLAN         1:200         A1         Planning           LW14-821-01-P-0600-003         TANK FARM And LEACHATE TREATMENT EQUIPMENT PLAN         1:200         A1         Planning           LW14-821-01-P-0600-004         CROSS SECTIONS THROUGH FLOATING COVER LAGOONS         1:500         A1         Planning           LW14-821-01-P-0600-005         PROPOSED WHEEL WASH DETAILS         1:50         A1         Planning           LW14-821-01-P-1700-000         OVERVIEW OF BIOLOGICAL TREATMENT FACILITY AND IBA FACILITY BUILDING         n/a         A1         Planning           LW14-821-01-P-1700-001         SITE LAYOUT PLAN OF PROPOSED BIOLOGICAL TREATMENT FACILITY GROUND FLOOR PLAN					A1	
LW14-821-01-P-0500-005         DETAILS OF SILT FENCE         1:20         A1         Planning           LW14-821-01-P-0500-006         SITE LAYOUT WITH EXISTING STREAM STRUCTURES         1:5000         A1         Planning           LW14-821-01-P-0600-001         PROPOSED LEACHATE MANAGEMENT FACILITY         1:500         A1         Planning           LW14-821-01-P-0600-002         TANK FARM AND LEACHATE TREATMENT EQUIPMENT ELEVATIONS         1:200         A1         Planning           LW14-821-01-P-0600-003         TANK FARM AND LEACHATE TREATMENT EQUIPMENT PLAN         1:200         A1         Planning           LW14-821-01-P-0600-003         TANK FARM AND LEACHATE TREATMENT EQUIPMENT PLAN         1:200         A1         Planning           LW14-821-01-P-0600-003         TANK FARM AND LEACHATE TREATMENT EQUIPMENT PLAN         1:200         A1         Planning           LW14-821-01-P-0600-004         CROSS SECTIONS THROUGH FLOATING COVER LAGOONS         1:500         A1         Planning           LW14-821-01-P-1700-005         PROPOSED WHEEL WASH DETAILS         1:50         A1         Planning           LW14-821-01-P-1700-000         OVERVIEW OF BIOLOGICAL TREATMENT FACILITY AND IBA FACILITY BUILDING         n/a         A1         Planning           LW14-821-01-P-1700-001         SITE LAYOUT PLAN OF PROPOSED BIOLOGICAL TREATMENT FACILITY FIRST FLOOR PLAN <td< td=""><td></td><td></td><td></td><td></td><td>A15</td><td></td></td<>					A15	
LW14-821-01-P-0500-006         SITE LAYOUT WITH EXISTING STREAM STRUCTURES         1:500         A1         Planning           LW14-821-01-P-0600-001         PROPOSED LEACHATE MANAGEMENT FACILITY         1:500         A1         Planning           LW14-821-01-P-0600-002         TANK FARM And LEACHATE TREATMENT EQUIPMENT ELEVATIONS         1:200         A1         Planning           LW14-821-01-P-0600-003         TANK FARM AND LEACHATE TREATMENT EQUIPMENT PLAN         1:200         A1         Planning           LW14-821-01-P-0600-004         CROSS SECTIONS THROUGH FLOATING COVER LAGOONS         1:500         A1         Planning           LW14-821-01-P-0600-005         PROPOSED WHEEL WASH DETAILS         1:50         A1         Planning           LW14-821-01-P-1700-000         OVERVIEW OF BIOLOGICAL TREATMENT FACILITY AND IBA FACILITY BUILDING         n/a         A1         Planning           LW14-821-01-P-1700-001         SITE LAYOUT PLAN OF PROPOSED BIOLOGICAL TREATMENT FACILITY         1:500         A1         Planning           LW14-821-01-P-1700-002         PROPOSED BIOLOGICAL TREATMENT FACILITY GROUND FLOAN         1:200         A1         Planning           LW14-821-01-P-1700-003         PROPOSED BIOLOGICAL TREATMENT FACILITY CORD PLAN         1:200         A1         Planning           LW14-821-01-P-1700-004         PROPOSED BIOLOGICAL TREATMENT FACILITY CROSS SECTI		<u>'</u>				
LW14-821-01-P-0600-001         PROPOSED LEACHATE MANAGEMENT FACILITY         1:500         A1         Planning           LW14-821-01-P-0600-002         TANK FARM AND LEACHATE TREATMENT EQUIPMENT ELEVATIONS         1:200         A1         Planning           LW14-821-01-P-0600-003         TANK FARM AND LEACHATE TREATMENT EQUIPMENT PLAN         1:200         A1         Planning           LW14-821-01-P-0600-004         CROSS SECTIONS THROUGH FLOATING COVER LAGOONS         1:500         A1         Planning           LW14-821-01-P-0600-005         PROPOSED WHEEL WASH DETAILS         1:50         A1         Planning           LW14-821-01-P-1700-000         OVERVIEW OF BIOLOGICAL TREATMENT FACILITY AND IBA FACILITY BUILDING         n/a         A1         Planning           LW14-821-01-P-1700-001         SITE LAYOUT PLAN OF PROPOSED BIOLOGICAL TREATMENT FACILITY GROUND FLOOR PLAN         1:500         A1         Planning           LW14-821-01-P-1700-002         PROPOSED BIOLOGICAL TREATMENT FACILITY FIRST FLOOR PLAN         1:200         A1         Planning           LW14-821-01-P-1700-003         PROPOSED BIOLOGICAL TREATMENT FACILITY CROSS SECTIONS         1:200         A1         Planning           LW14-821-01-P-1700-004         PROPOSED BIOLOGICAL TREATMENT FACILITY CROSS SECTIONS         1:200         A1         Planning           LW14-821-01-P-1700-005         PROPOSED BIOL						
LW14-821-01-P-0600-002         TANK FARM AND LEACHATE TREATMENT EQUIPMENT ELEVATIONS         1:200         A1         Planning           LW14-821-01-P-0600-003         TANK FARM AND LEACHATE TREATMENT EQUIPMENT PLAN         1:200         A1         Planning           LW14-821-01-P-0600-004         CROSS SECTIONS THROUGH FLOATING COVER LAGOONS         1:500         A1         Planning           LW14-821-01-P-0600-005         PROPOSED WHEEL WASH DETAILS         1:50         A1         Planning           LW14-821-01-P-1700-000         OVERVIEW OF BIOLOGICAL TREATMENT FACILITY AND IBA FACILITY BUILDING         n/a         A1         Planning           LW14-821-01-P-1700-001         SITE LAYOUT PLAN OF PROPOSED BIOLOGICAL TREATMENT FACILITY         1:500         A1         Planning           LW14-821-01-P-1700-002         PROPOSED BIOLOGICAL TREATMENT FACILITY GROUND FLOOR PLAN         1:200         A1         Planning           LW14-821-01-P-1700-003         PROPOSED BIOLOGICAL TREATMENT FACILITY FIRST FLOOR PLAN         1:200         A1         Planning           LW14-821-01-P-1700-004         PROPOSED BIOLOGICAL TREATMENT FACILITY ROOF PLAN         1:200         A1         Planning           LW14-821-01-P-1700-005         PROPOSED BIOLOGICAL TREATMENT FACILITY ELEVATIONS         1:200         A1         Planning           LW14-821-01-P-1700-006         PROPOSED BIOLOGICAL T						
LW14-821-01-P-0600-003         TANK FARM AND LEACHATE TREATMENT EQUIPMENT PLAN         1:200         A1         Planning           LW14-821-01-P-0600-004         CROSS SECTIONS THROUGH FLOATING COVER LAGOONS         1:500         A1         Planning           LW14-821-01-P-0600-005         PROPOSED WHEEL WASH DETAILS         1:50         A1         Planning           LW14-821-01-P-1700-000         OVERVIEW OF BIOLOGICAL TREATMENT FACILITY AND IBA FACILITY BUILDING         n/a         A1         Planning           LW14-821-01-P-1700-001         SITE LAYOUT PLAN OF PROPOSED BIOLOGICAL TREATMENT FACILITY         1:500         A1         Planning           LW14-821-01-P-1700-002         PROPOSED BIOLOGICAL TREATMENT FACILITY GROUND FLOOR PLAN         1:200         A1         Planning           LW14-821-01-P-1700-003         PROPOSED BIOLOGICAL TREATMENT FACILITY ROOF PLAN         1:200         A1         Planning           LW14-821-01-P-1700-004         PROPOSED BIOLOGICAL TREATMENT FACILITY ROOF PLAN         1:200         A1         Planning           LW14-821-01-P-1700-005         PROPOSED BIOLOGICAL TREATMENT FACILITY CROSS SECTIONS         1:200         A1         Planning           LW14-821-01-P-1700-006         PROPOSED BIOLOGICAL TREATMENT FACILITY ELEVATIONS         1:200         A1         Planning           LW14-821-01-P-1700-007         DETAILS OF FULL RETENTION OI						
LW14-821-01-P-0600-004         CROSS SECTIONS THROUGH FLOATING COVER LAGOONS         1:500         A1         Planning           LW14-821-01-P-0600-005         PROPOSED WHEEL WASH DETAILS         1:50         A1         Planning           LW14-821-01-P-1700-000         OVERVIEW OF BIOLOGICAL TREATMENT FACILITY AND IBA FACILITY BUILDING         n/a         A1         Planning           LW14-821-01-P-1700-001         SITE LAYOUT PLAN OF PROPOSED BIOLOGICAL TREATMENT FACILITY         1:500         A1         Planning           LW14-821-01-P-1700-002         PROPOSED BIOLOGICAL TREATMENT FACILITY GROUND FLOOR PLAN         1:200         A1         Planning           LW14-821-01-P-1700-003         PROPOSED BIOLOGICAL TREATMENT FACILITY ROOF PLAN         1:200         A1         Planning           LW14-821-01-P-1700-004         PROPOSED BIOLOGICAL TREATMENT FACILITY ROOF PLAN         1:200         A1         Planning           LW14-821-01-P-1700-005         PROPOSED BIOLOGICAL TREATMENT FACILITY CROSS SECTIONS         1:200         A1         Planning           LW14-821-01-P-1700-006         PROPOSED BIOLOGICAL TREATMENT FACILITY ELEVATIONS         1:200         A1         Planning           LW14-821-01-P-1700-007         DETAILS OF FULL RETENTION OIL INTERCEPTOR         1:25         A1         Planning           LW14-821-01-P-1700-008         PROPOSED BIOLOGICAL TREATMENT FACIL		·				
LW14-821-01-P-0600-005         PROPOSED WHEEL WASH DETAILS         1:50         A1         Planning           LW14-821-01-P-1700-000         OVERVIEW OF BIOLOGICAL TREATMENT FACILITY AND IBA FACILITY BUILDING         n/a         A1         Planning           LW14-821-01-P-1700-001         SITE LAYOUT PLAN OF PROPOSED BIOLOGICAL TREATMENT FACILITY         1:500         A1         Planning           LW14-821-01-P-1700-002         PROPOSED BIOLOGICAL TREATMENT FACILITY GROUND FLOOR PLAN         1:200         A1         Planning           LW14-821-01-P-1700-003         PROPOSED BIOLOGICAL TREATMENT FACILITY ROST PLAN         1:200         A1         Planning           LW14-821-01-P-1700-004         PROPOSED BIOLOGICAL TREATMENT FACILITY ROST PLAN         1:200         A1         Planning           LW14-821-01-P-1700-005         PROPOSED BIOLOGICAL TREATMENT FACILITY CROSS SECTIONS         1:200         A1         Planning           LW14-821-01-P-1700-006         PROPOSED BIOLOGICAL TREATMENT FACILITY ELEVATIONS         1:200         A1         Planning           LW14-821-01-P-1700-007         DETAILS OF FULL RETENTION OIL INTERCEPTOR         1:25         A1         Planning           LW14-821-01-P-1700-008         PROPOSED BIOLOGICAL TREATMENT FACILITY LEACHATE & SEPTIC TANK DETAILS         1:50         A1         Planning           LW14-821-01-P-1700-010         ESB MV SUBST						
LW14-821-01-P-1700-000         OVERVIEW OF BIOLOGICAL TREATMENT FACILITY AND IBA FACILITY BUILDING         n/a         A1         Planning           LW14-821-01-P-1700-001         SITE LAYOUT PLAN OF PROPOSED BIOLOGICAL TREATMENT FACILITY         1:500         A1         Planning           LW14-821-01-P-1700-002         PROPOSED BIOLOGICAL TREATMENT FACILITY GROUND FLOOR PLAN         1:200         A1         Planning           LW14-821-01-P-1700-003         PROPOSED BIOLOGICAL TREATMENT FACILITY ROOF PLAN         1:200         A1         Planning           LW14-821-01-P-1700-004         PROPOSED BIOLOGICAL TREATMENT FACILITY ROOF PLAN         1:200         A1         Planning           LW14-821-01-P-1700-005         PROPOSED BIOLOGICAL TREATMENT FACILITY CROSS SECTIONS         1:200         A1         Planning           LW14-821-01-P-1700-006         PROPOSED BIOLOGICAL TREATMENT FACILITY ELEVATIONS         1:200         A1         Planning           LW14-821-01-P-1700-007         DETAILS OF FULL RETENTION OIL INTERCEPTOR         1:25         A1         Planning           LW14-821-01-P-1700-008         PROPOSED BIOLOGICAL TREATMENT FACILITY LEACHATE & SEPTIC TANK DETAILS         1:50         A1         Planning           LW14-821-01-P-1700-010         ESB MV SUBSTATION DETAILS         1:50         A1         Planning           LW14-821-01-P-1700-021         PROPOSED IBA F						
LW14-821-01-P-1700-001         SITE LAYOUT PLAN OF PROPOSED BIOLOGICAL TREATMENT FACILITY         1:500         A1         Planning           LW14-821-01-P-1700-002         PROPOSED BIOLOGICAL TREATMENT FACILITY GROUND FLOOR PLAN         1:200         A1         Planning           LW14-821-01-P-1700-003         PROPOSED BIOLOGICAL TREATMENT FACILITY FIRST FLOOR PLAN         1:200         A1         Planning           LW14-821-01-P-1700-004         PROPOSED BIOLOGICAL TREATMENT FACILITY ROOF PLAN         1:200         A1         Planning           LW14-821-01-P-1700-005         PROPOSED BIOLOGICAL TREATMENT FACILITY CROSS SECTIONS         1:200         A1         Planning           LW14-821-01-P-1700-006         PROPOSED BIOLOGICAL TREATMENT FACILITY ELEVATIONS         1:200         A1         Planning           LW14-821-01-P-1700-007         DETAILS OF FULL RETENTION OIL INTERCEPTOR         1:25         A1         Planning           LW14-821-01-P-1700-008         PROPOSED BIOLOGICAL TREATMENT FACILITY LEACHATE & SEPTIC TANK DETAILS         1:50         A1         Planning           LW14-821-01-P-1700-010         ESB MV SUBSTATION DETAILS         1:50         A1         Planning           LW14-821-01-P-1700-021         PROPOSED IBA FACILITY BUILDING FLOOR PLAN         1:200         A1         Planning           LW14-821-01-P-1700-022         PROPOSED IBA FACILITY BUILDING						
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LW14-821-01-P-1700-023 PROPOSED IBA FACILITY BUILDING SECTION AND ELEVATIONS 1:200 A1 Planning	LW14-821-01-P-1700-022	PROPOSED IBA FACILITY BUILDING ROOF	PLAN	1:200	A1	
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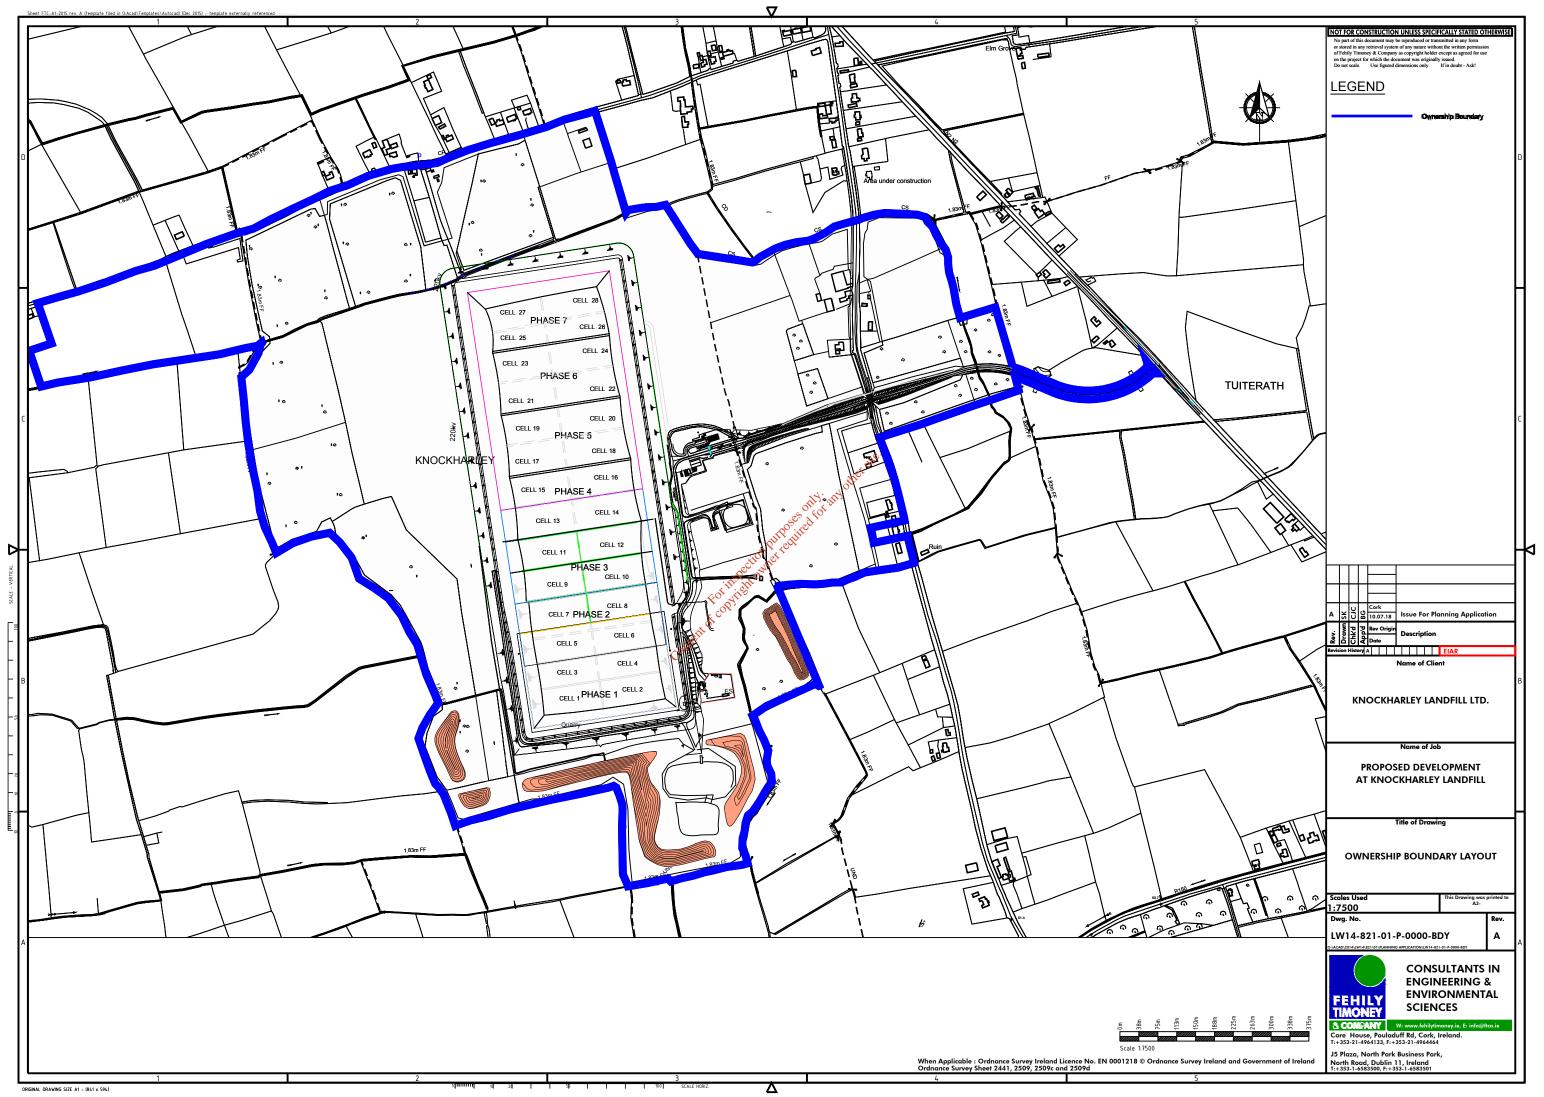


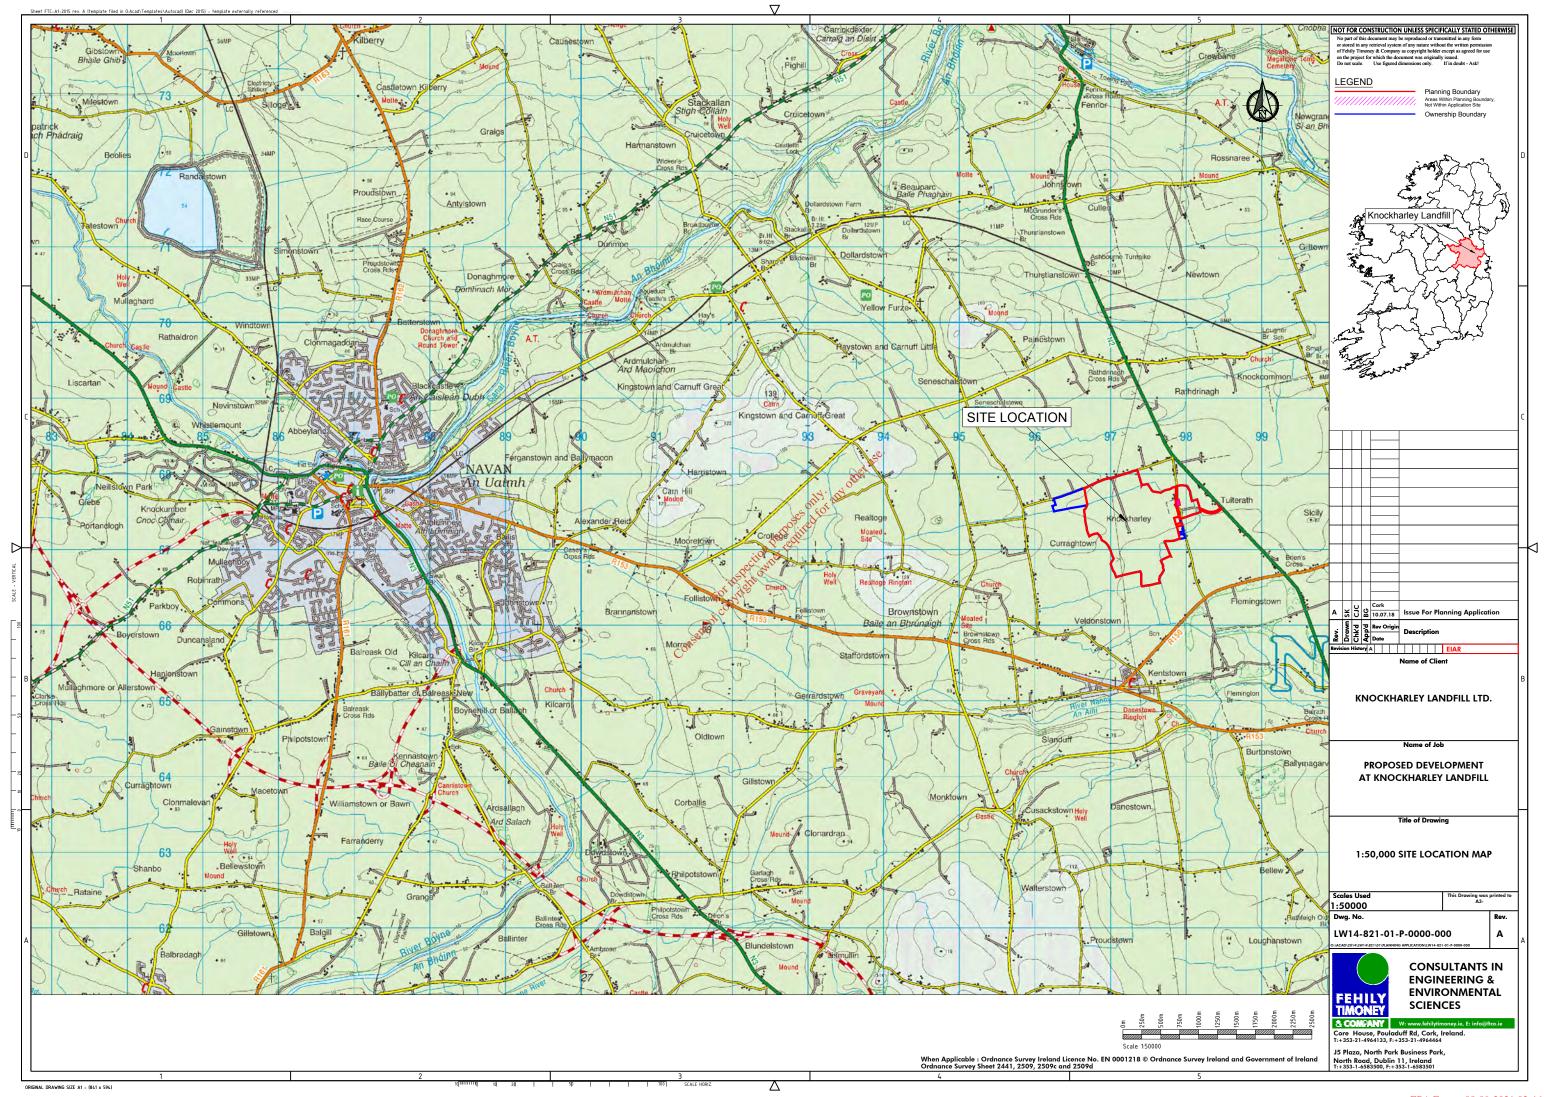
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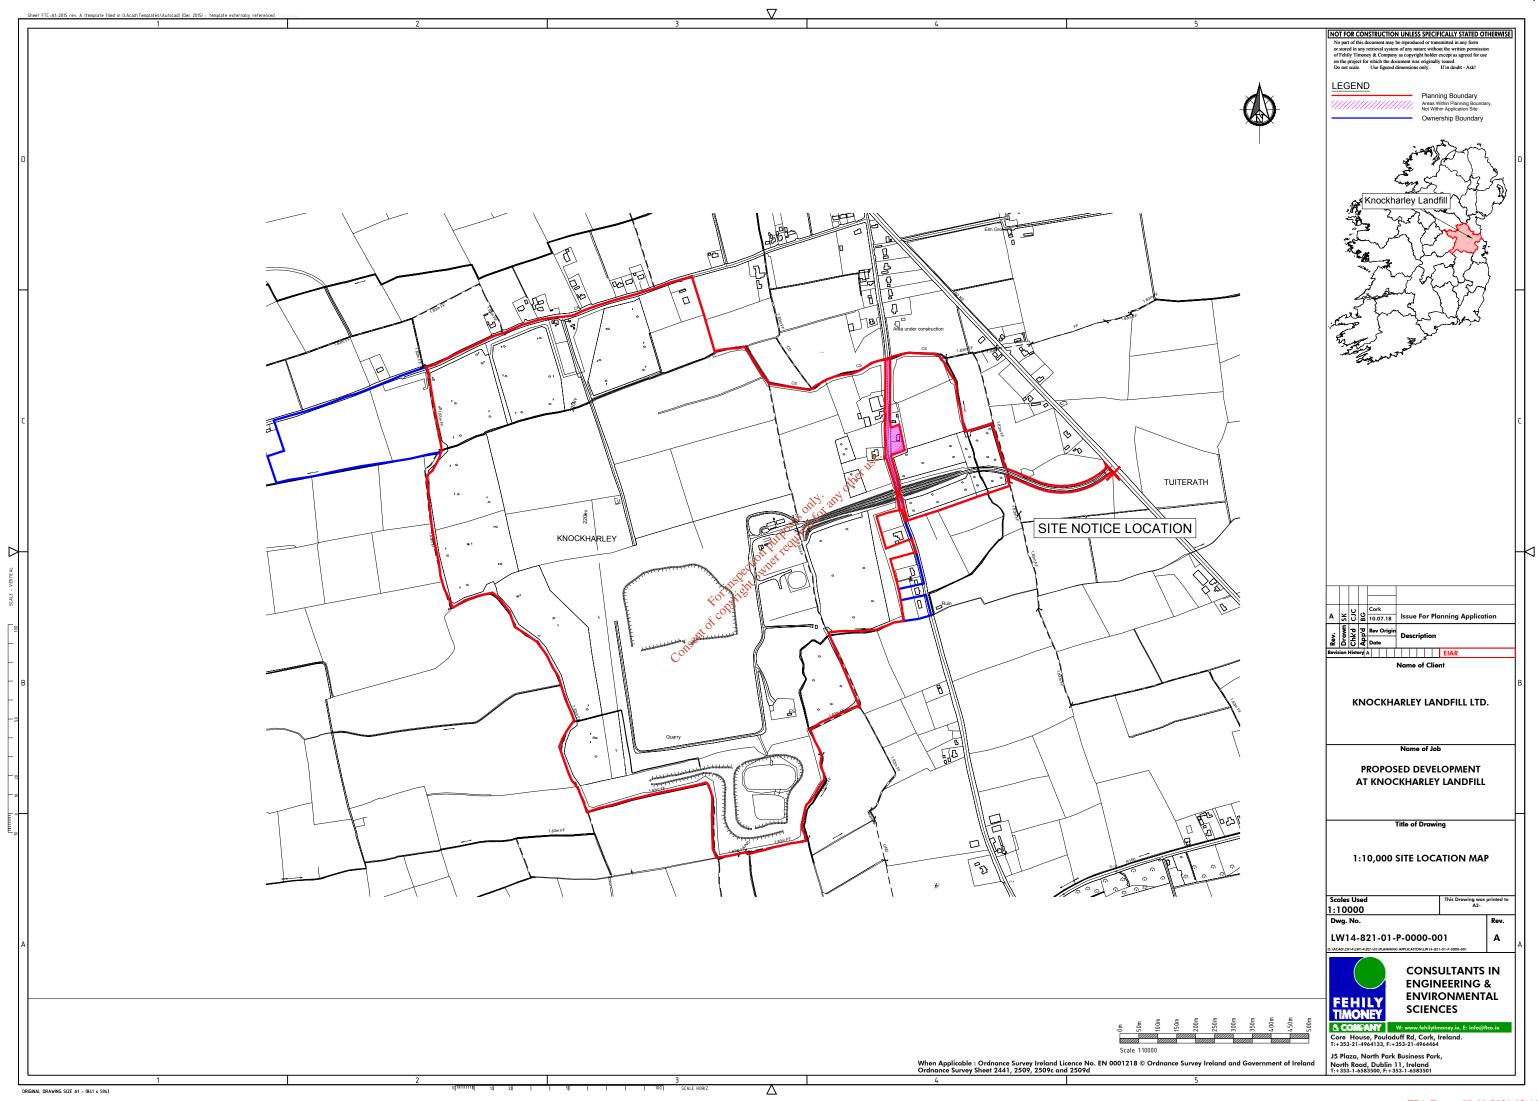
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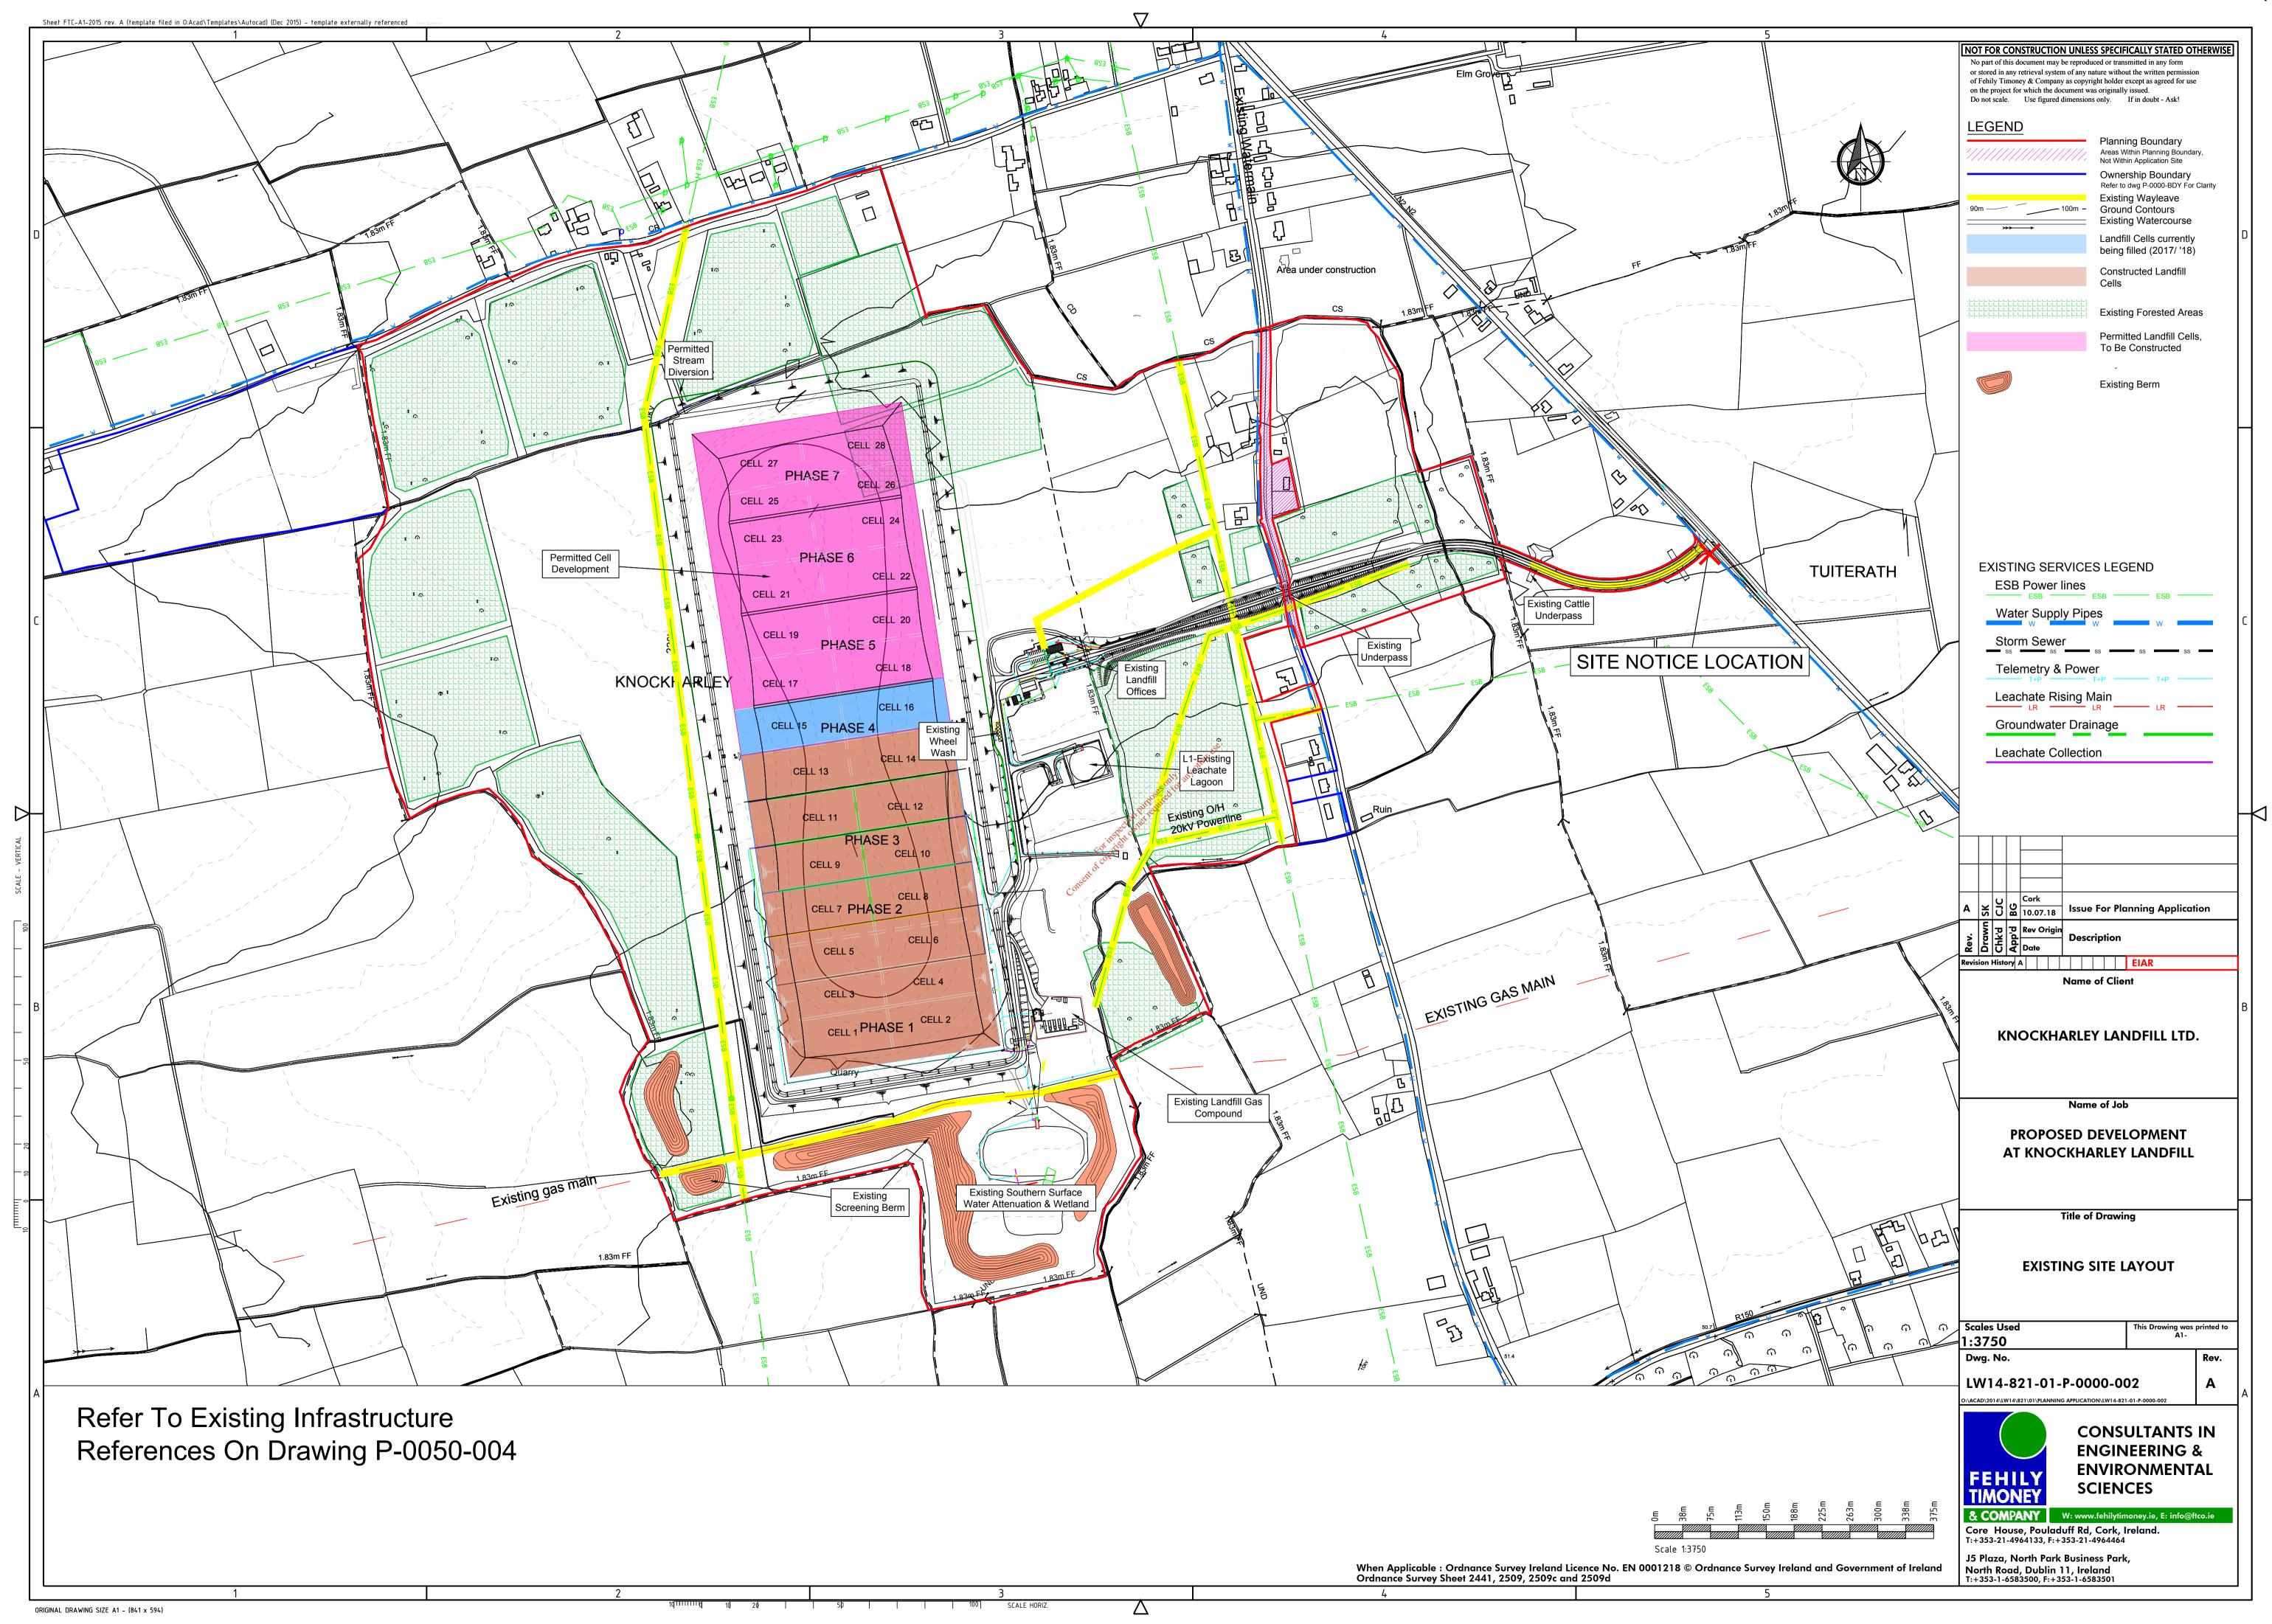
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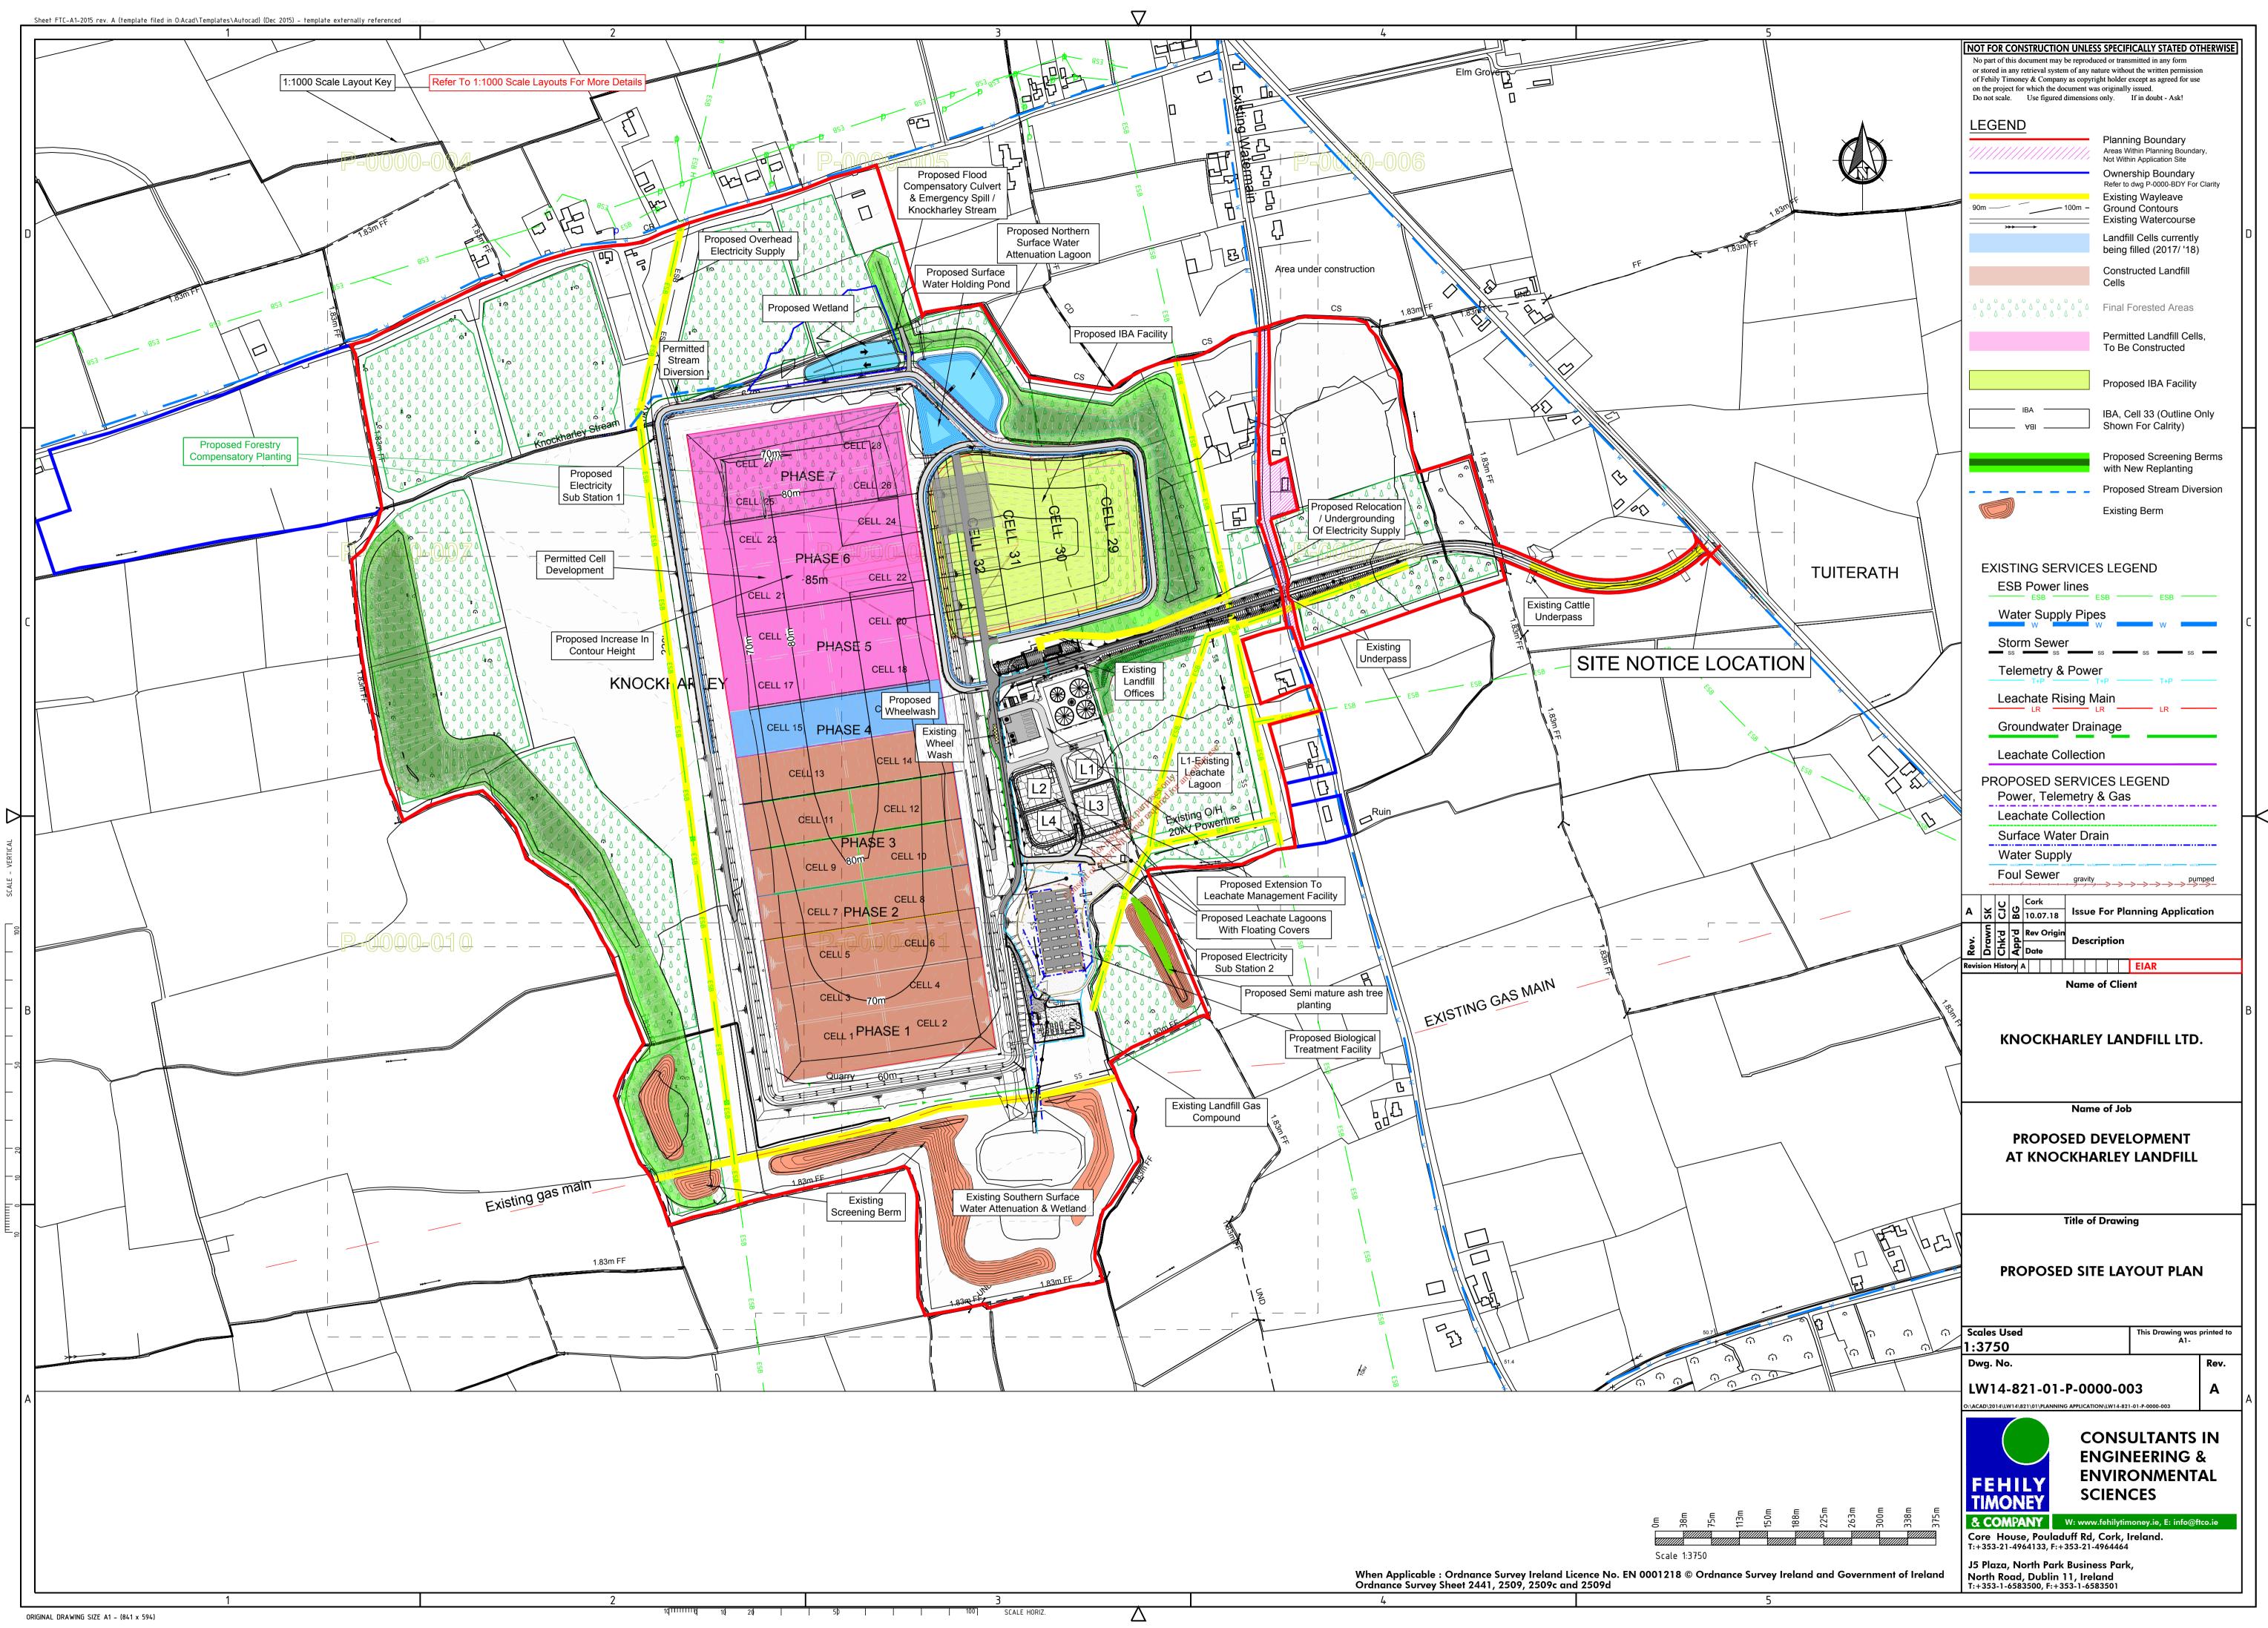
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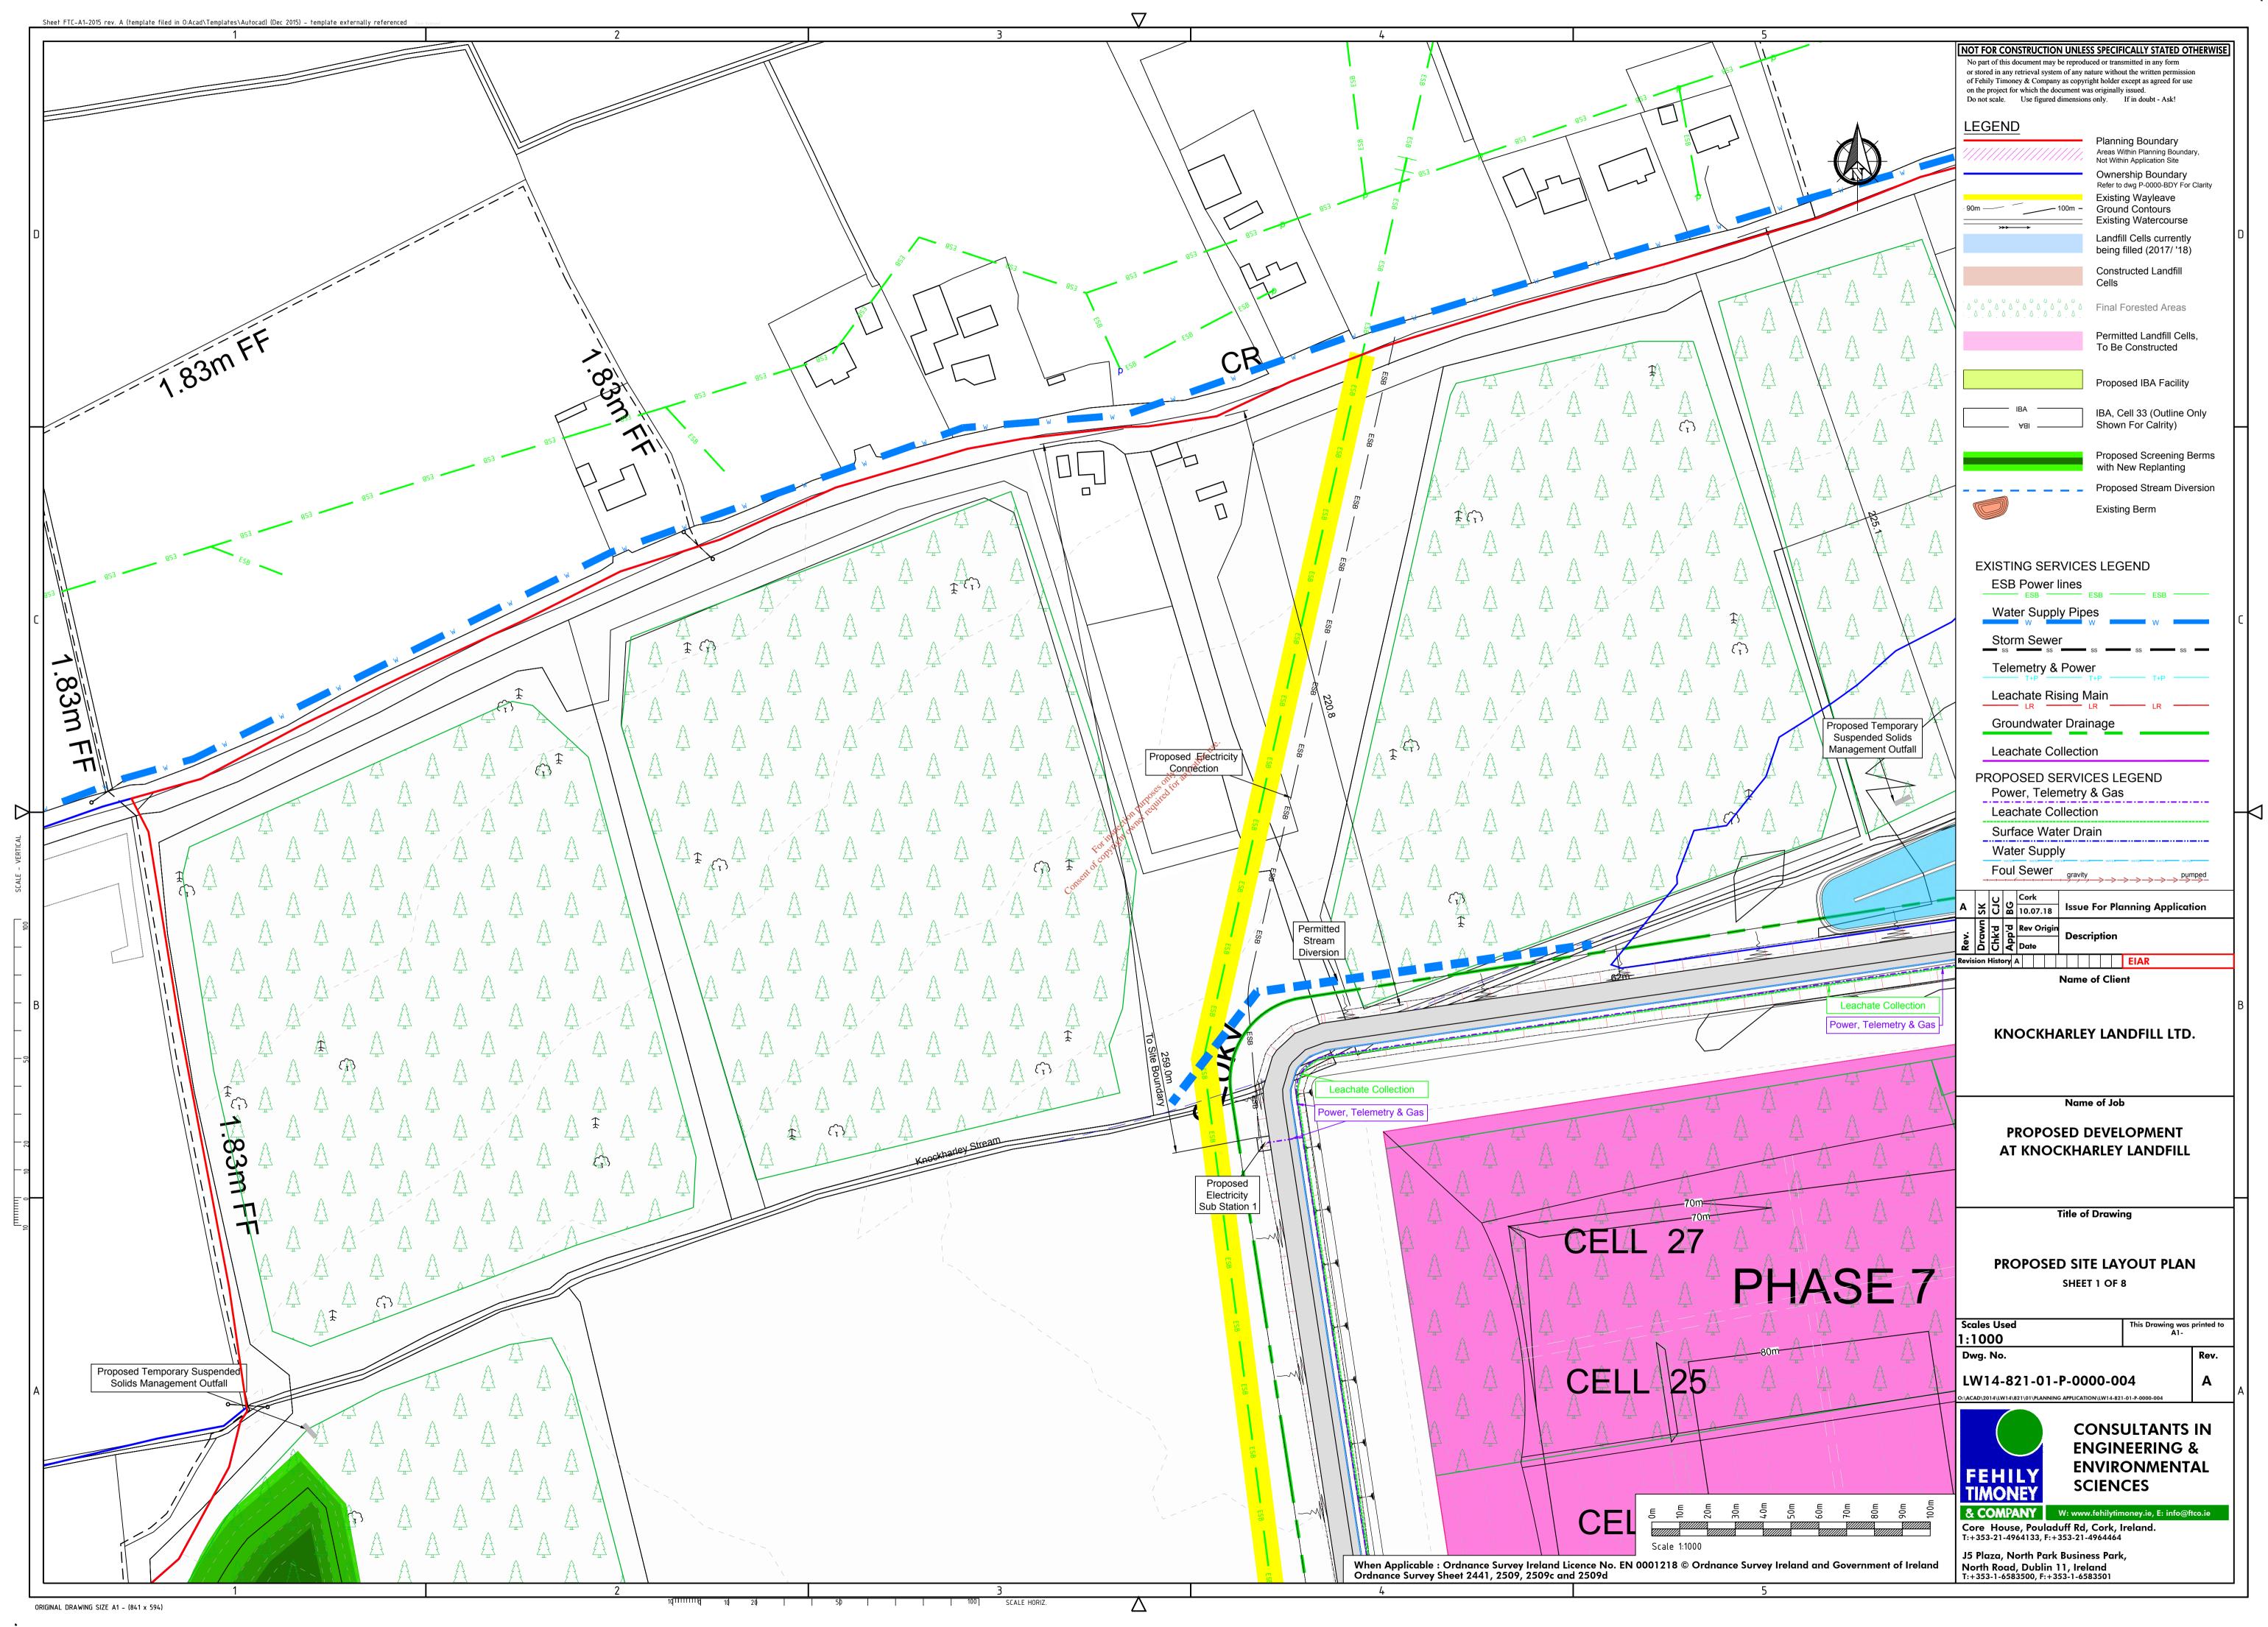


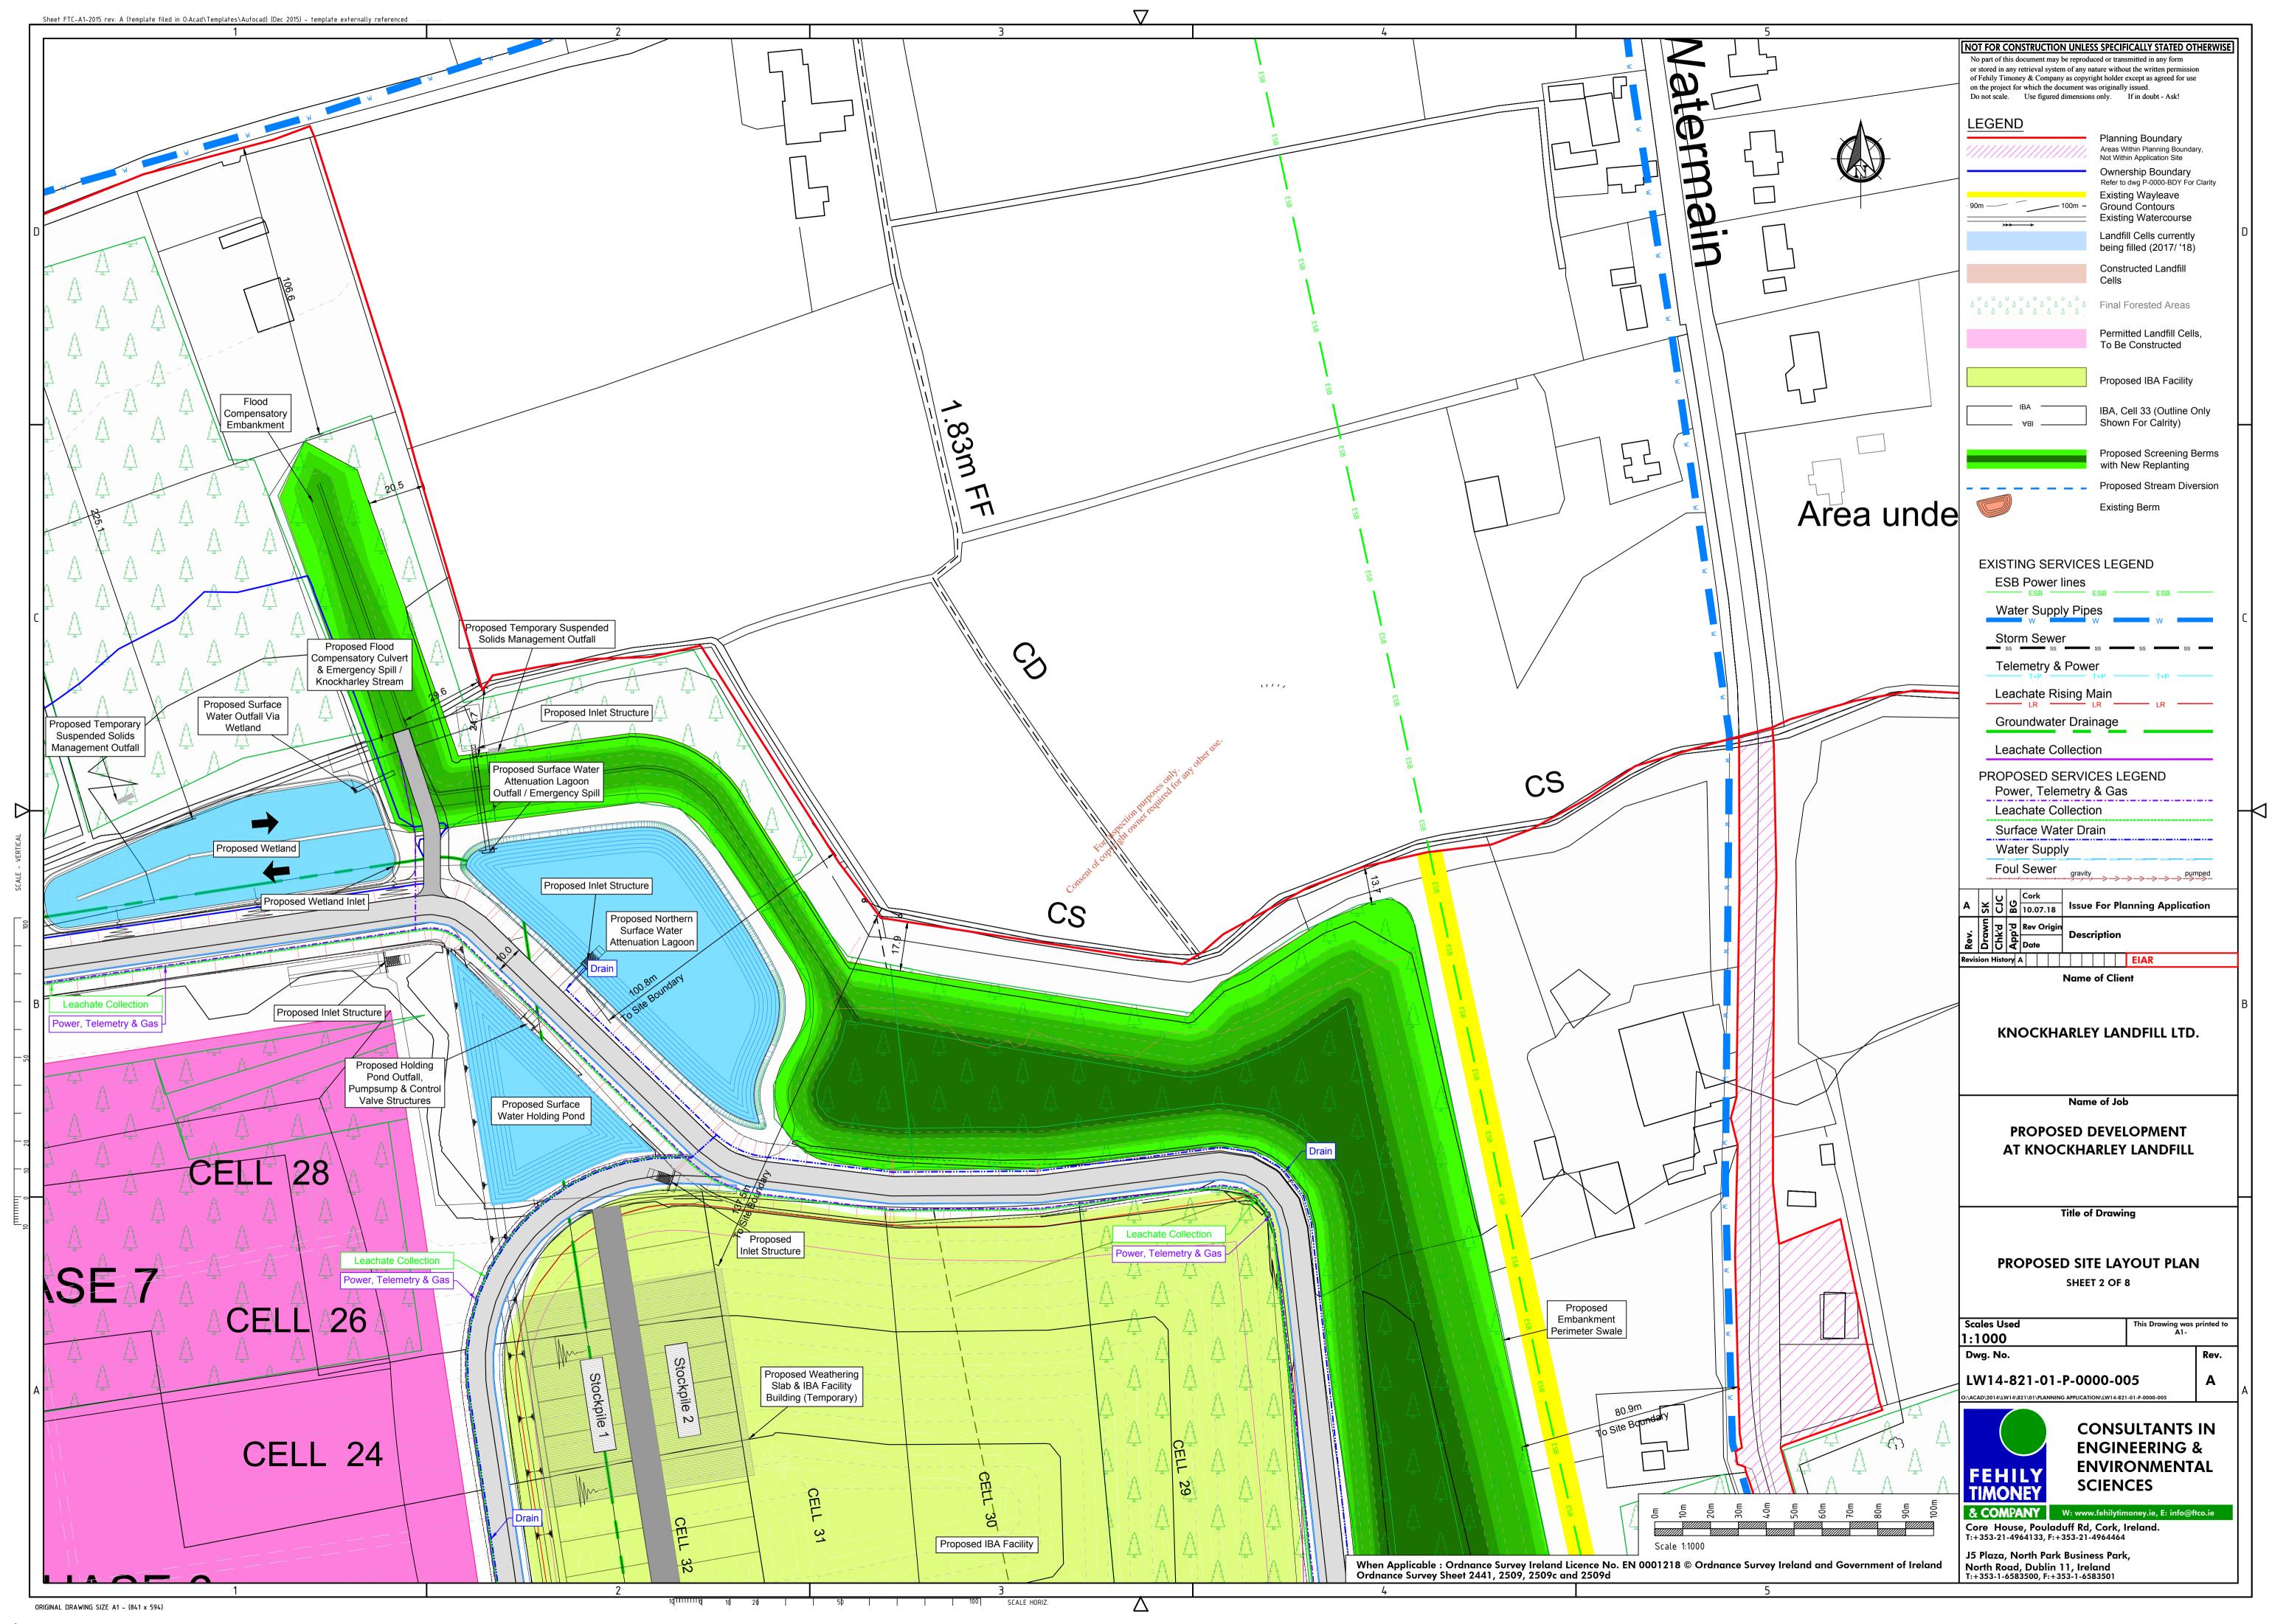


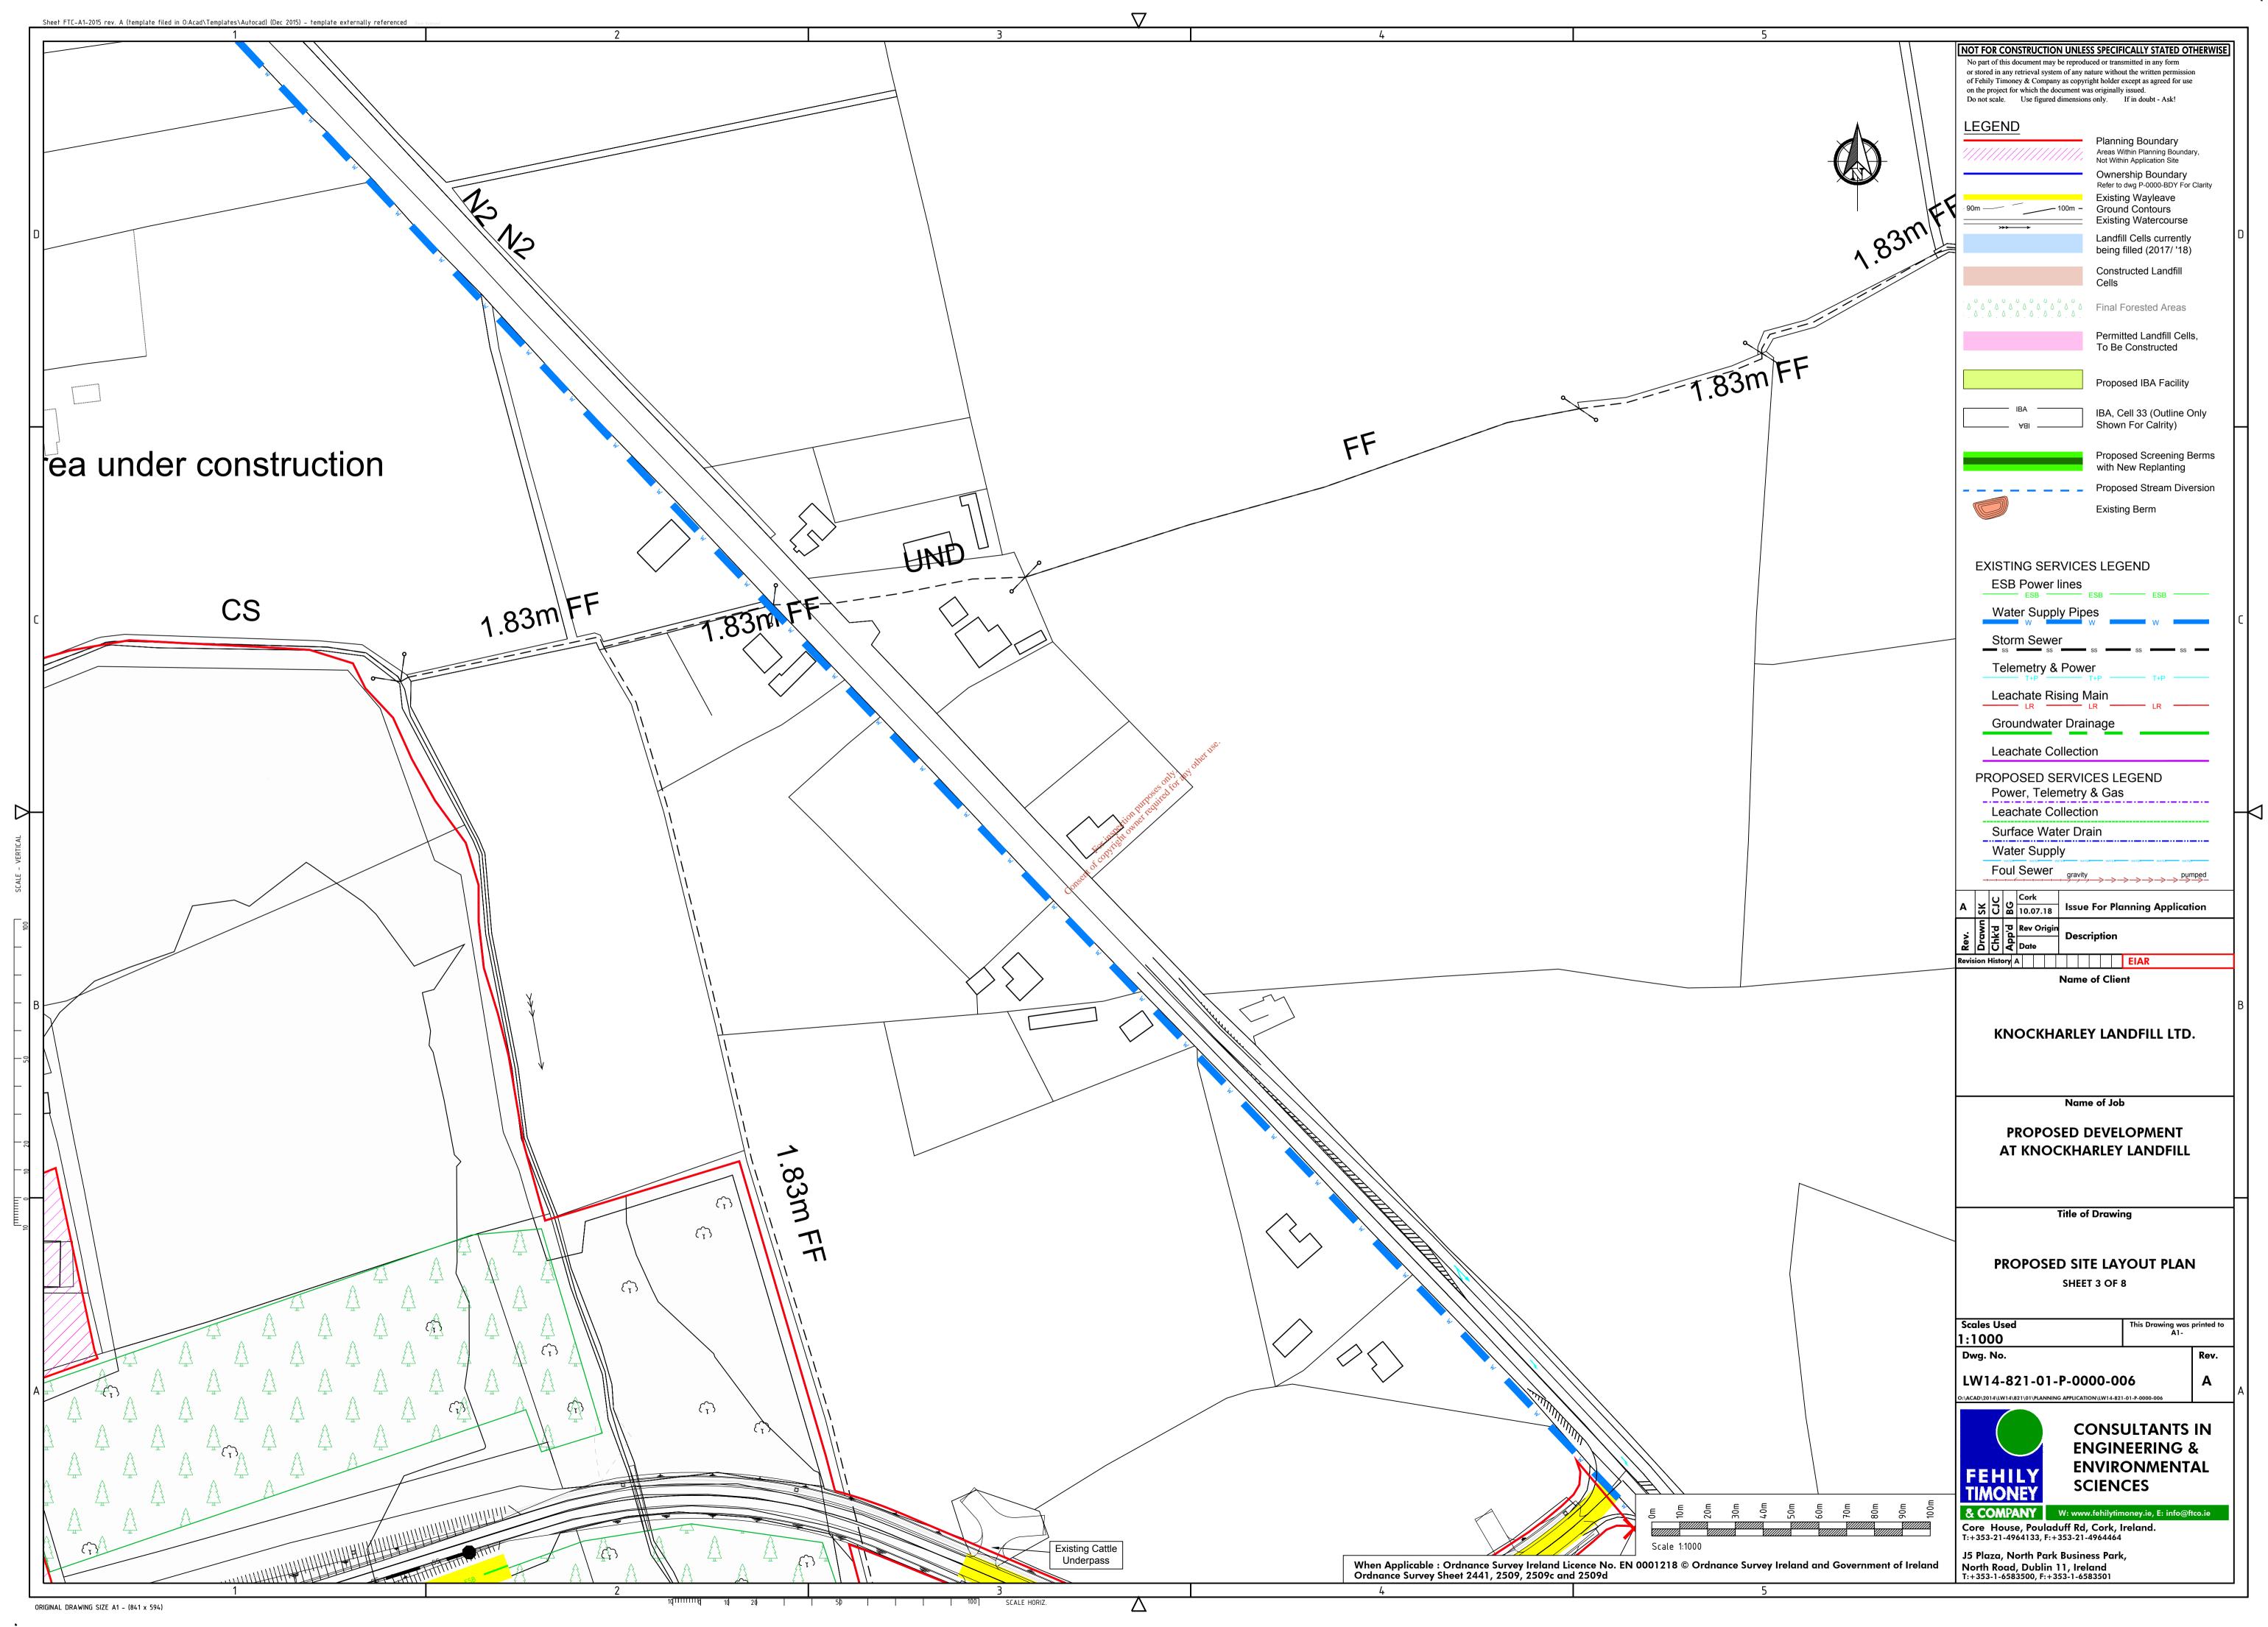


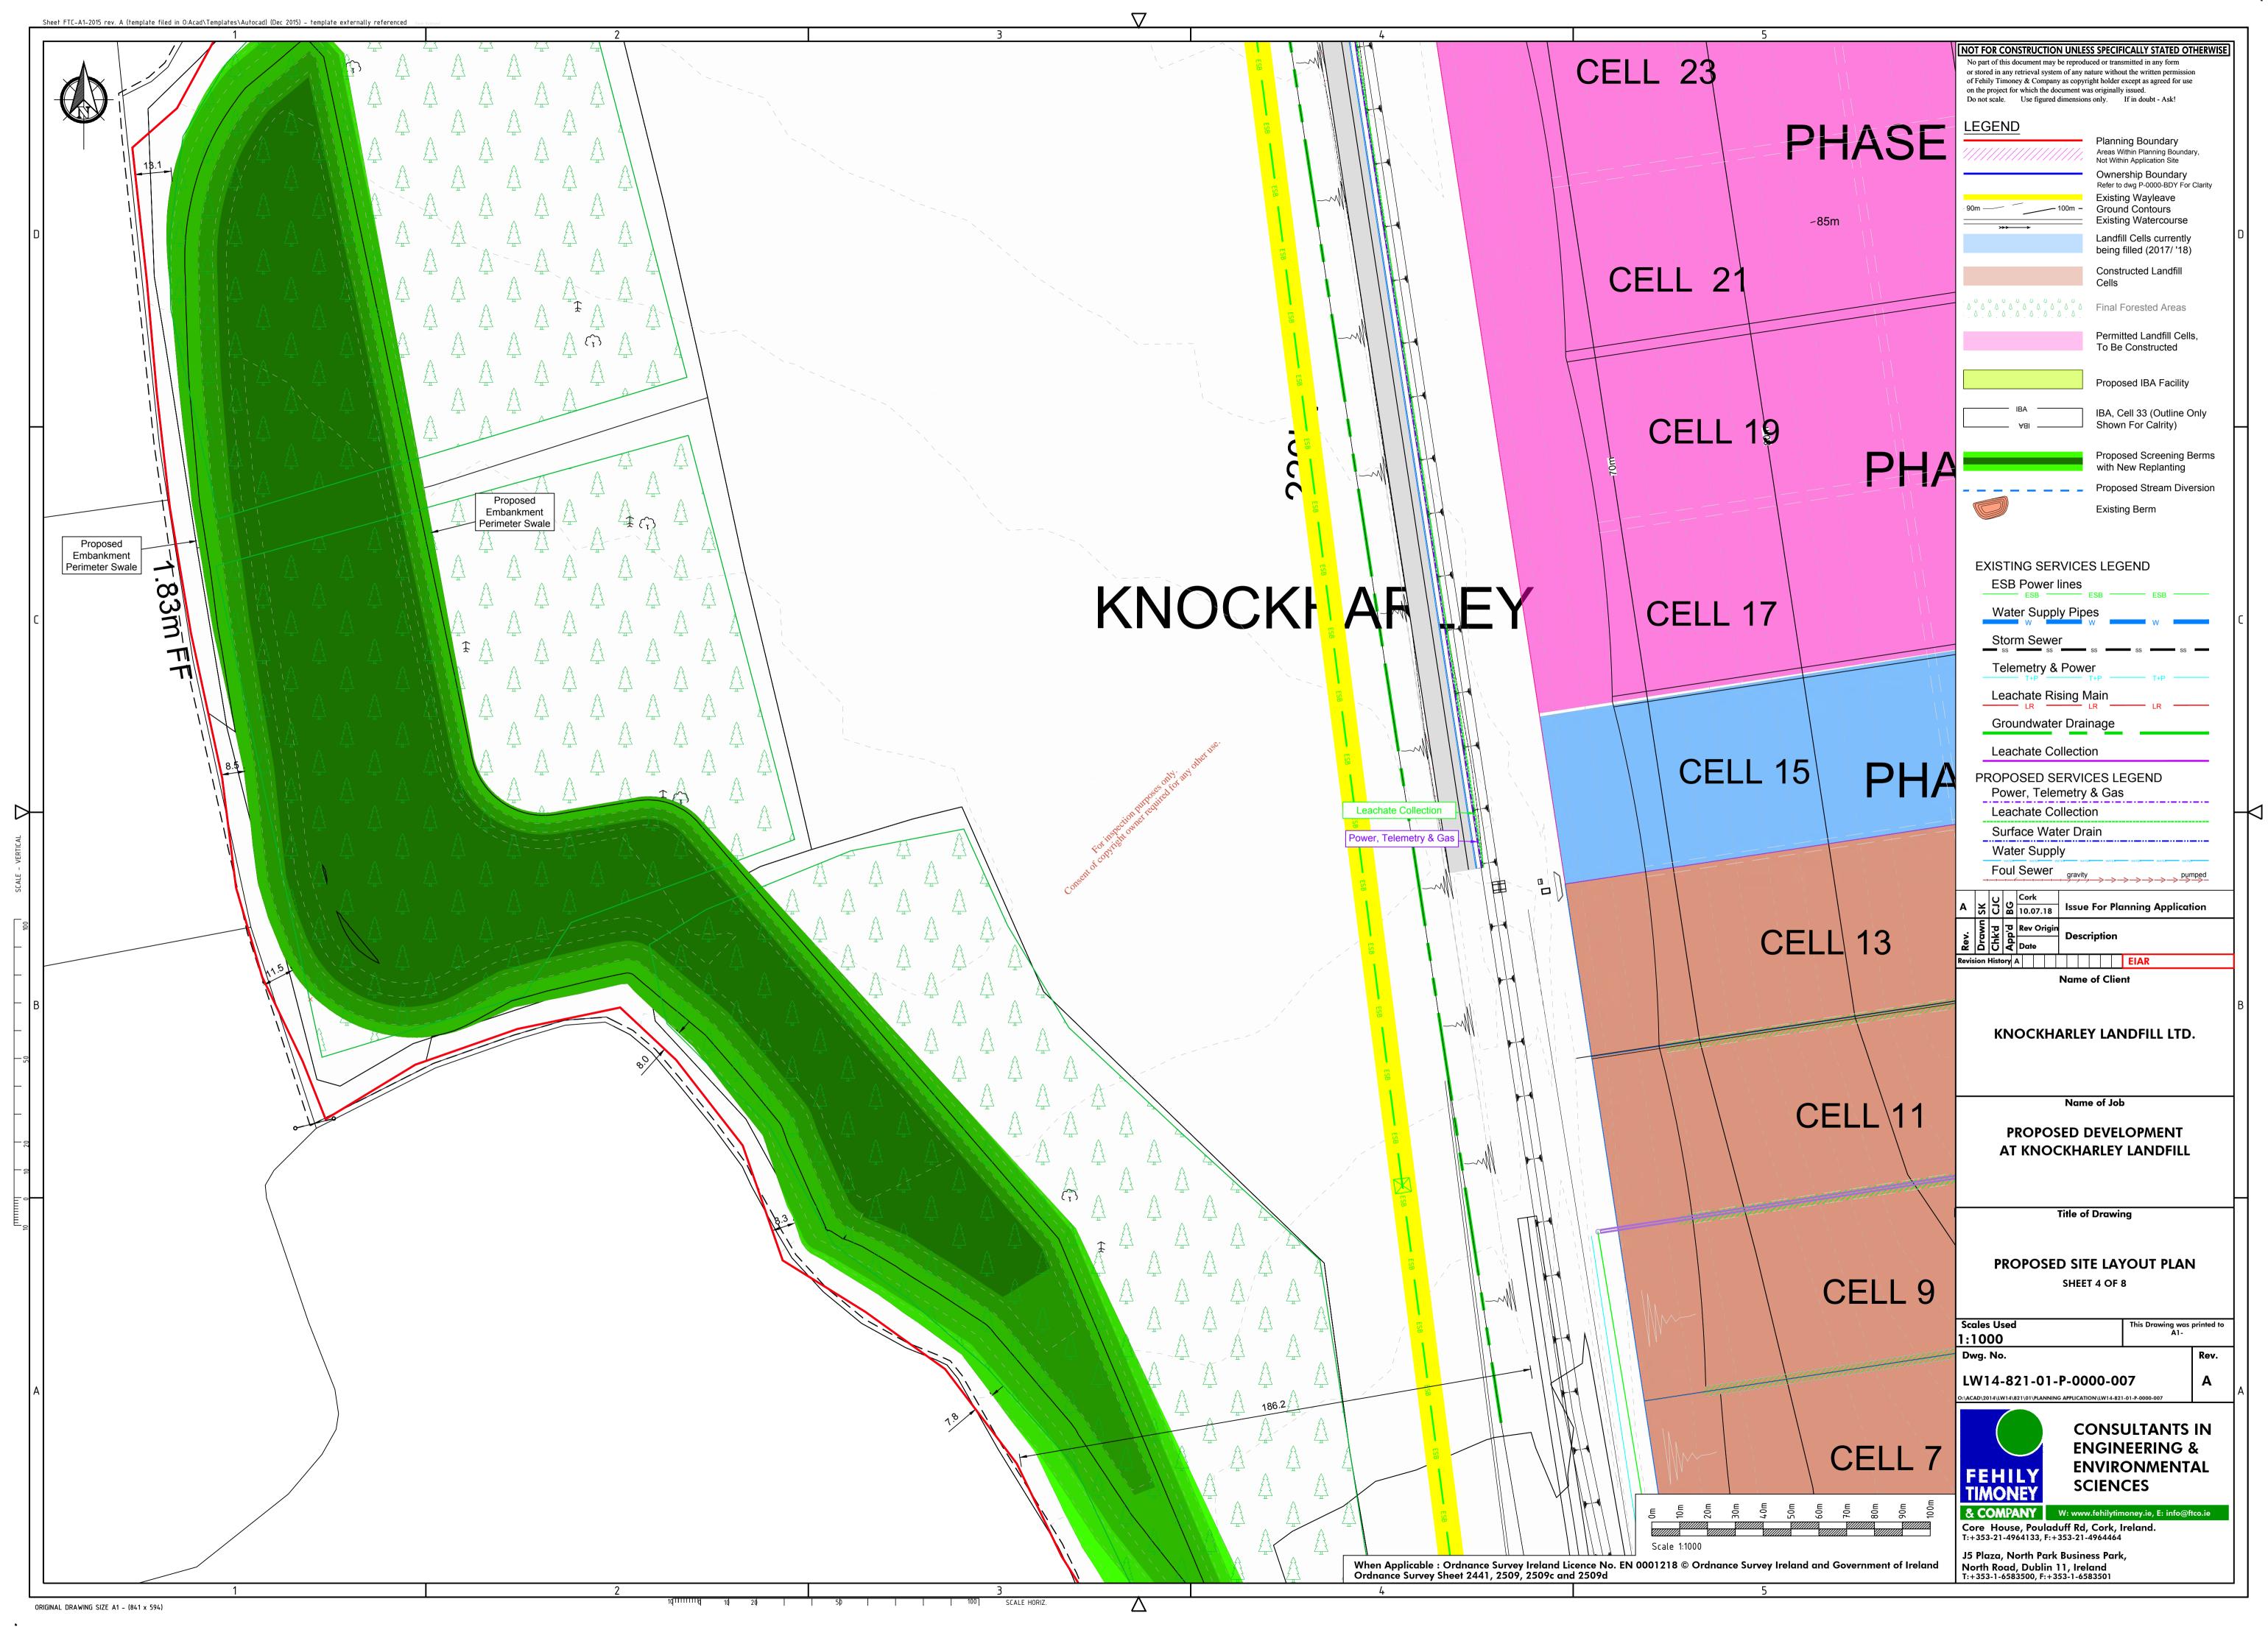




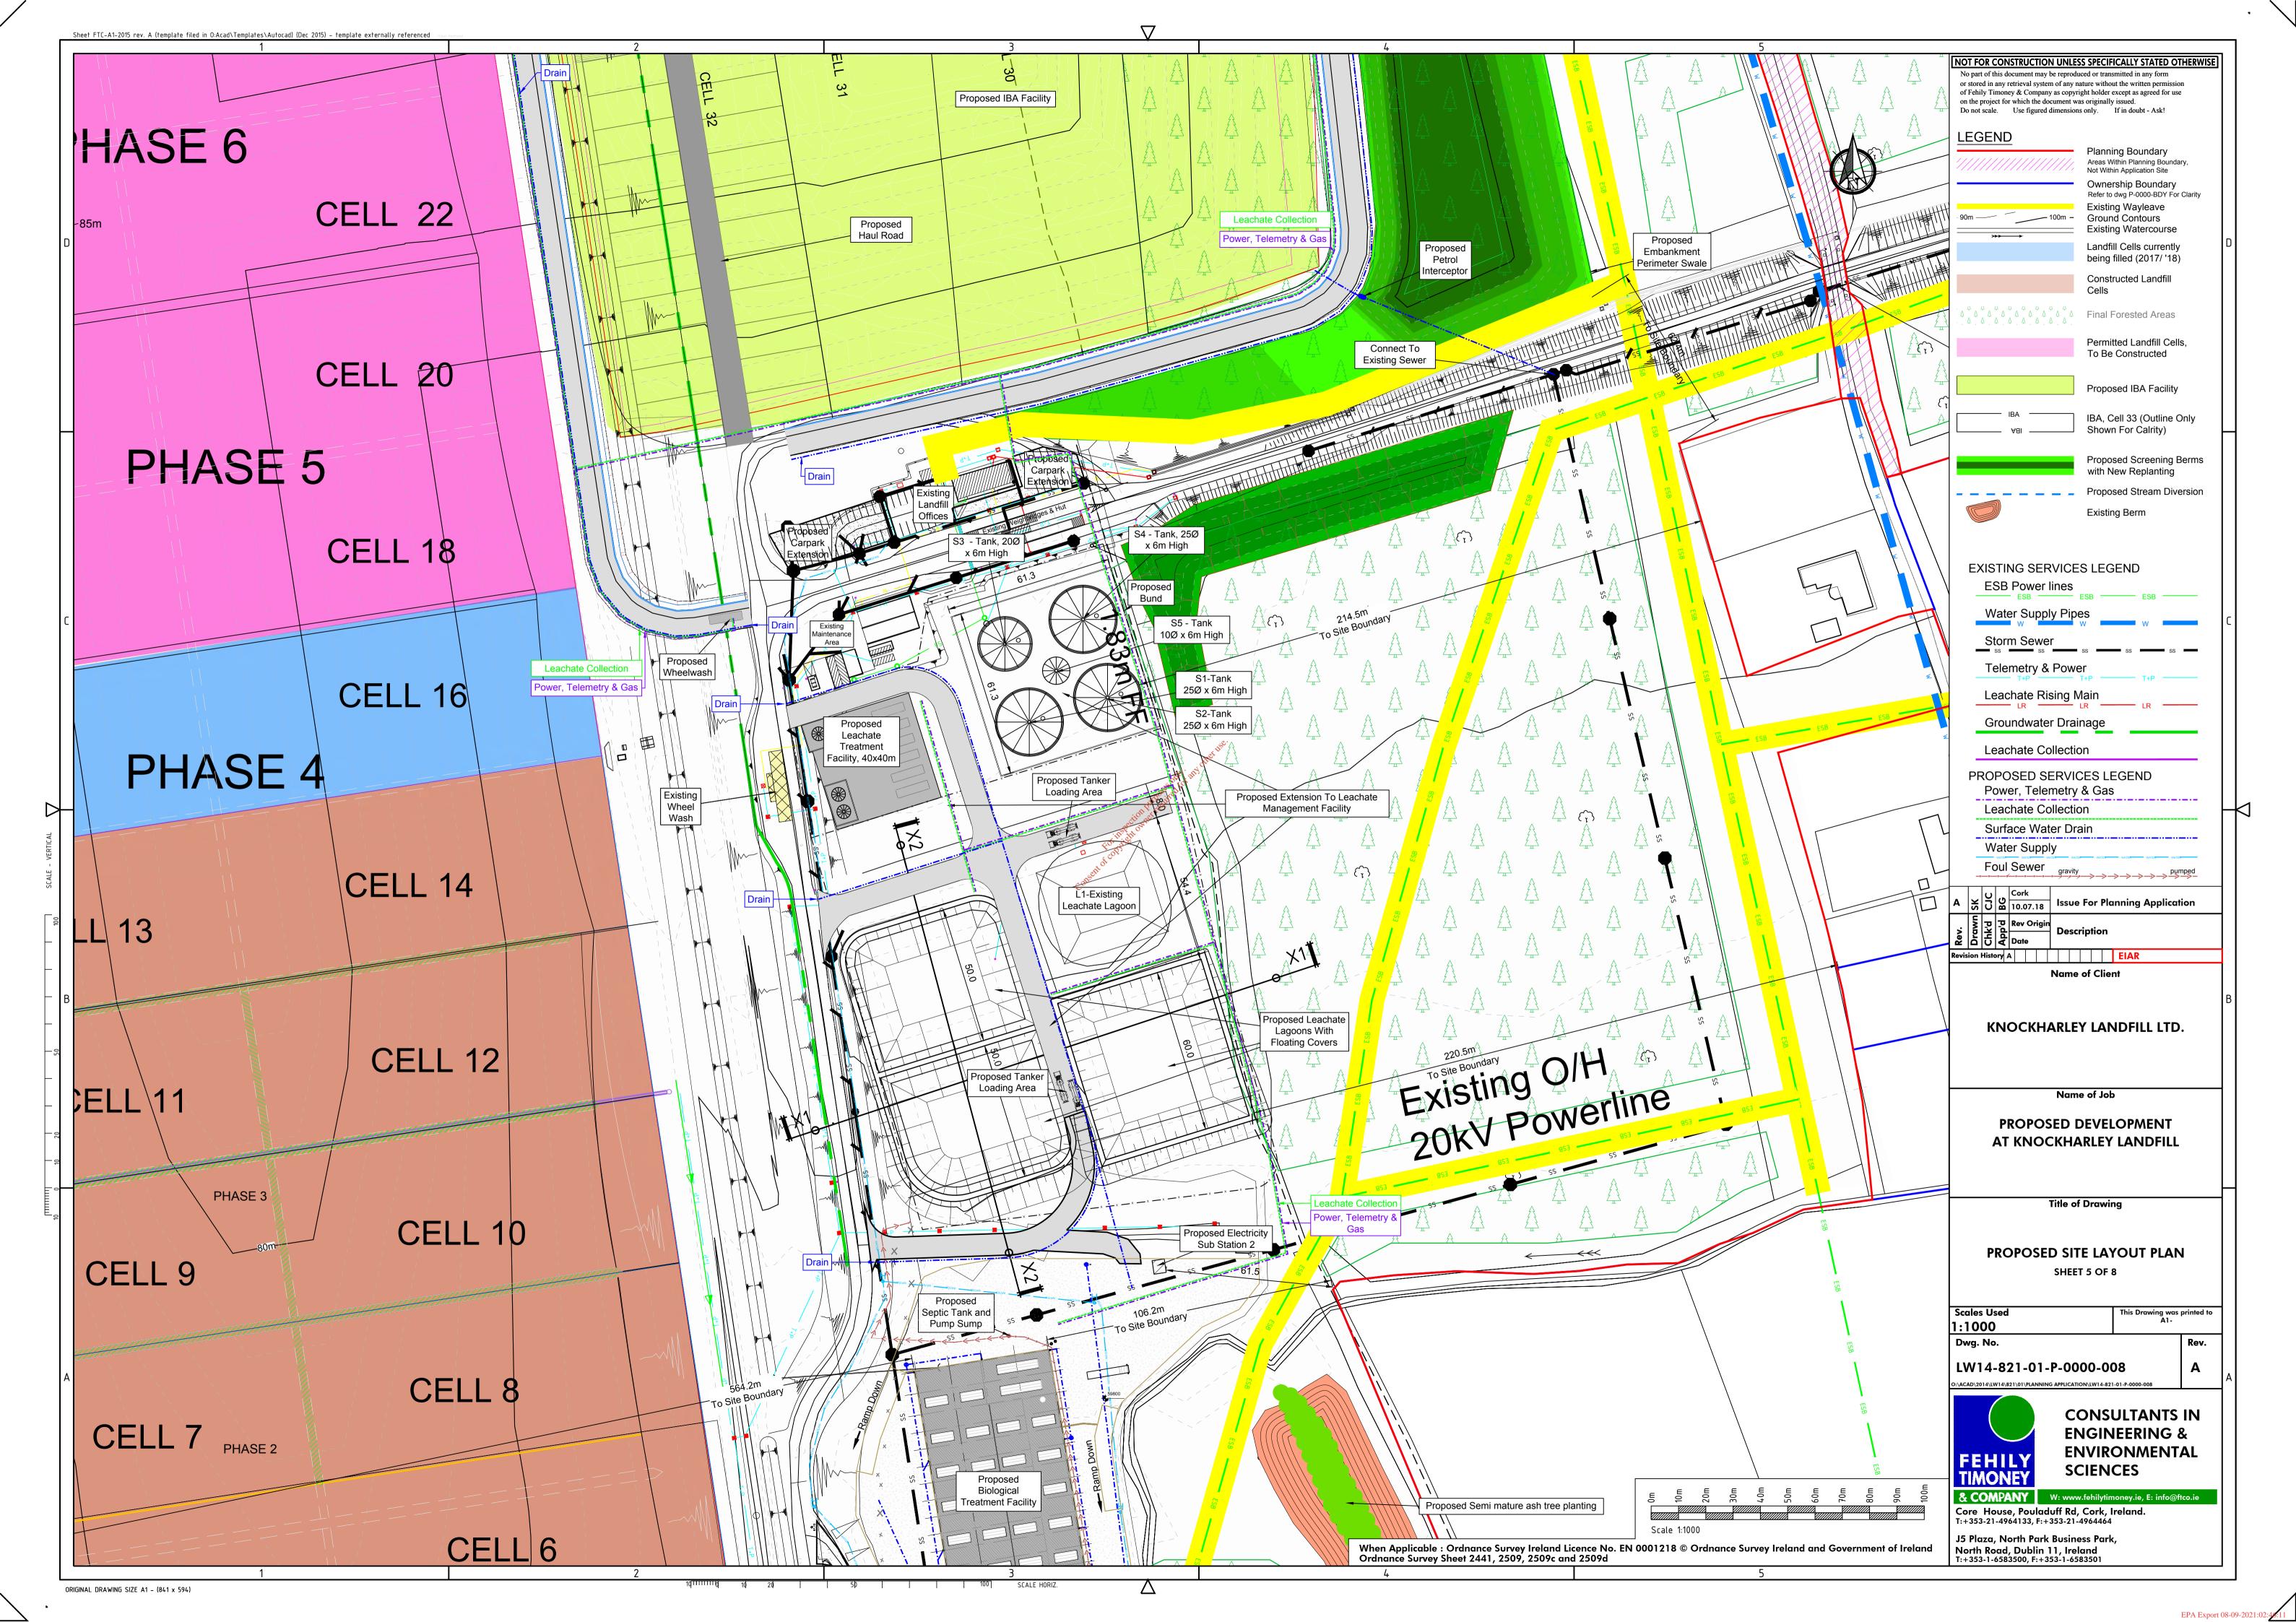


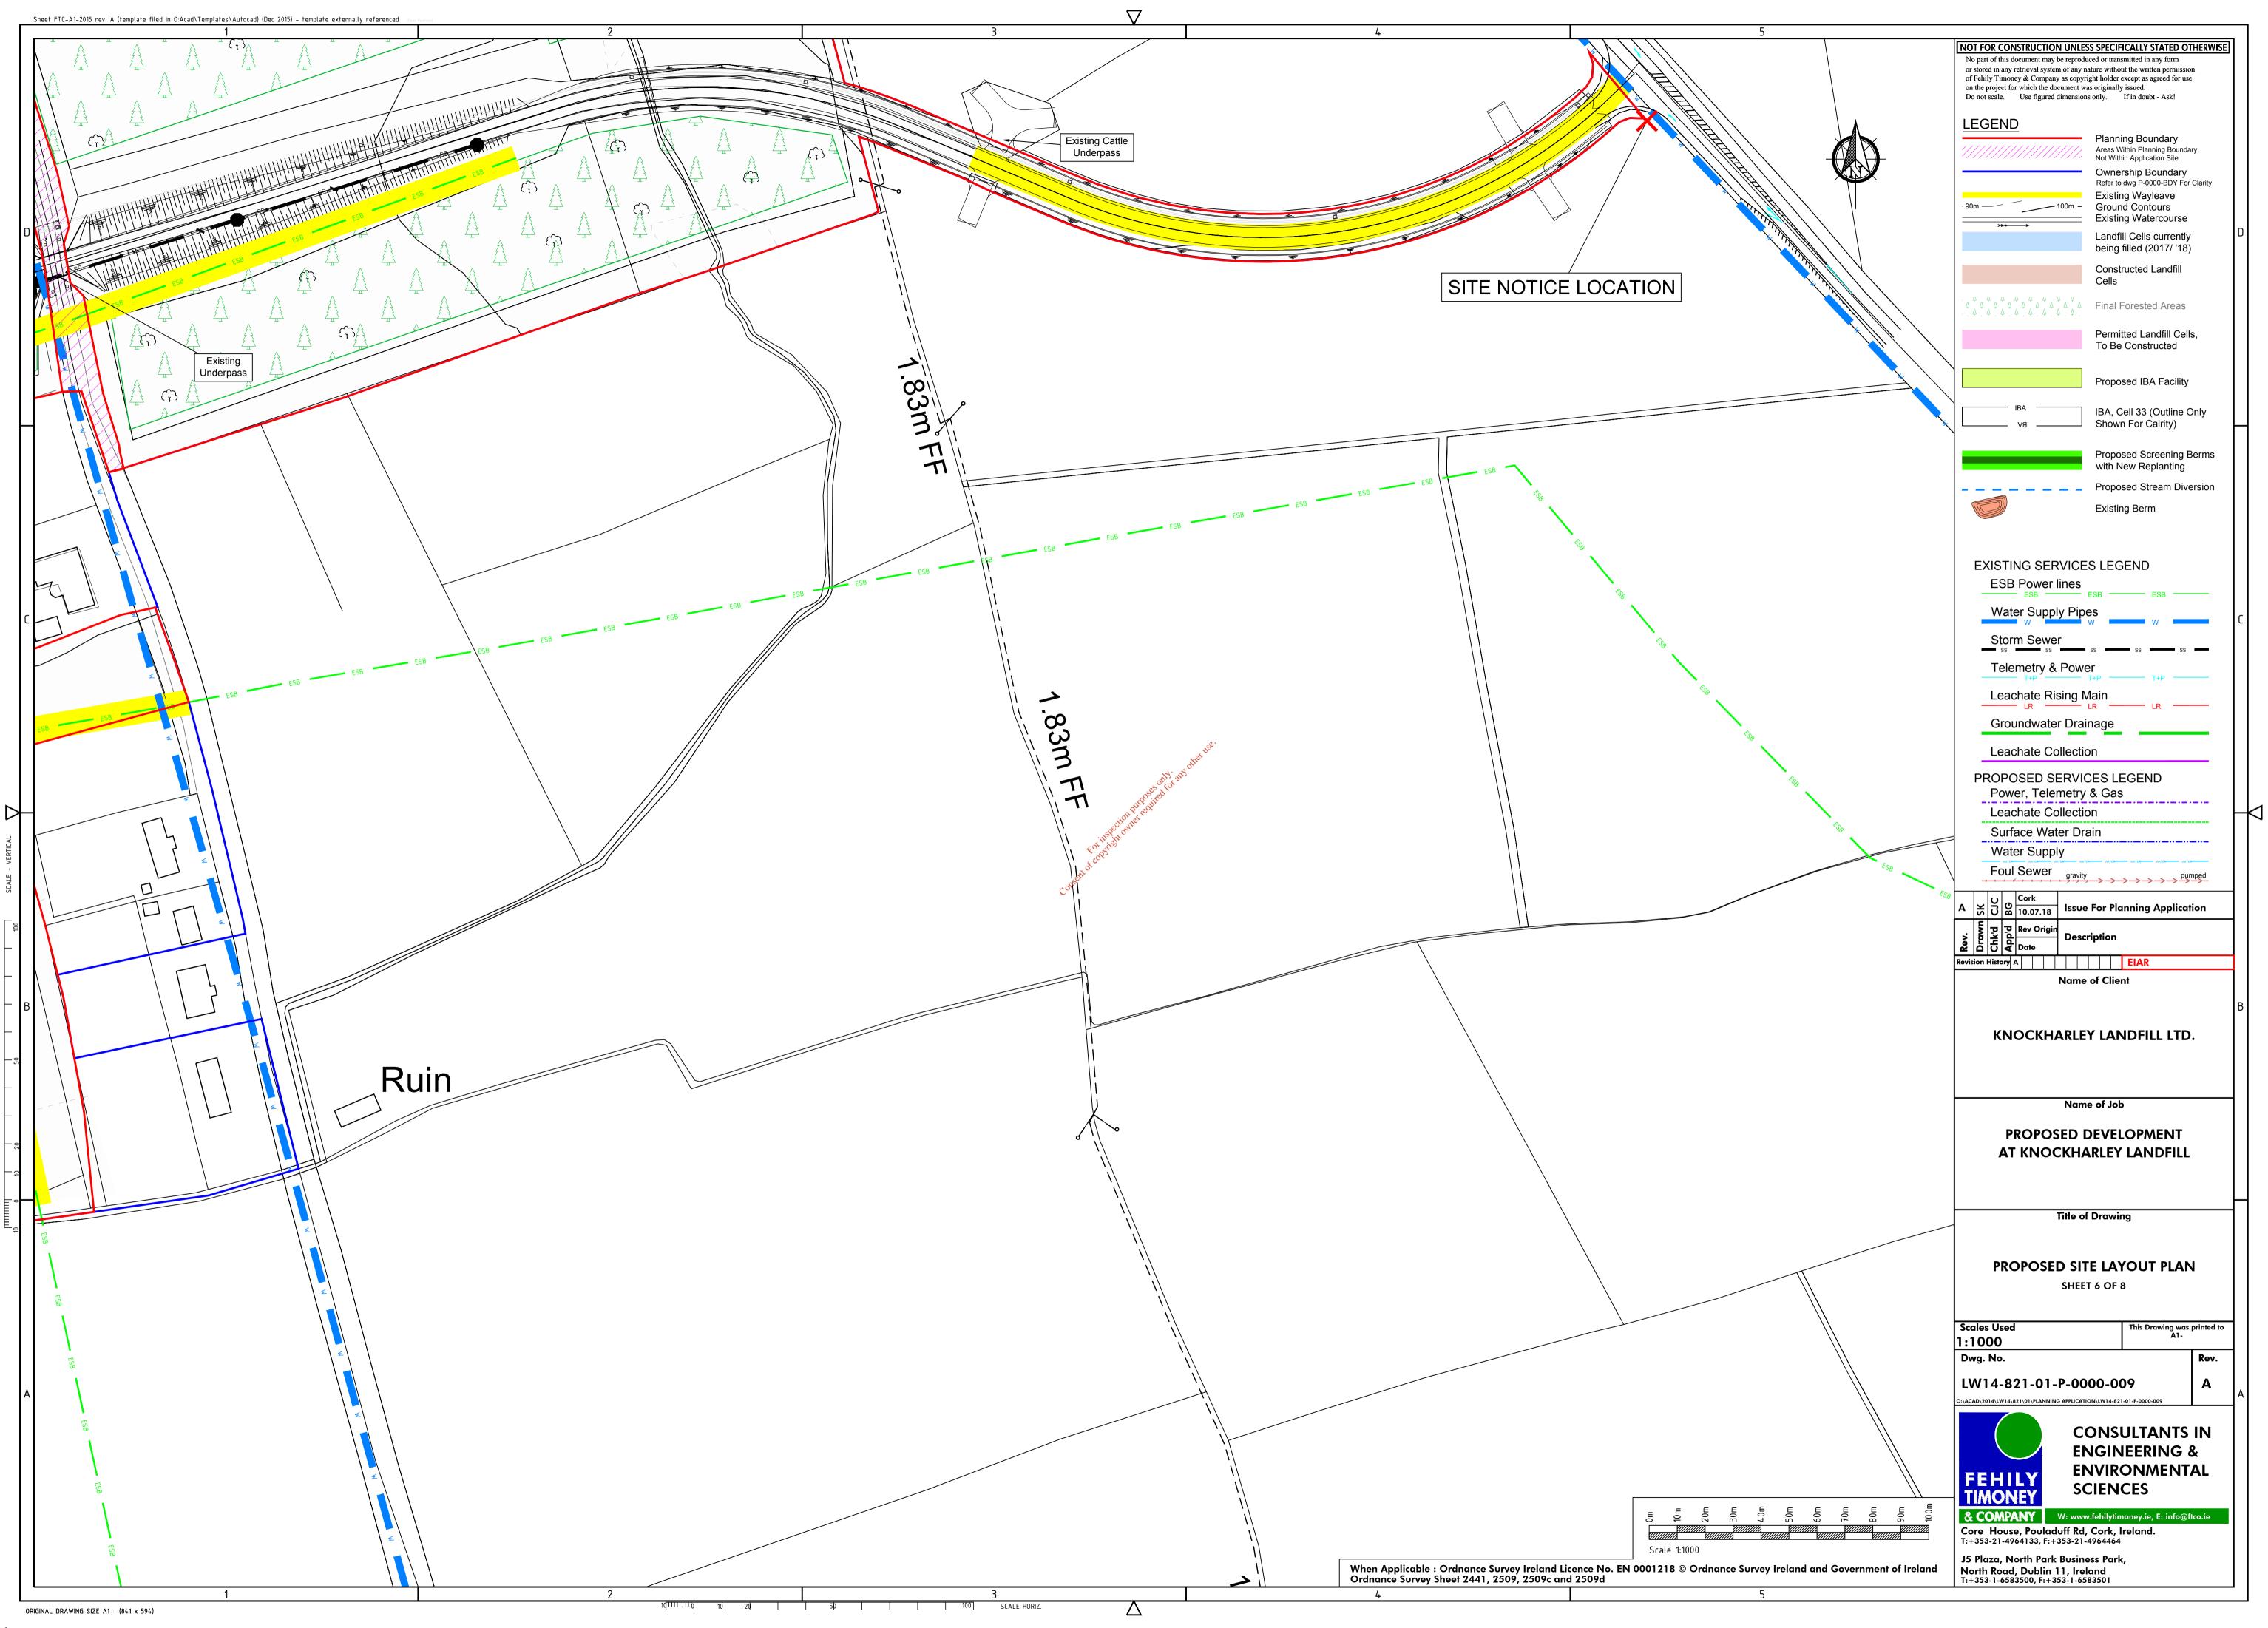




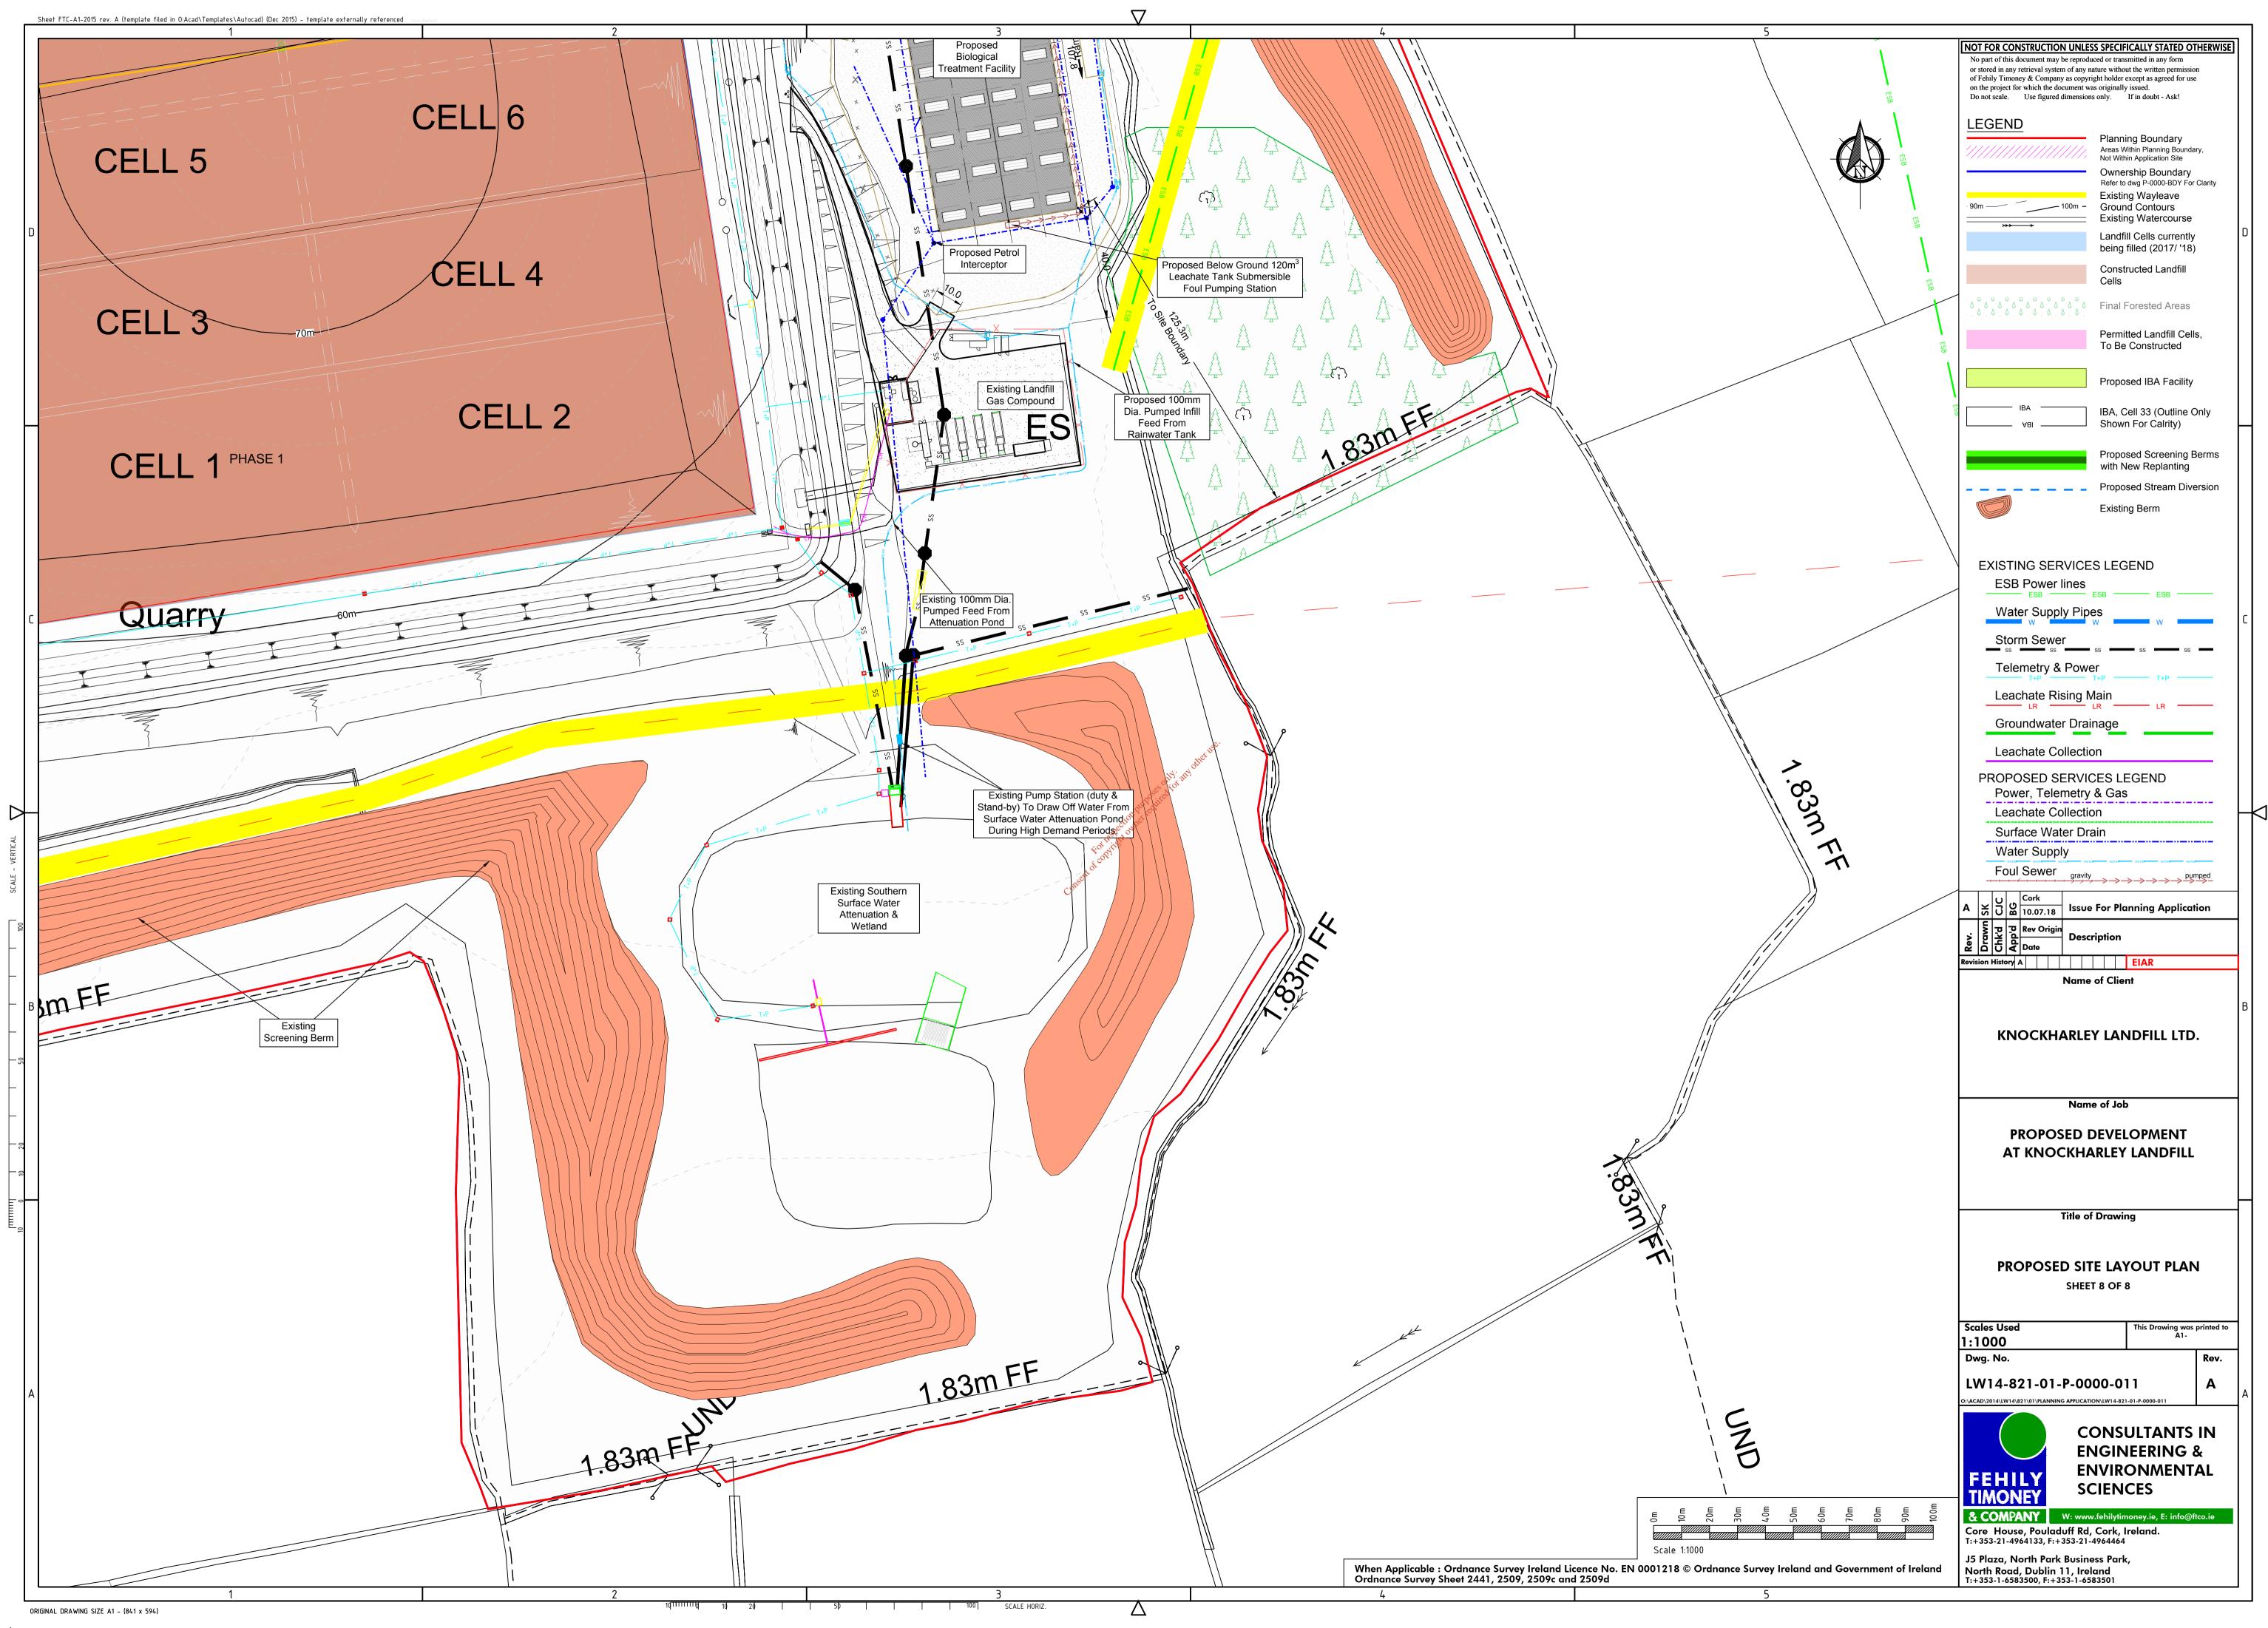


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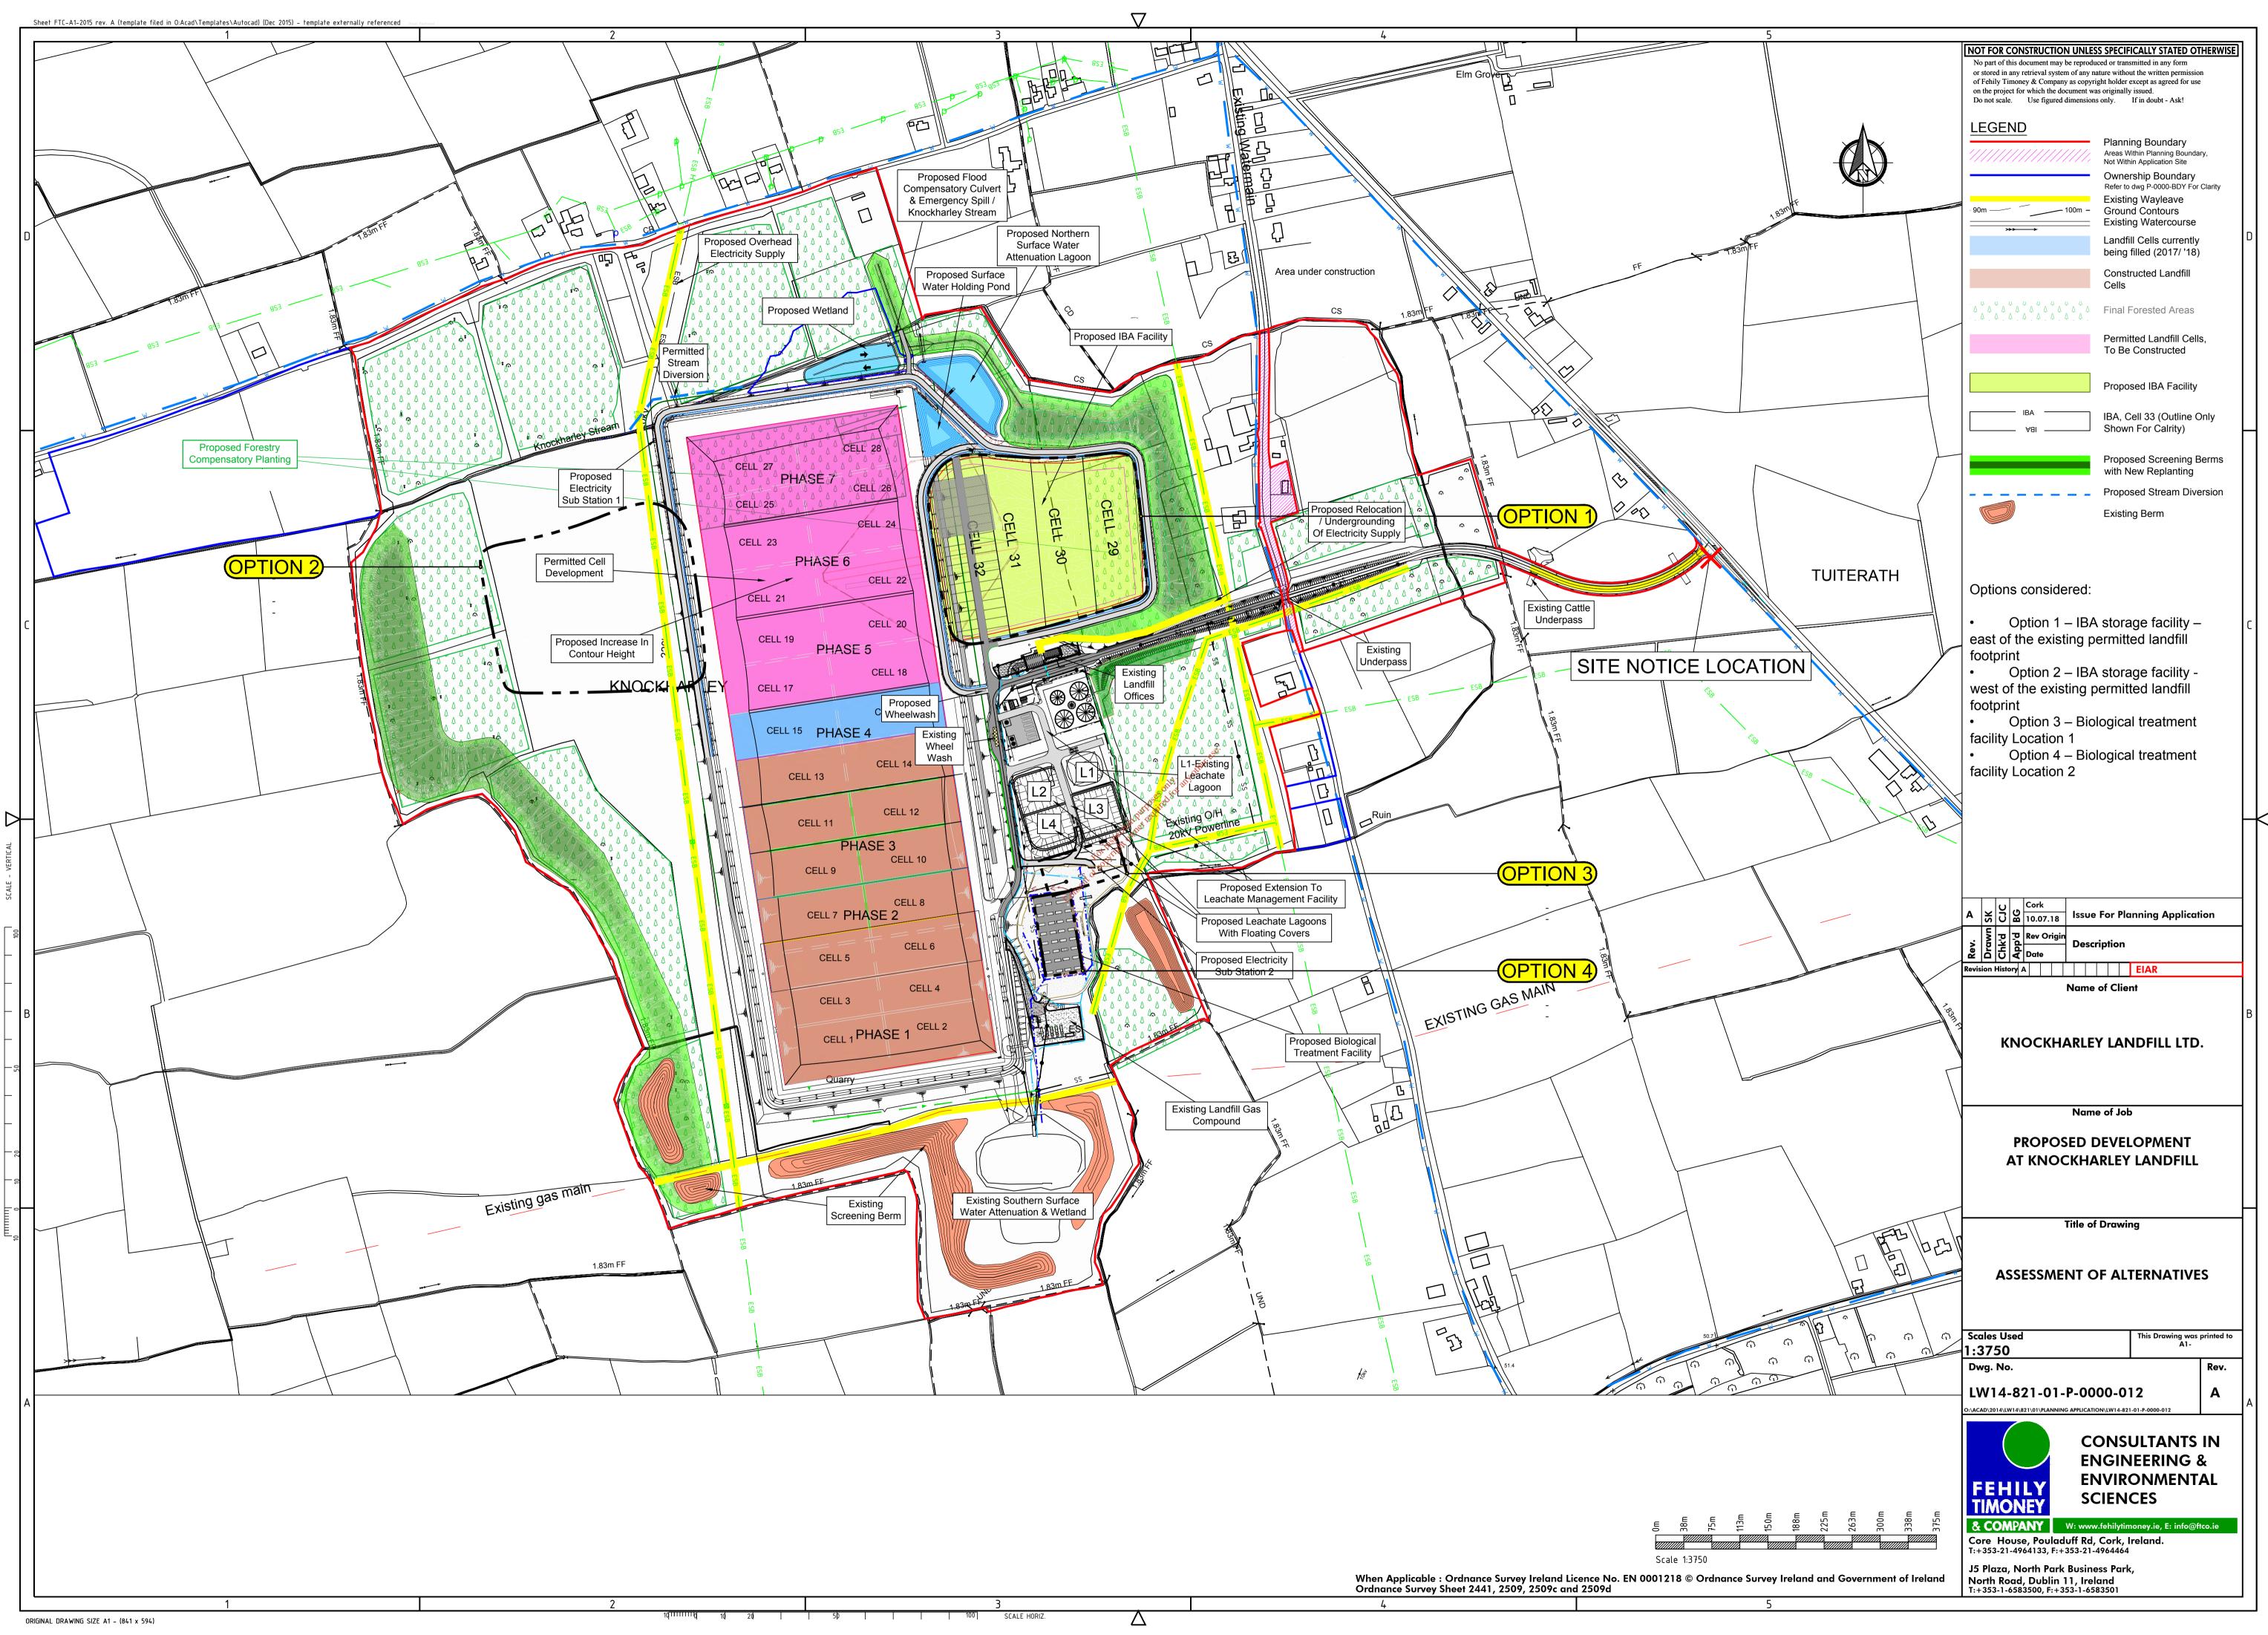


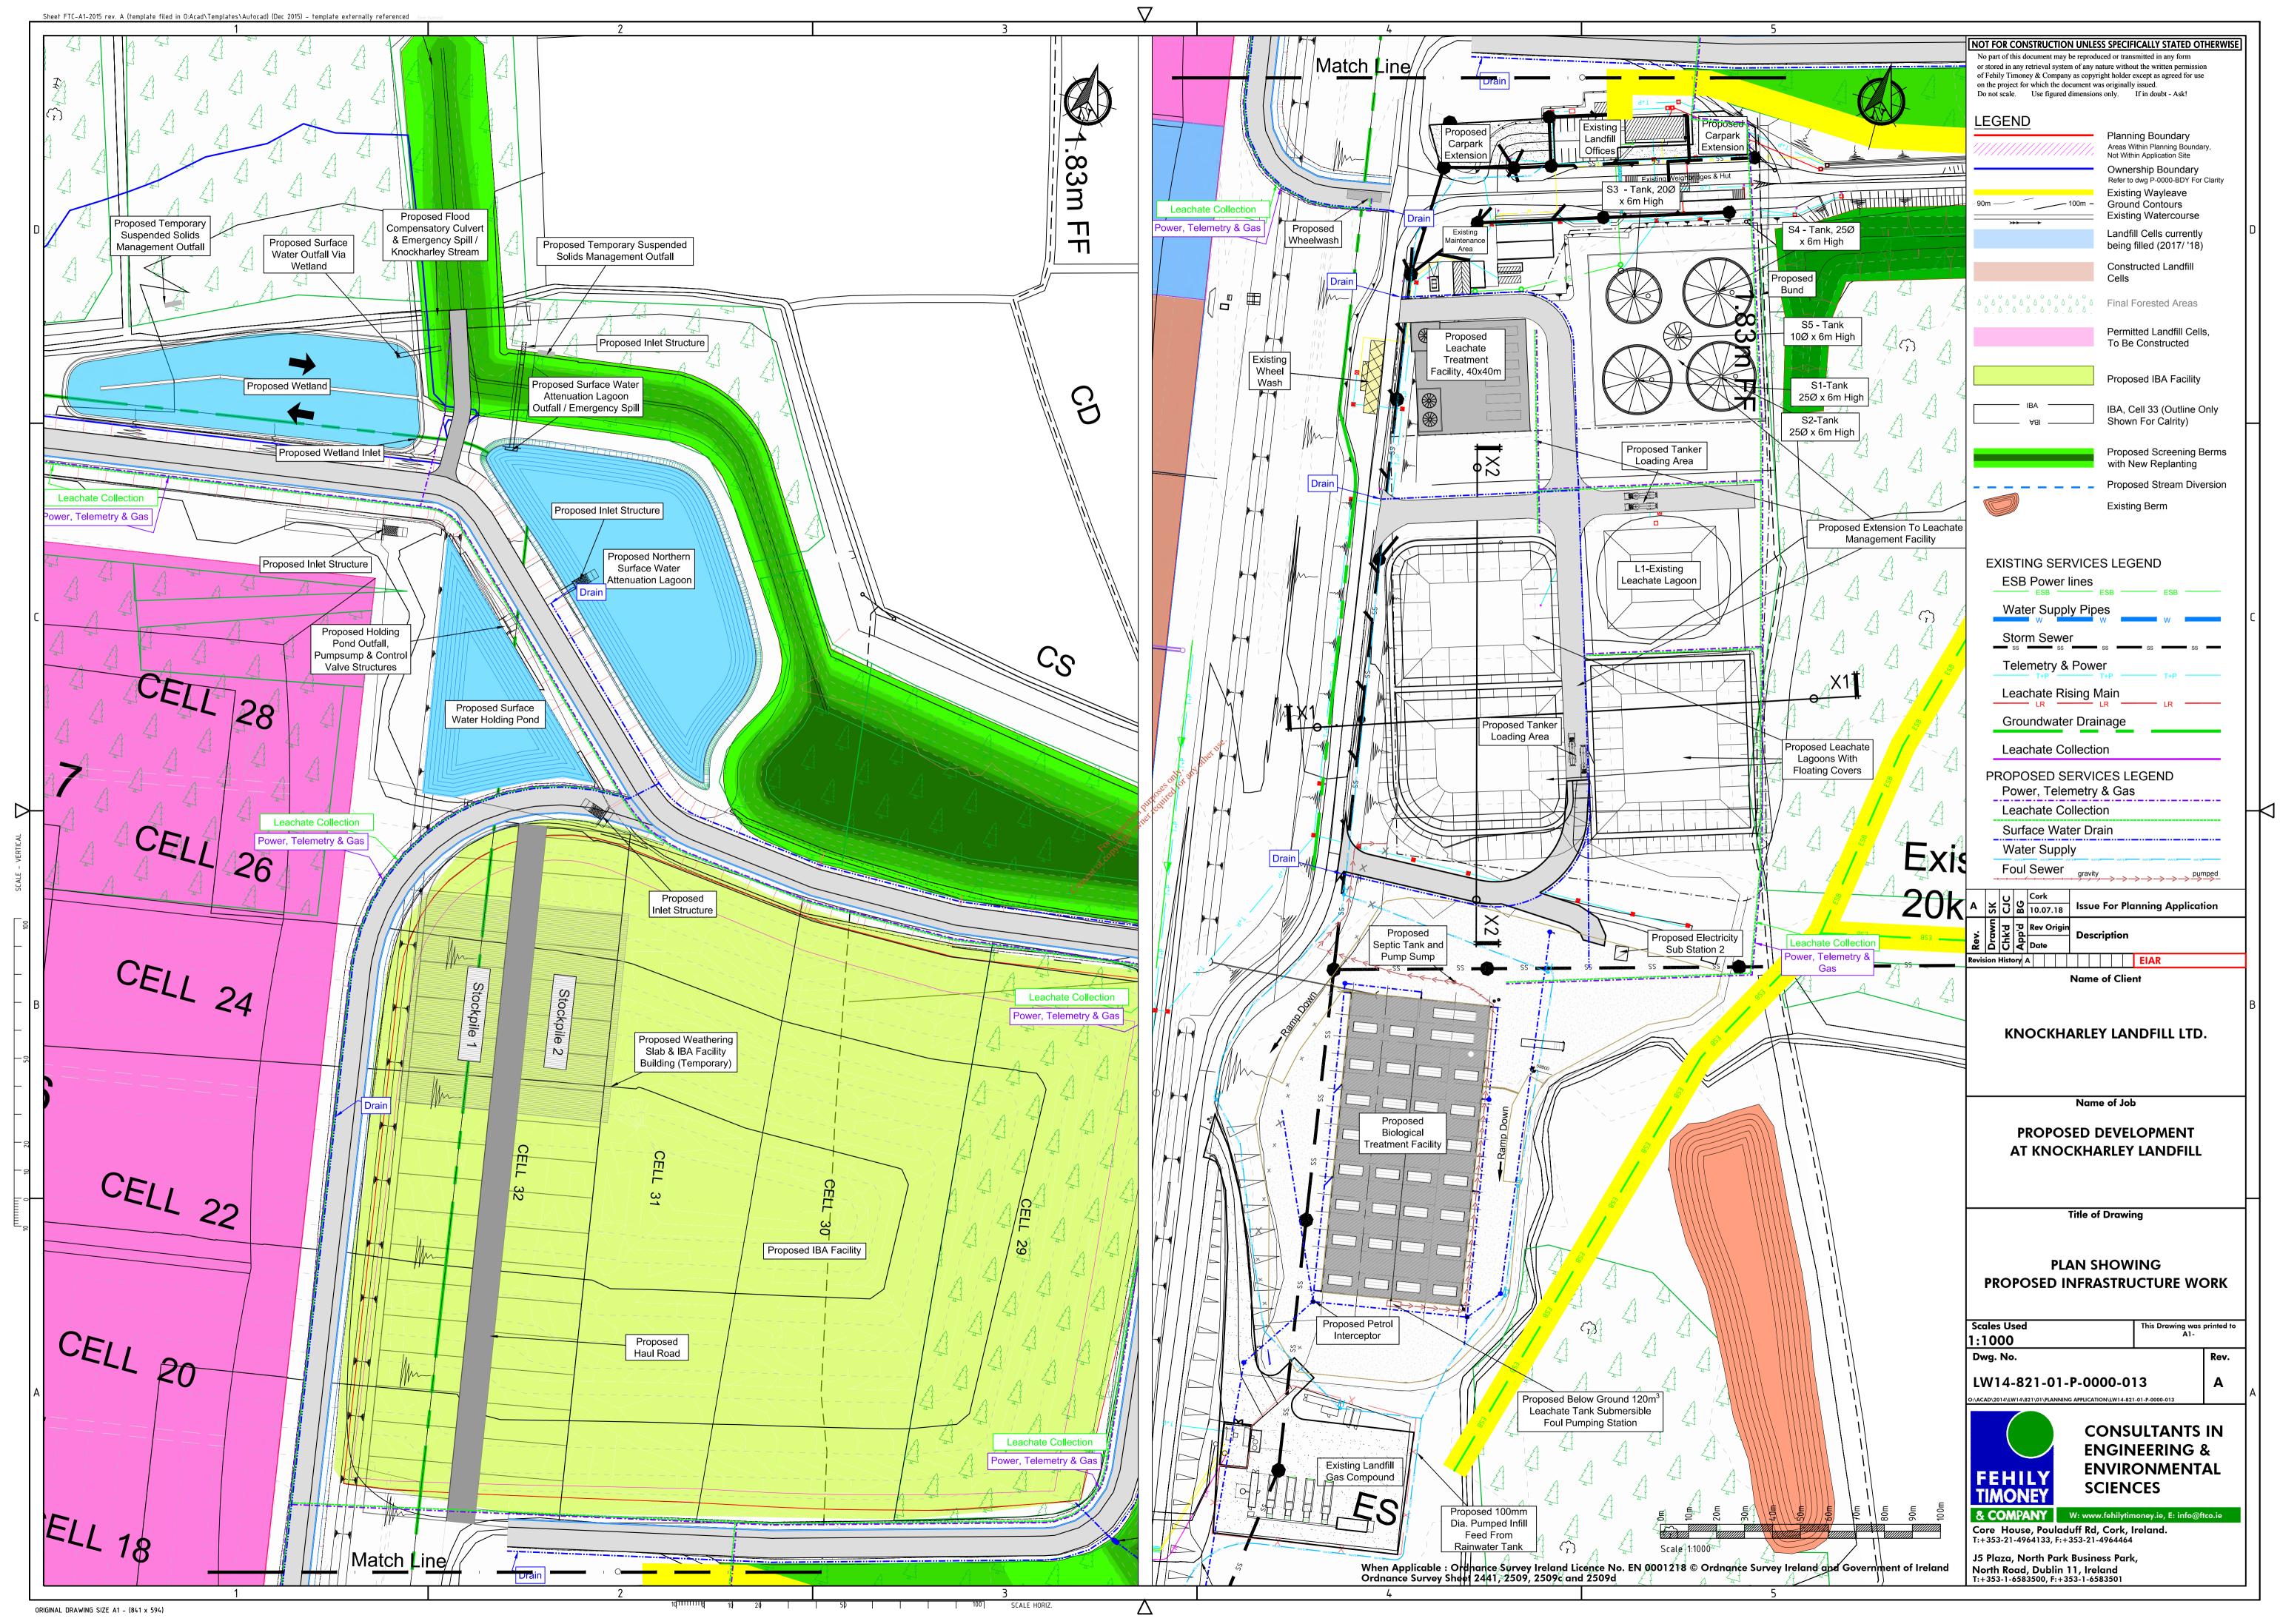




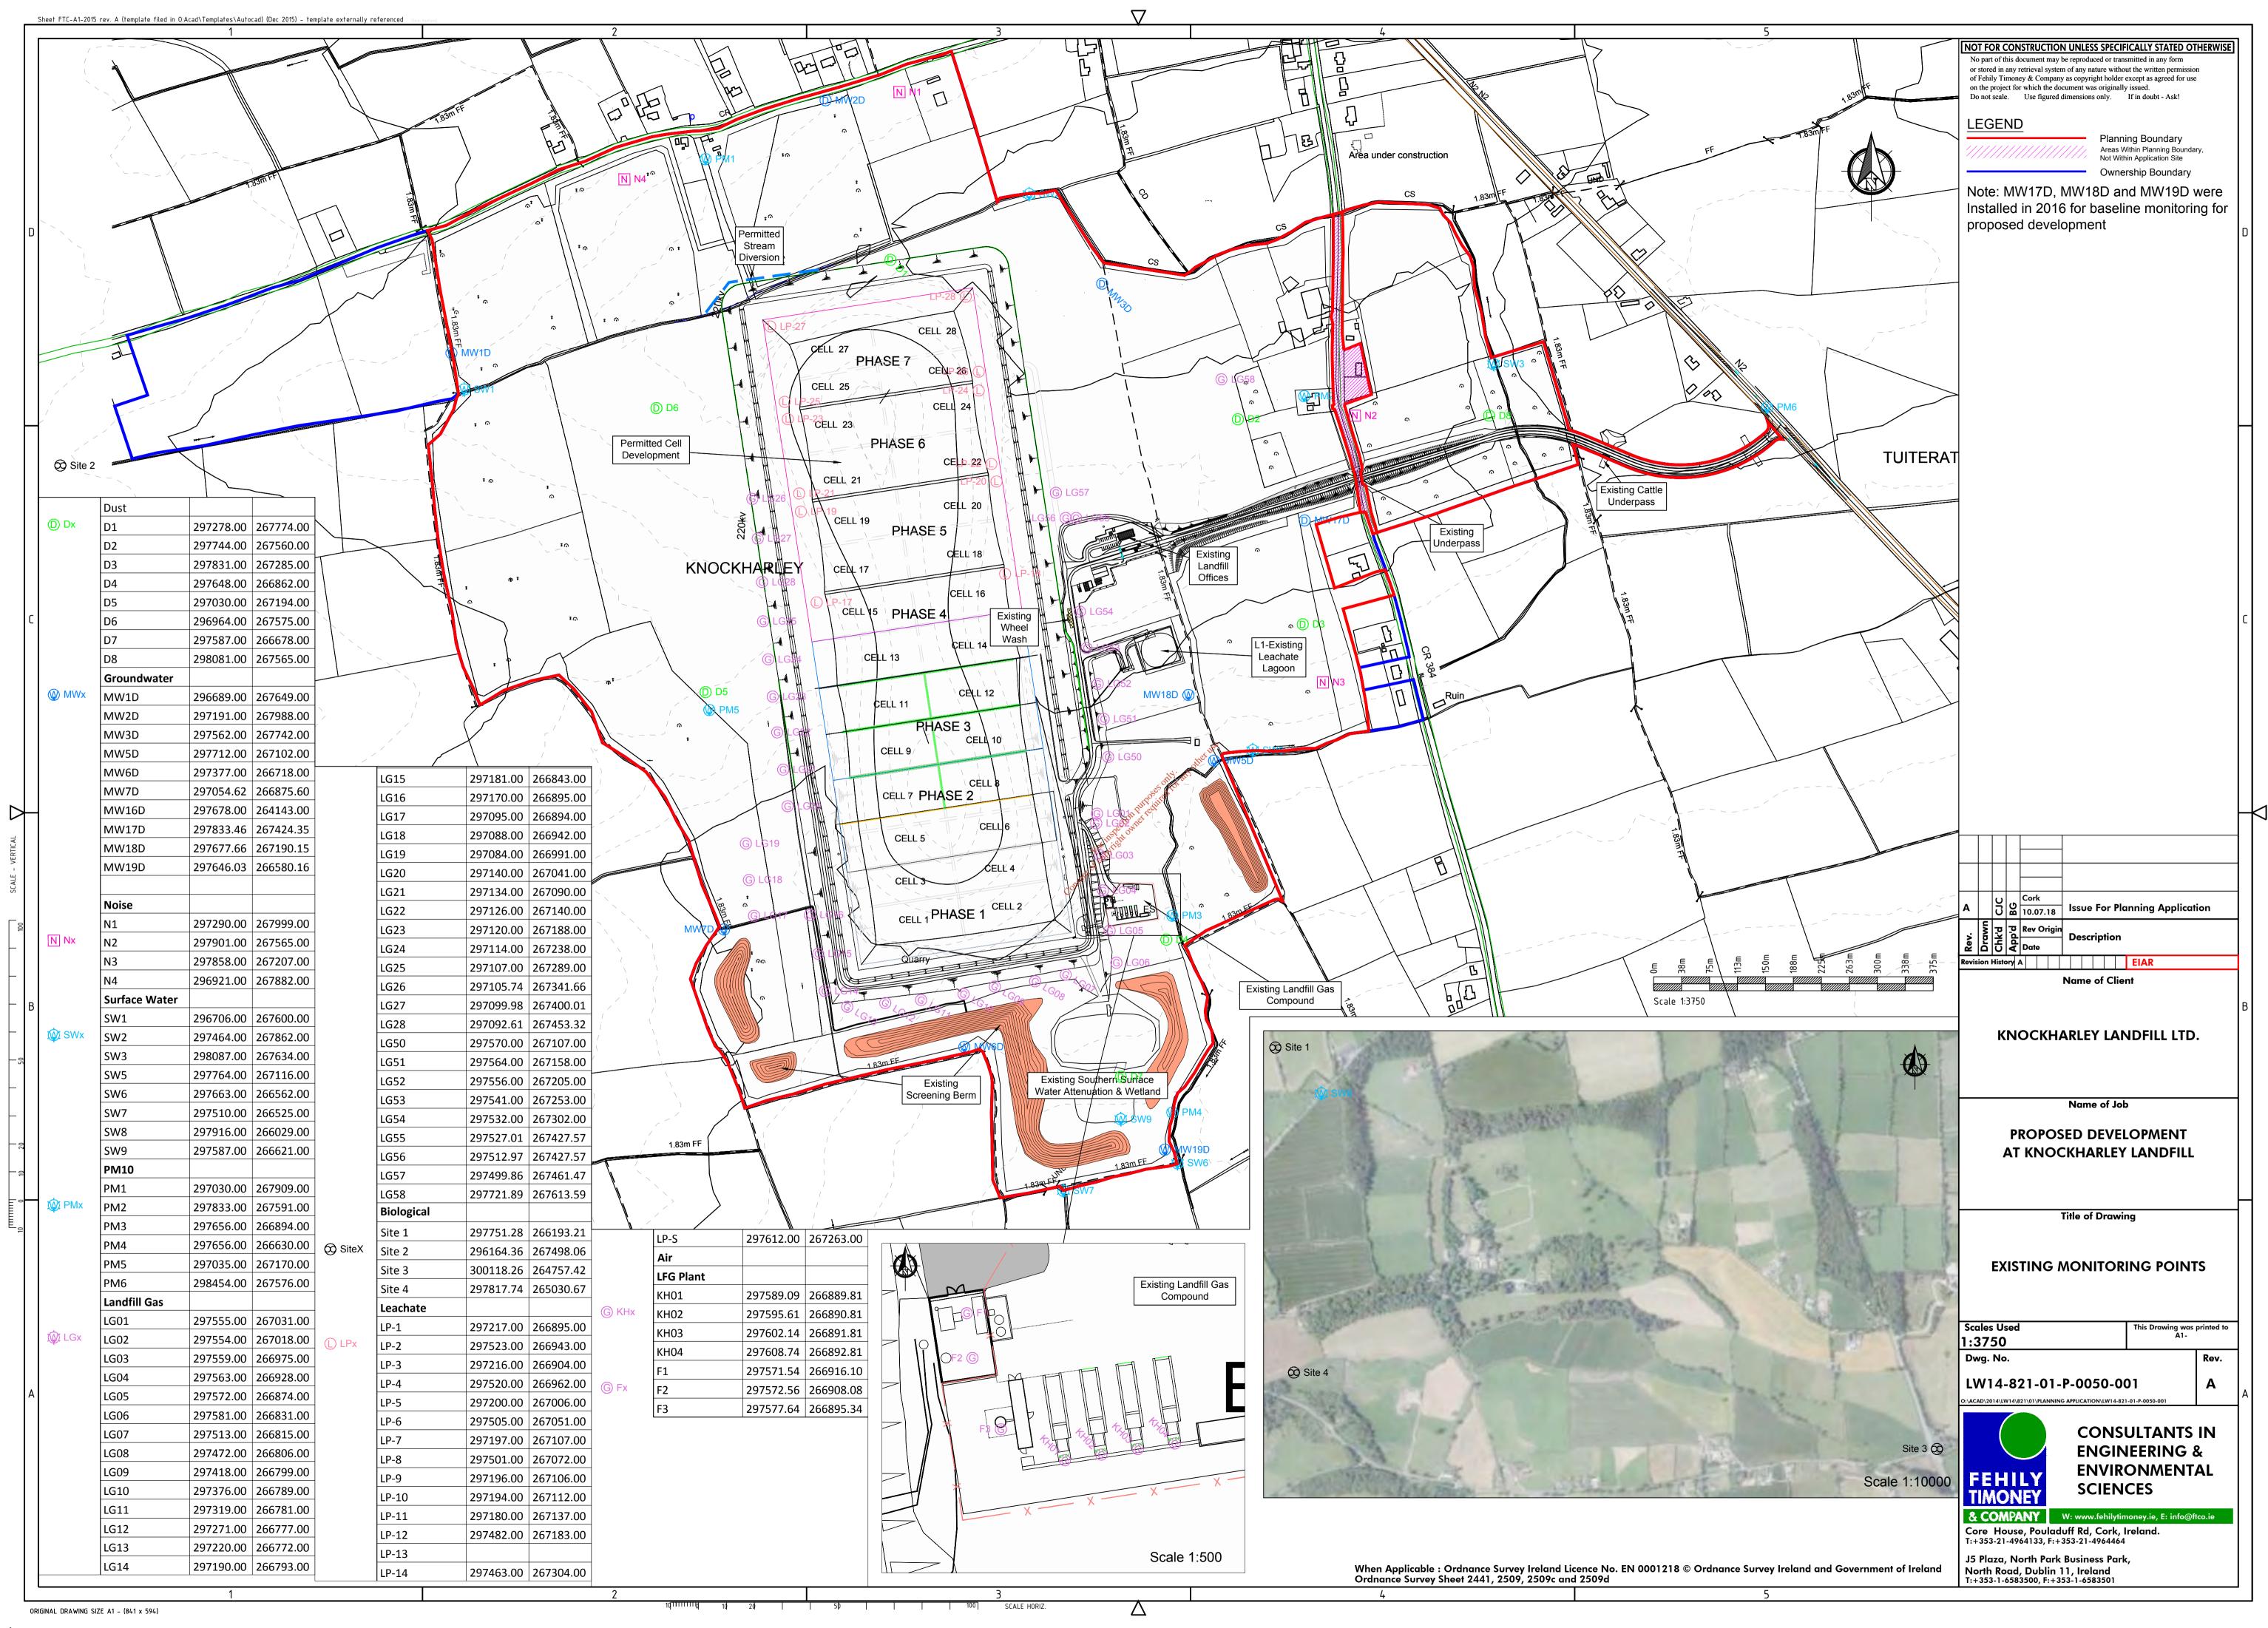


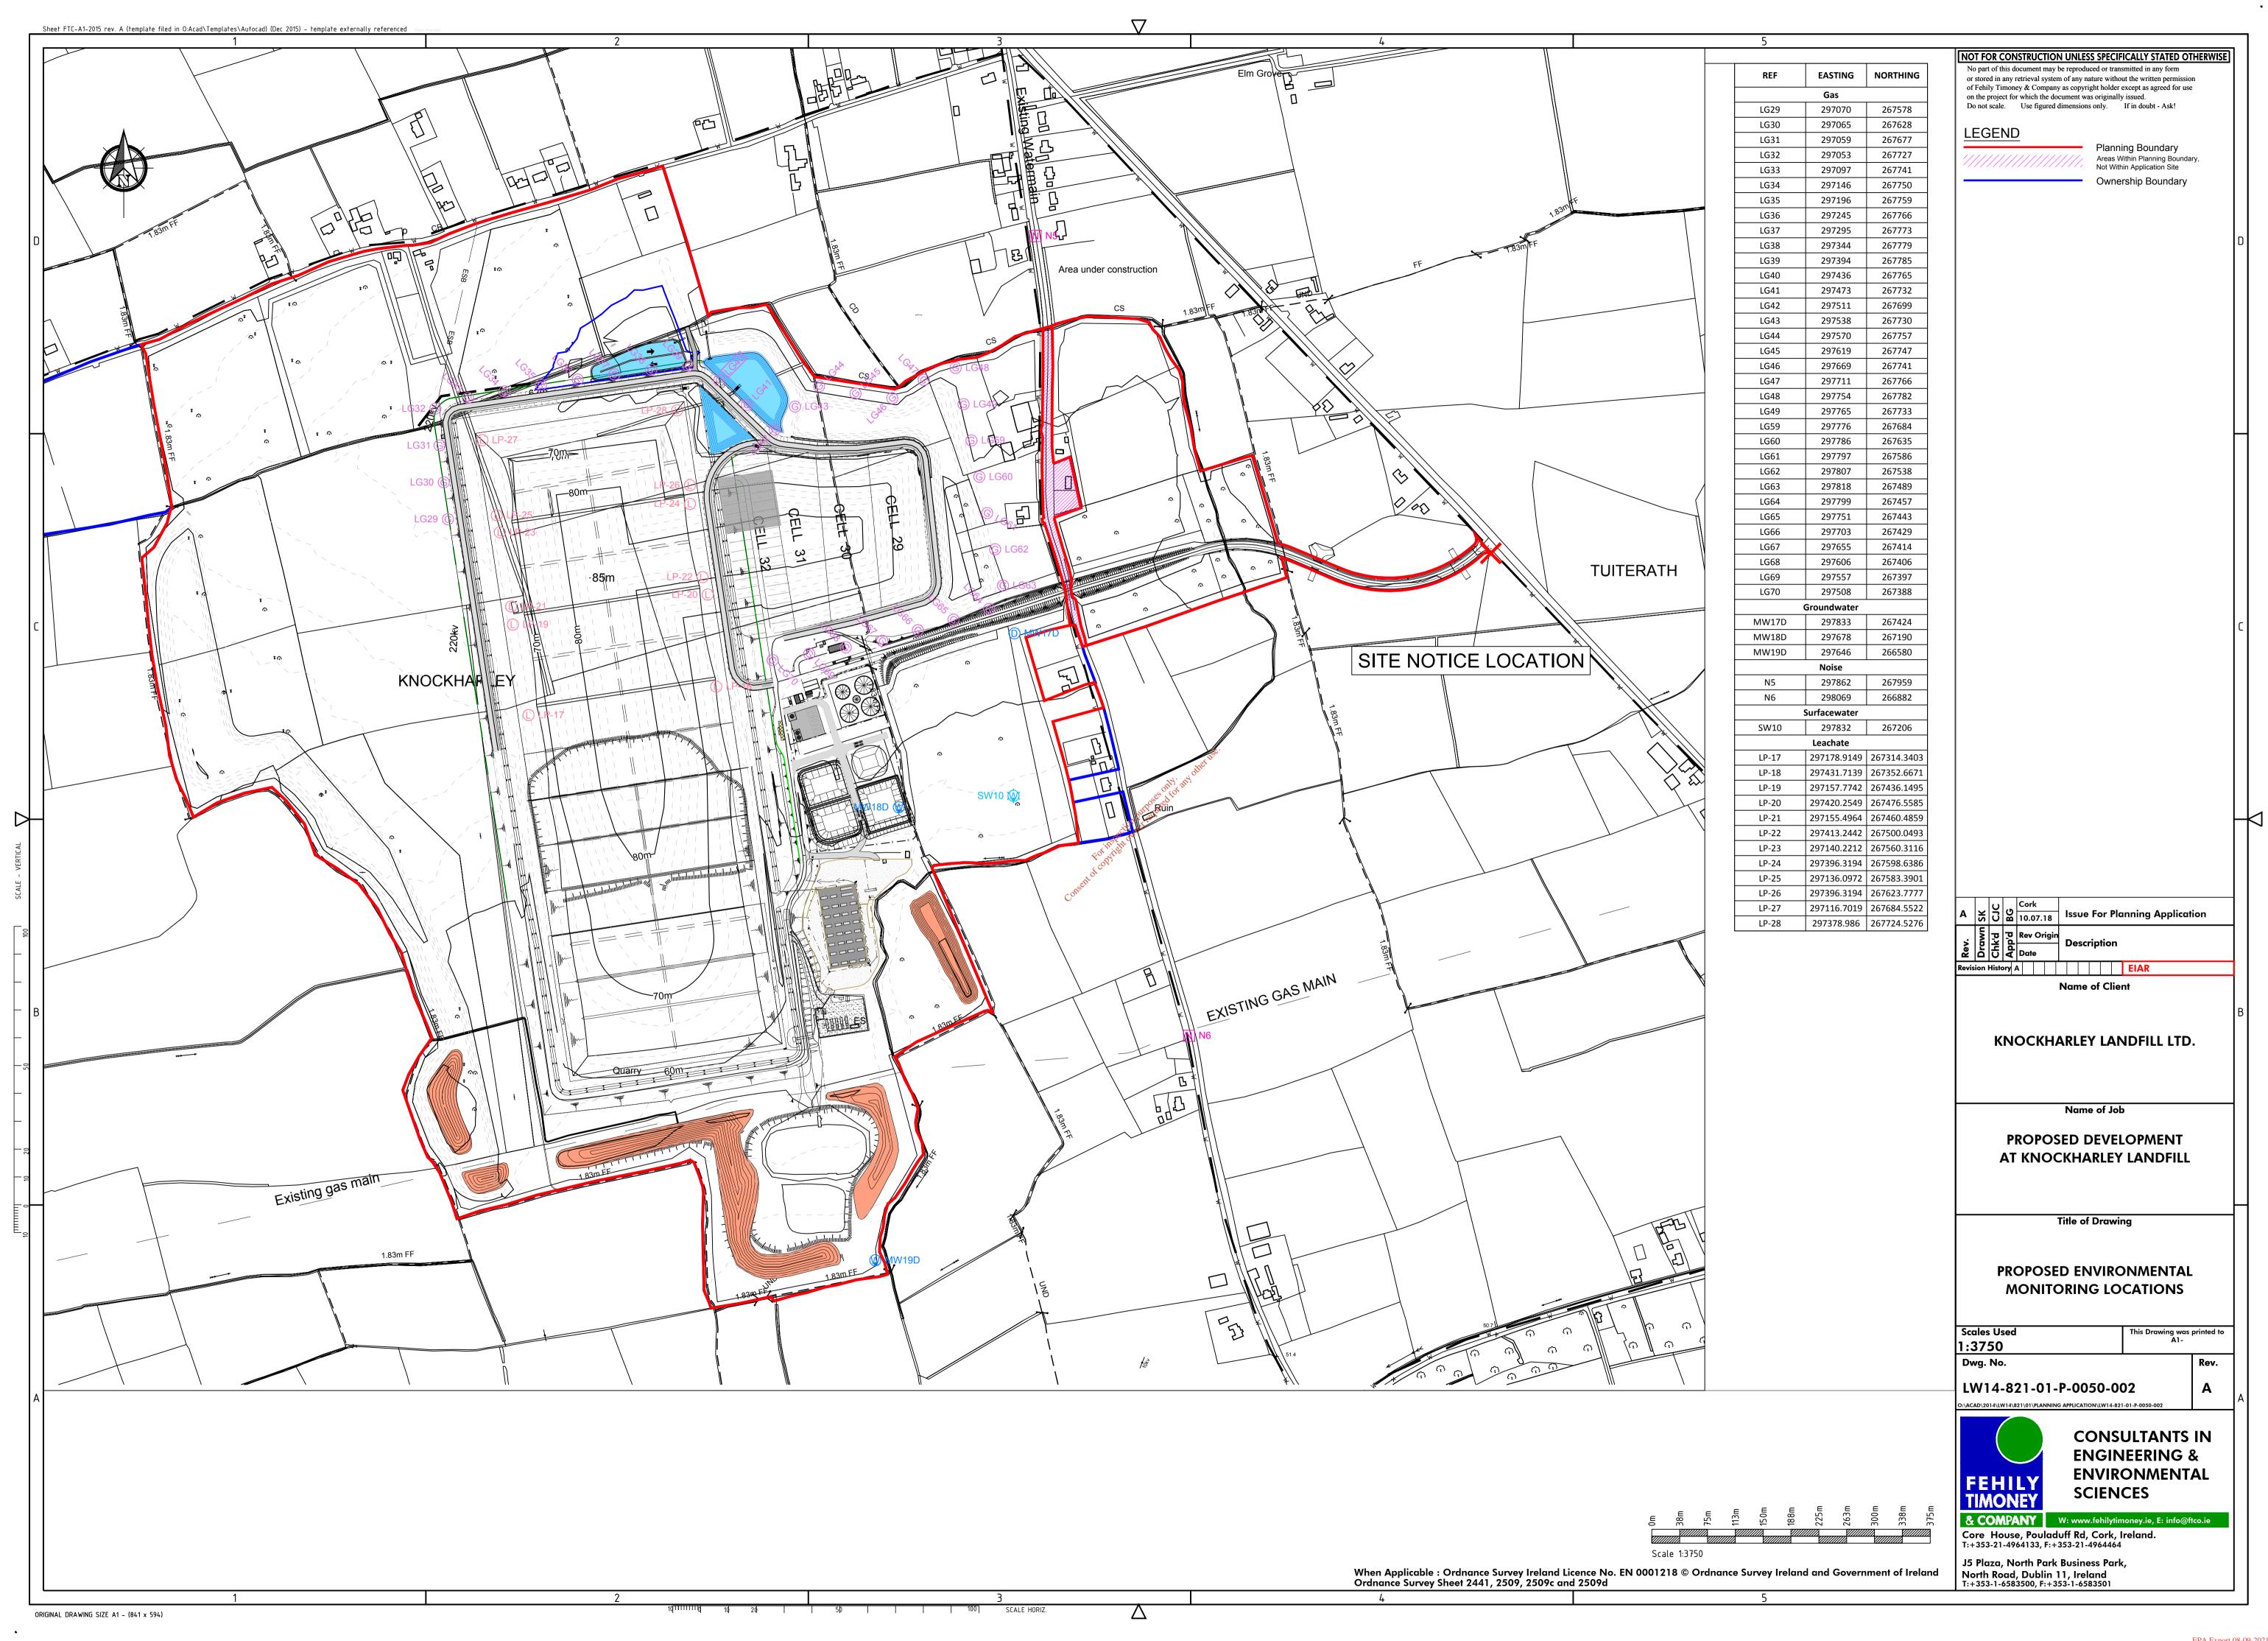
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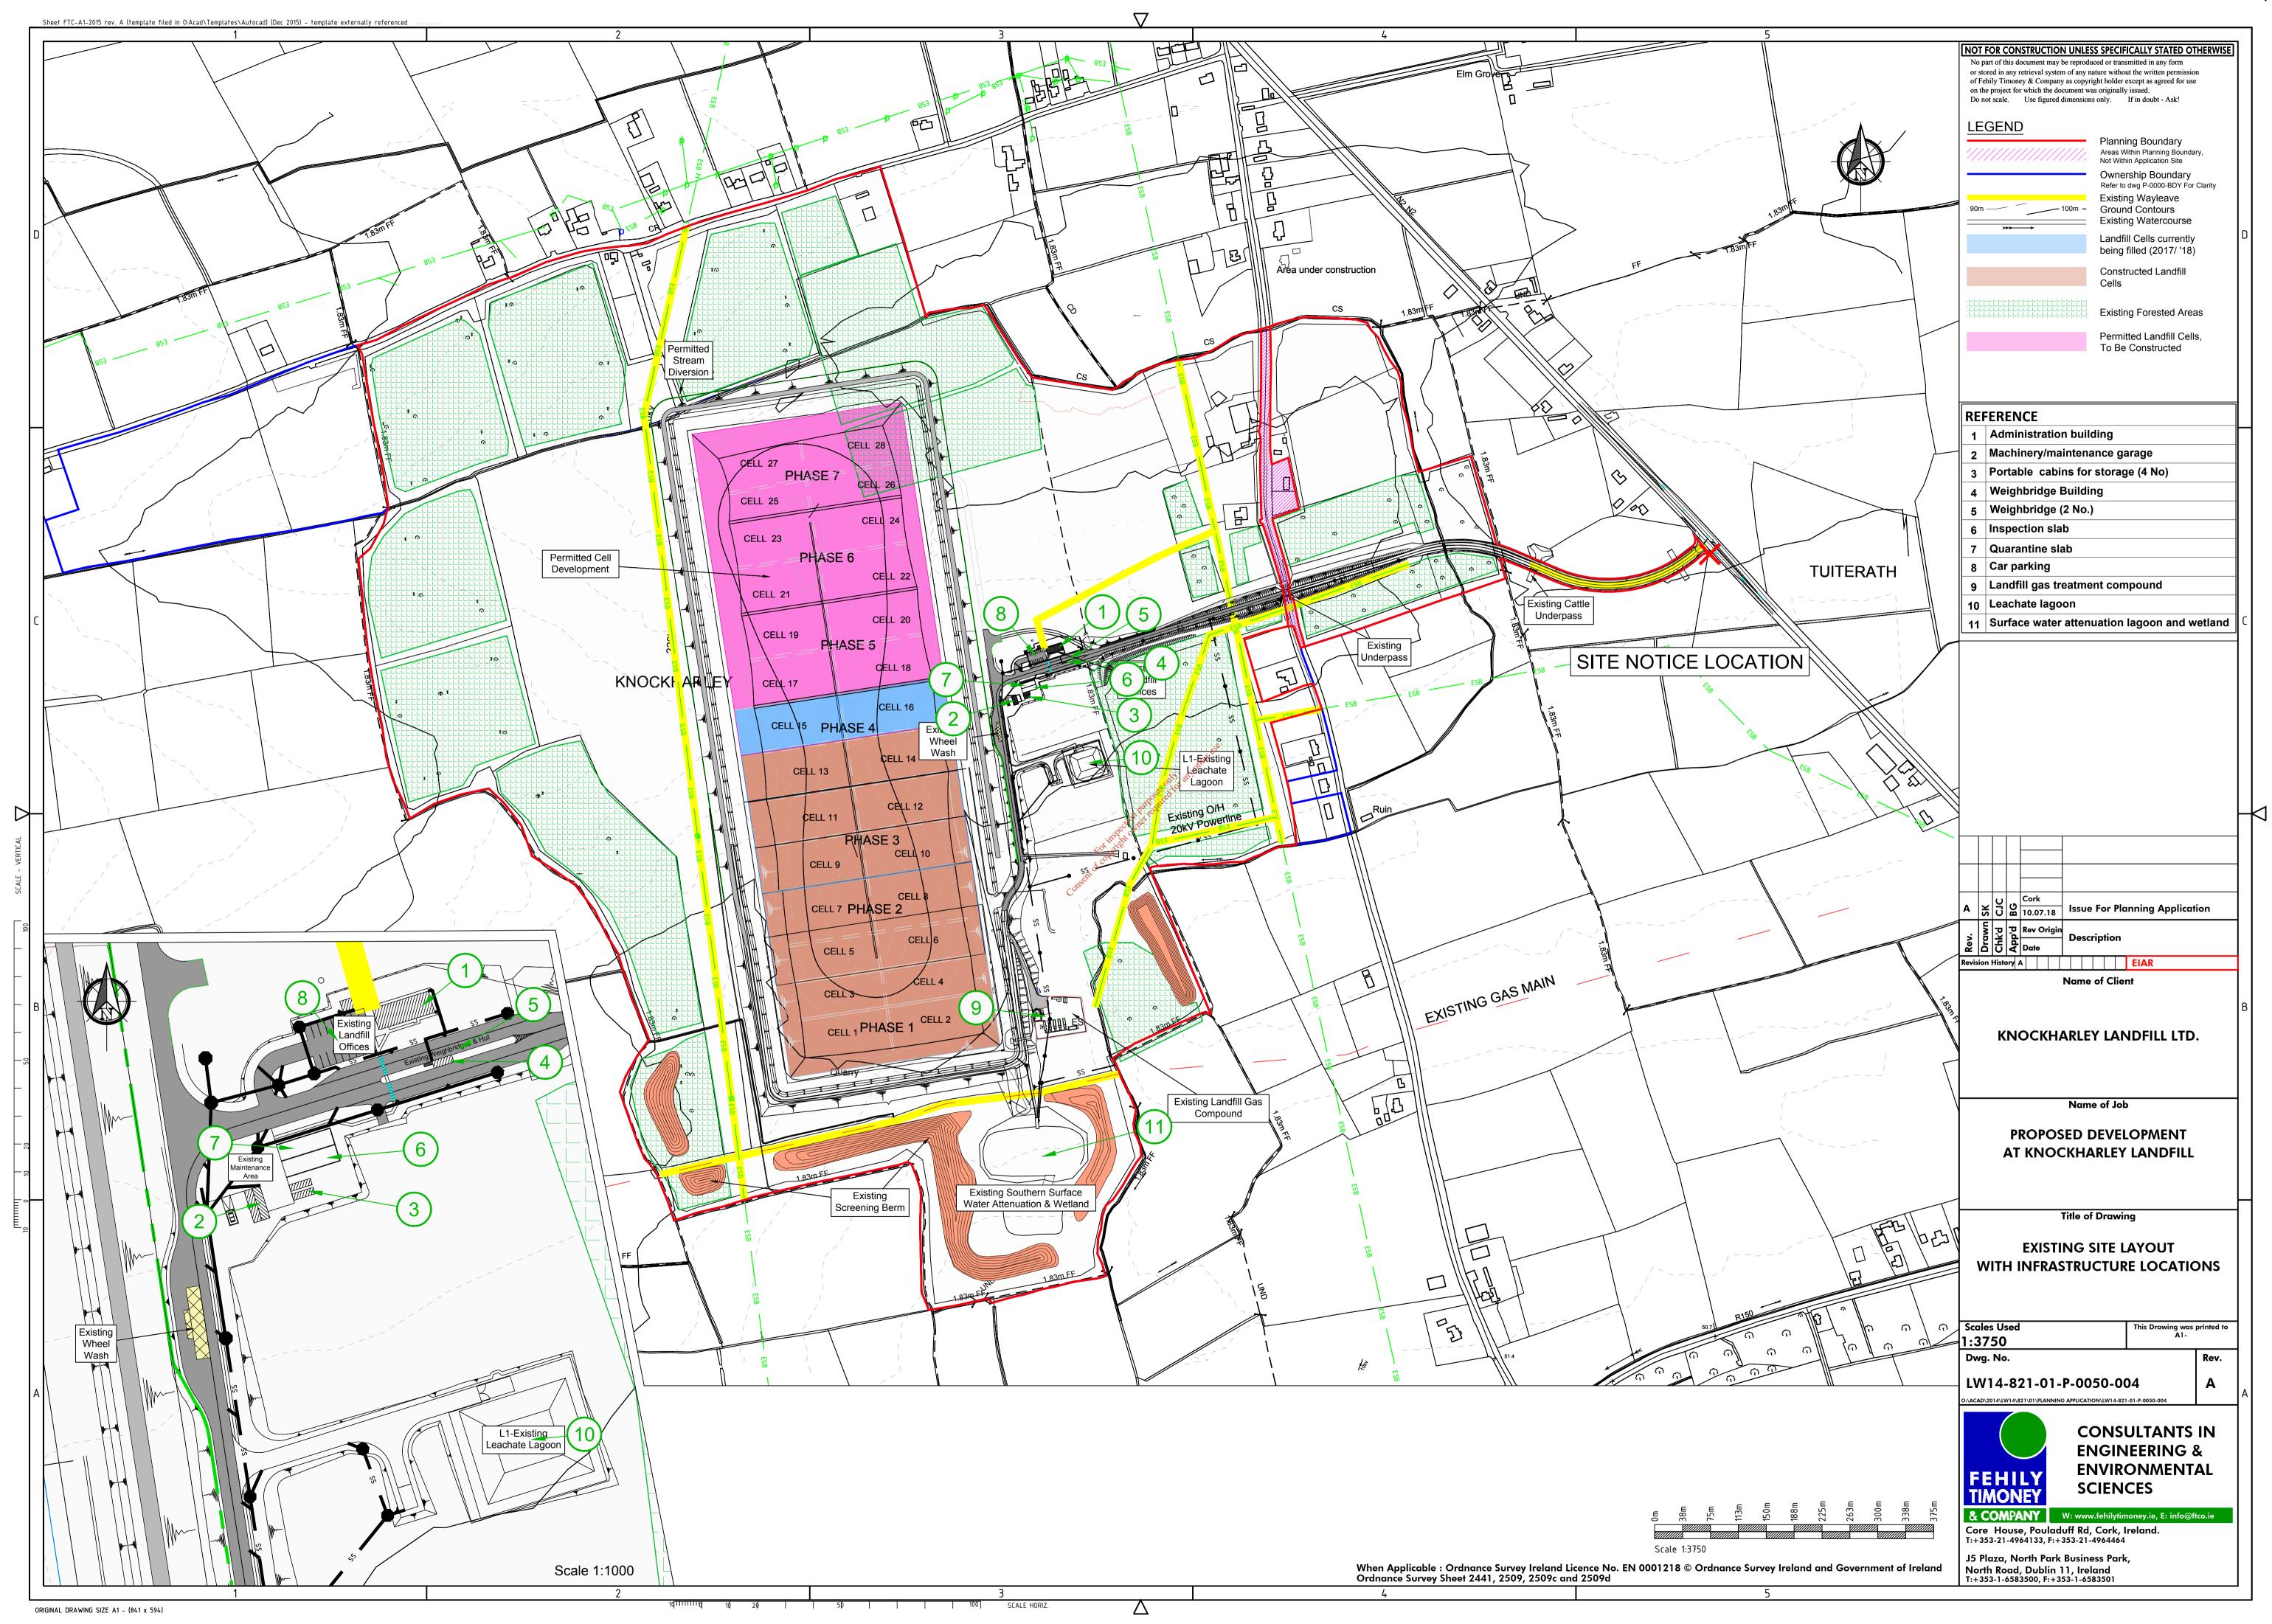


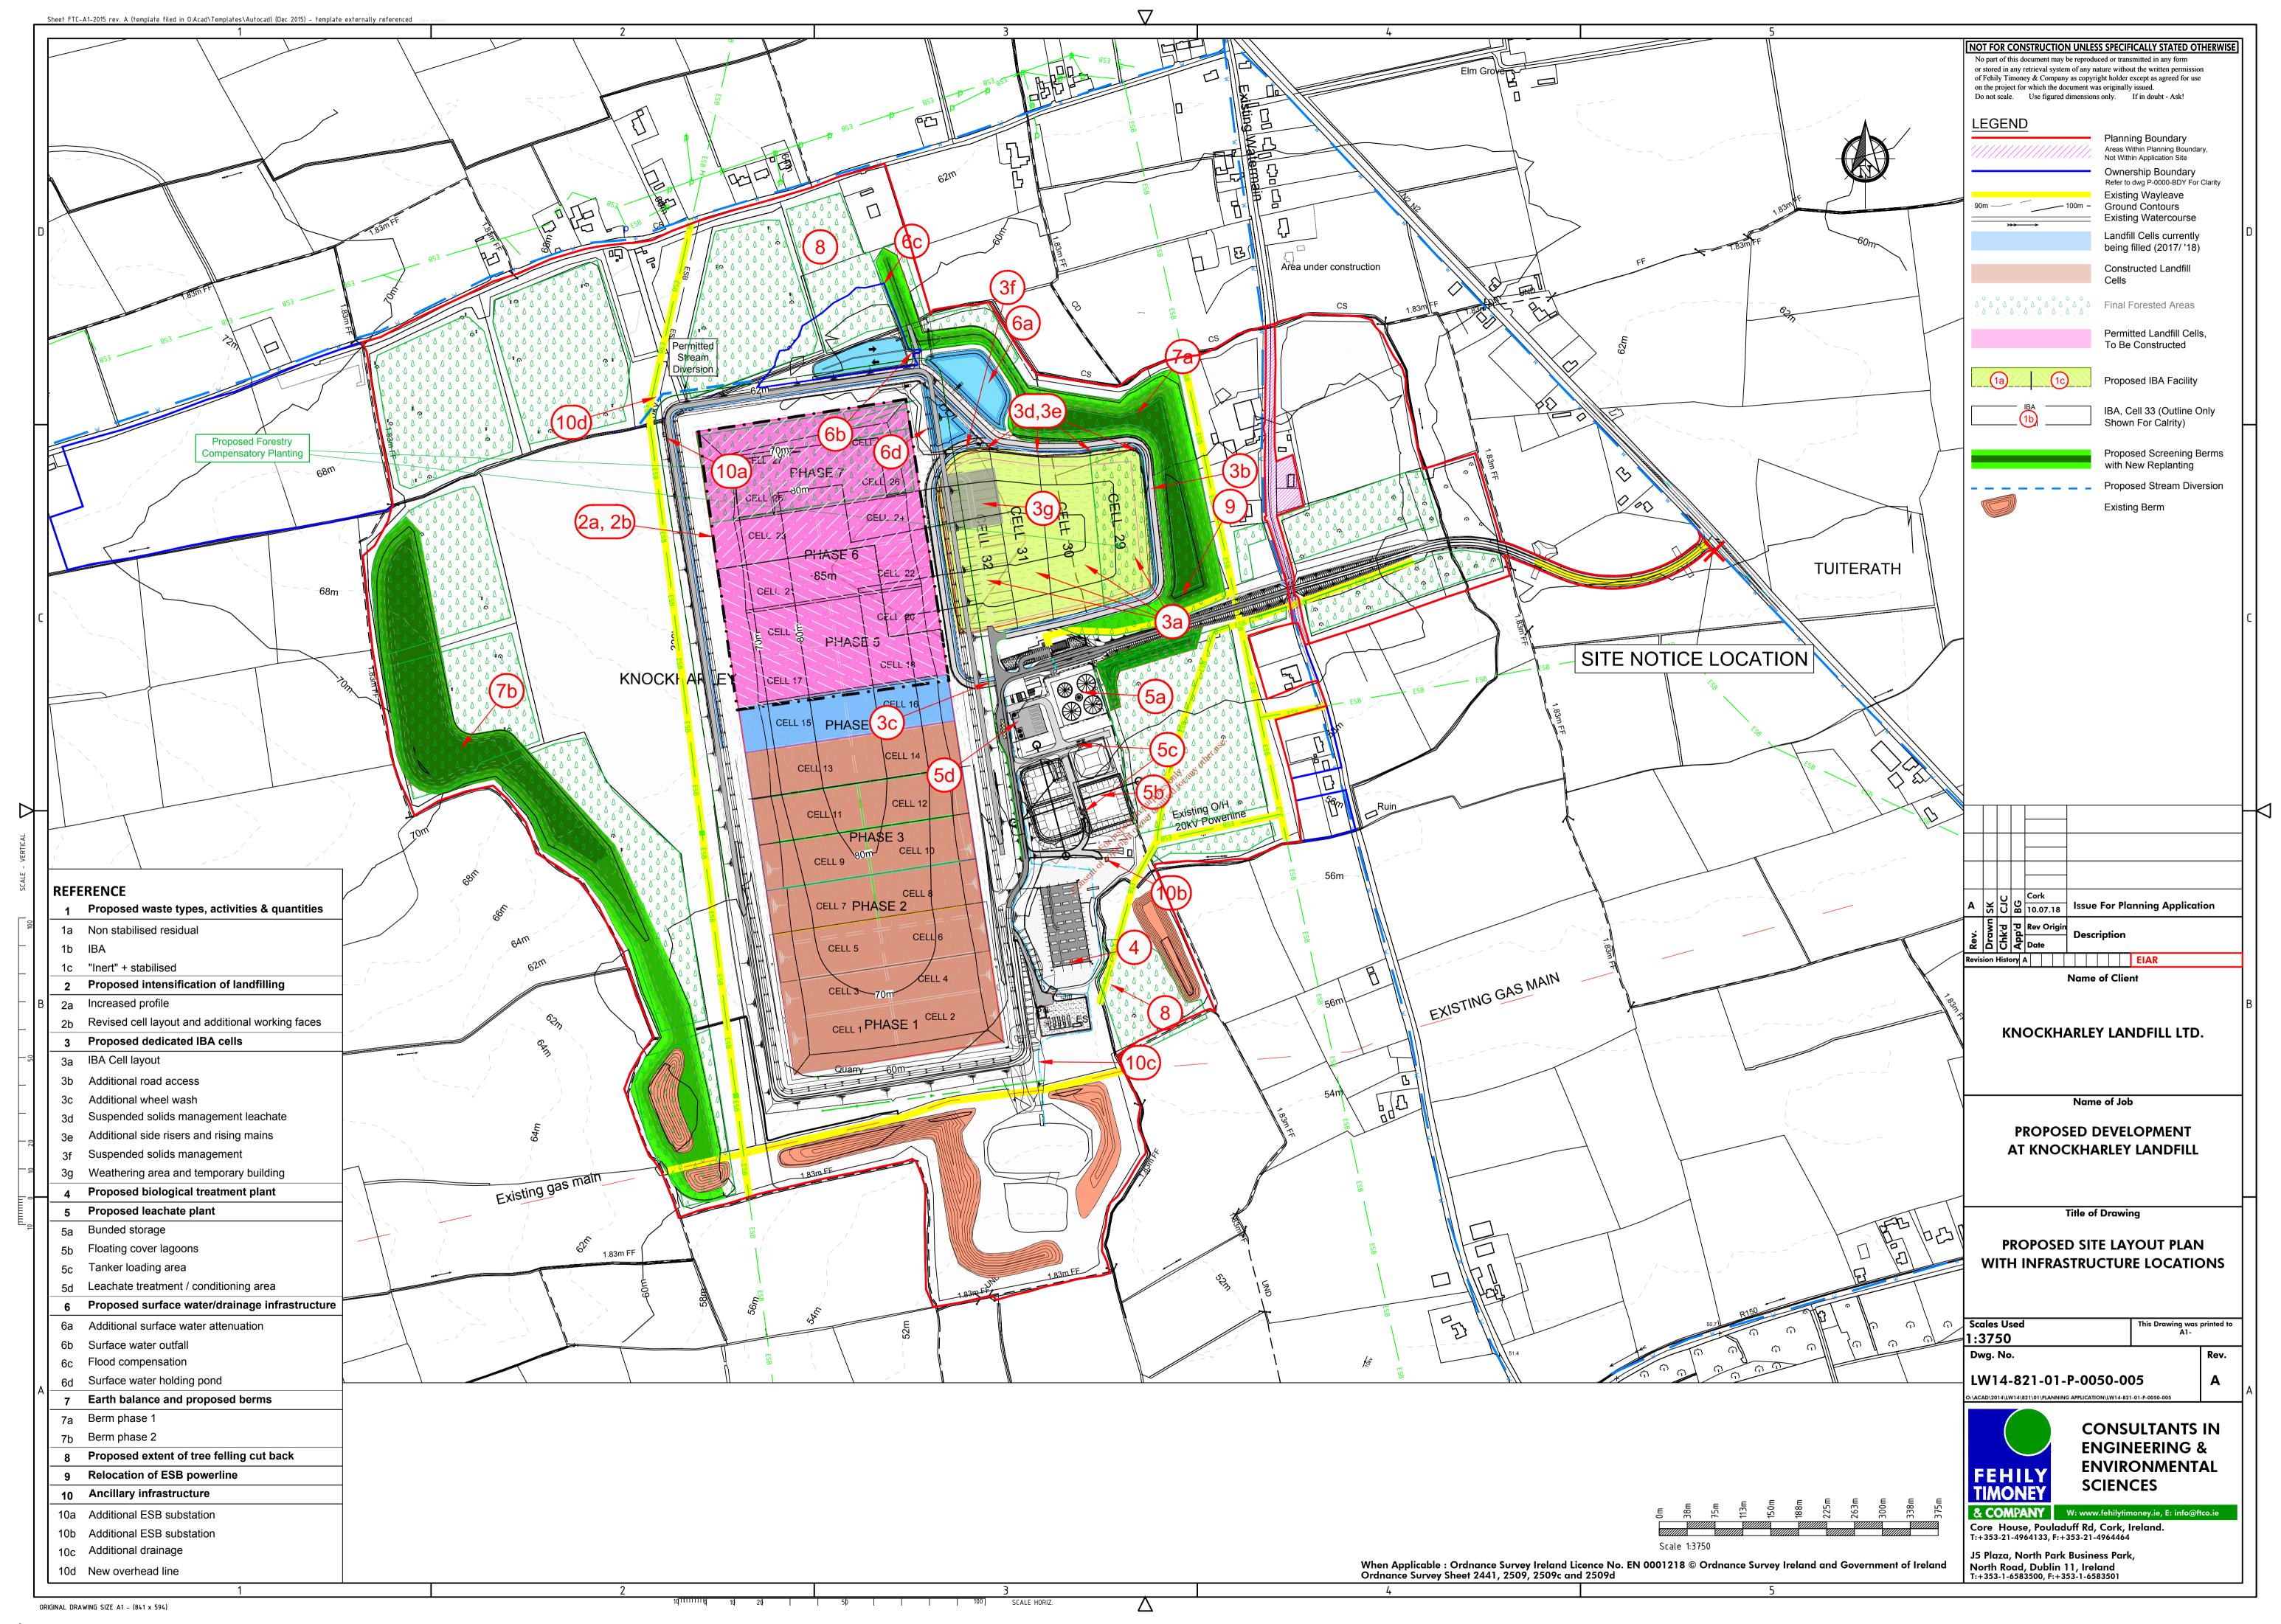
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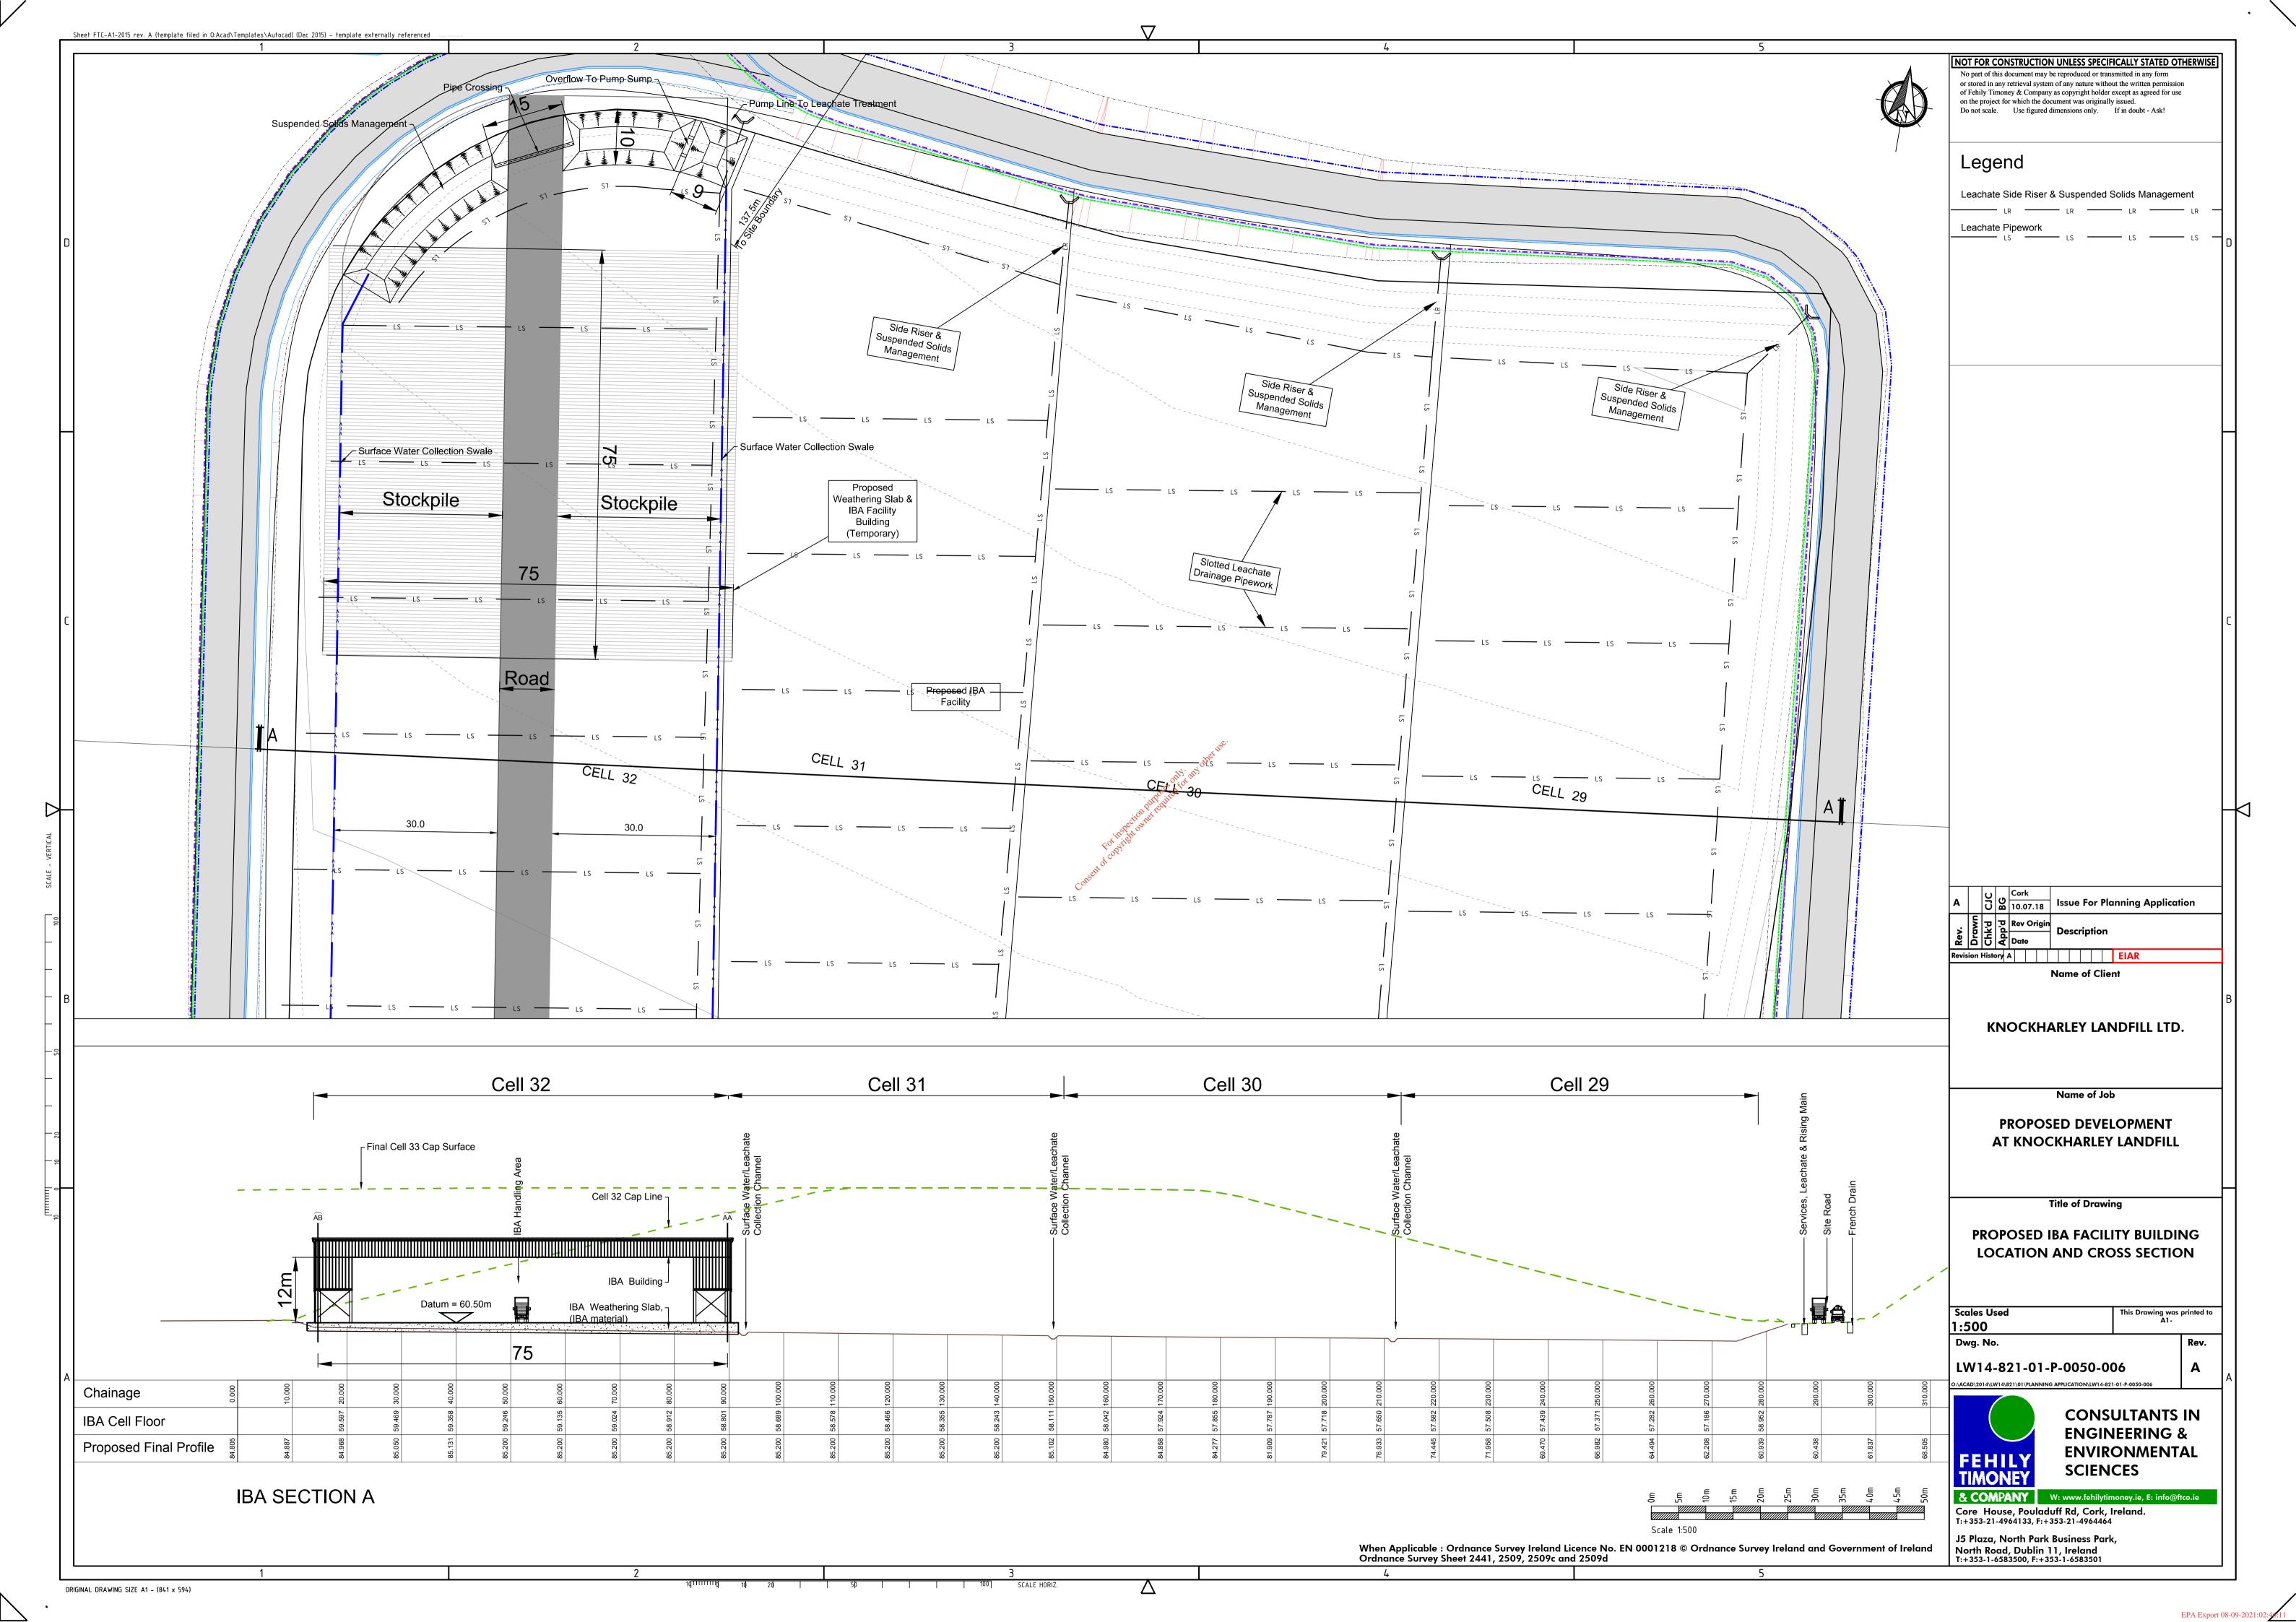


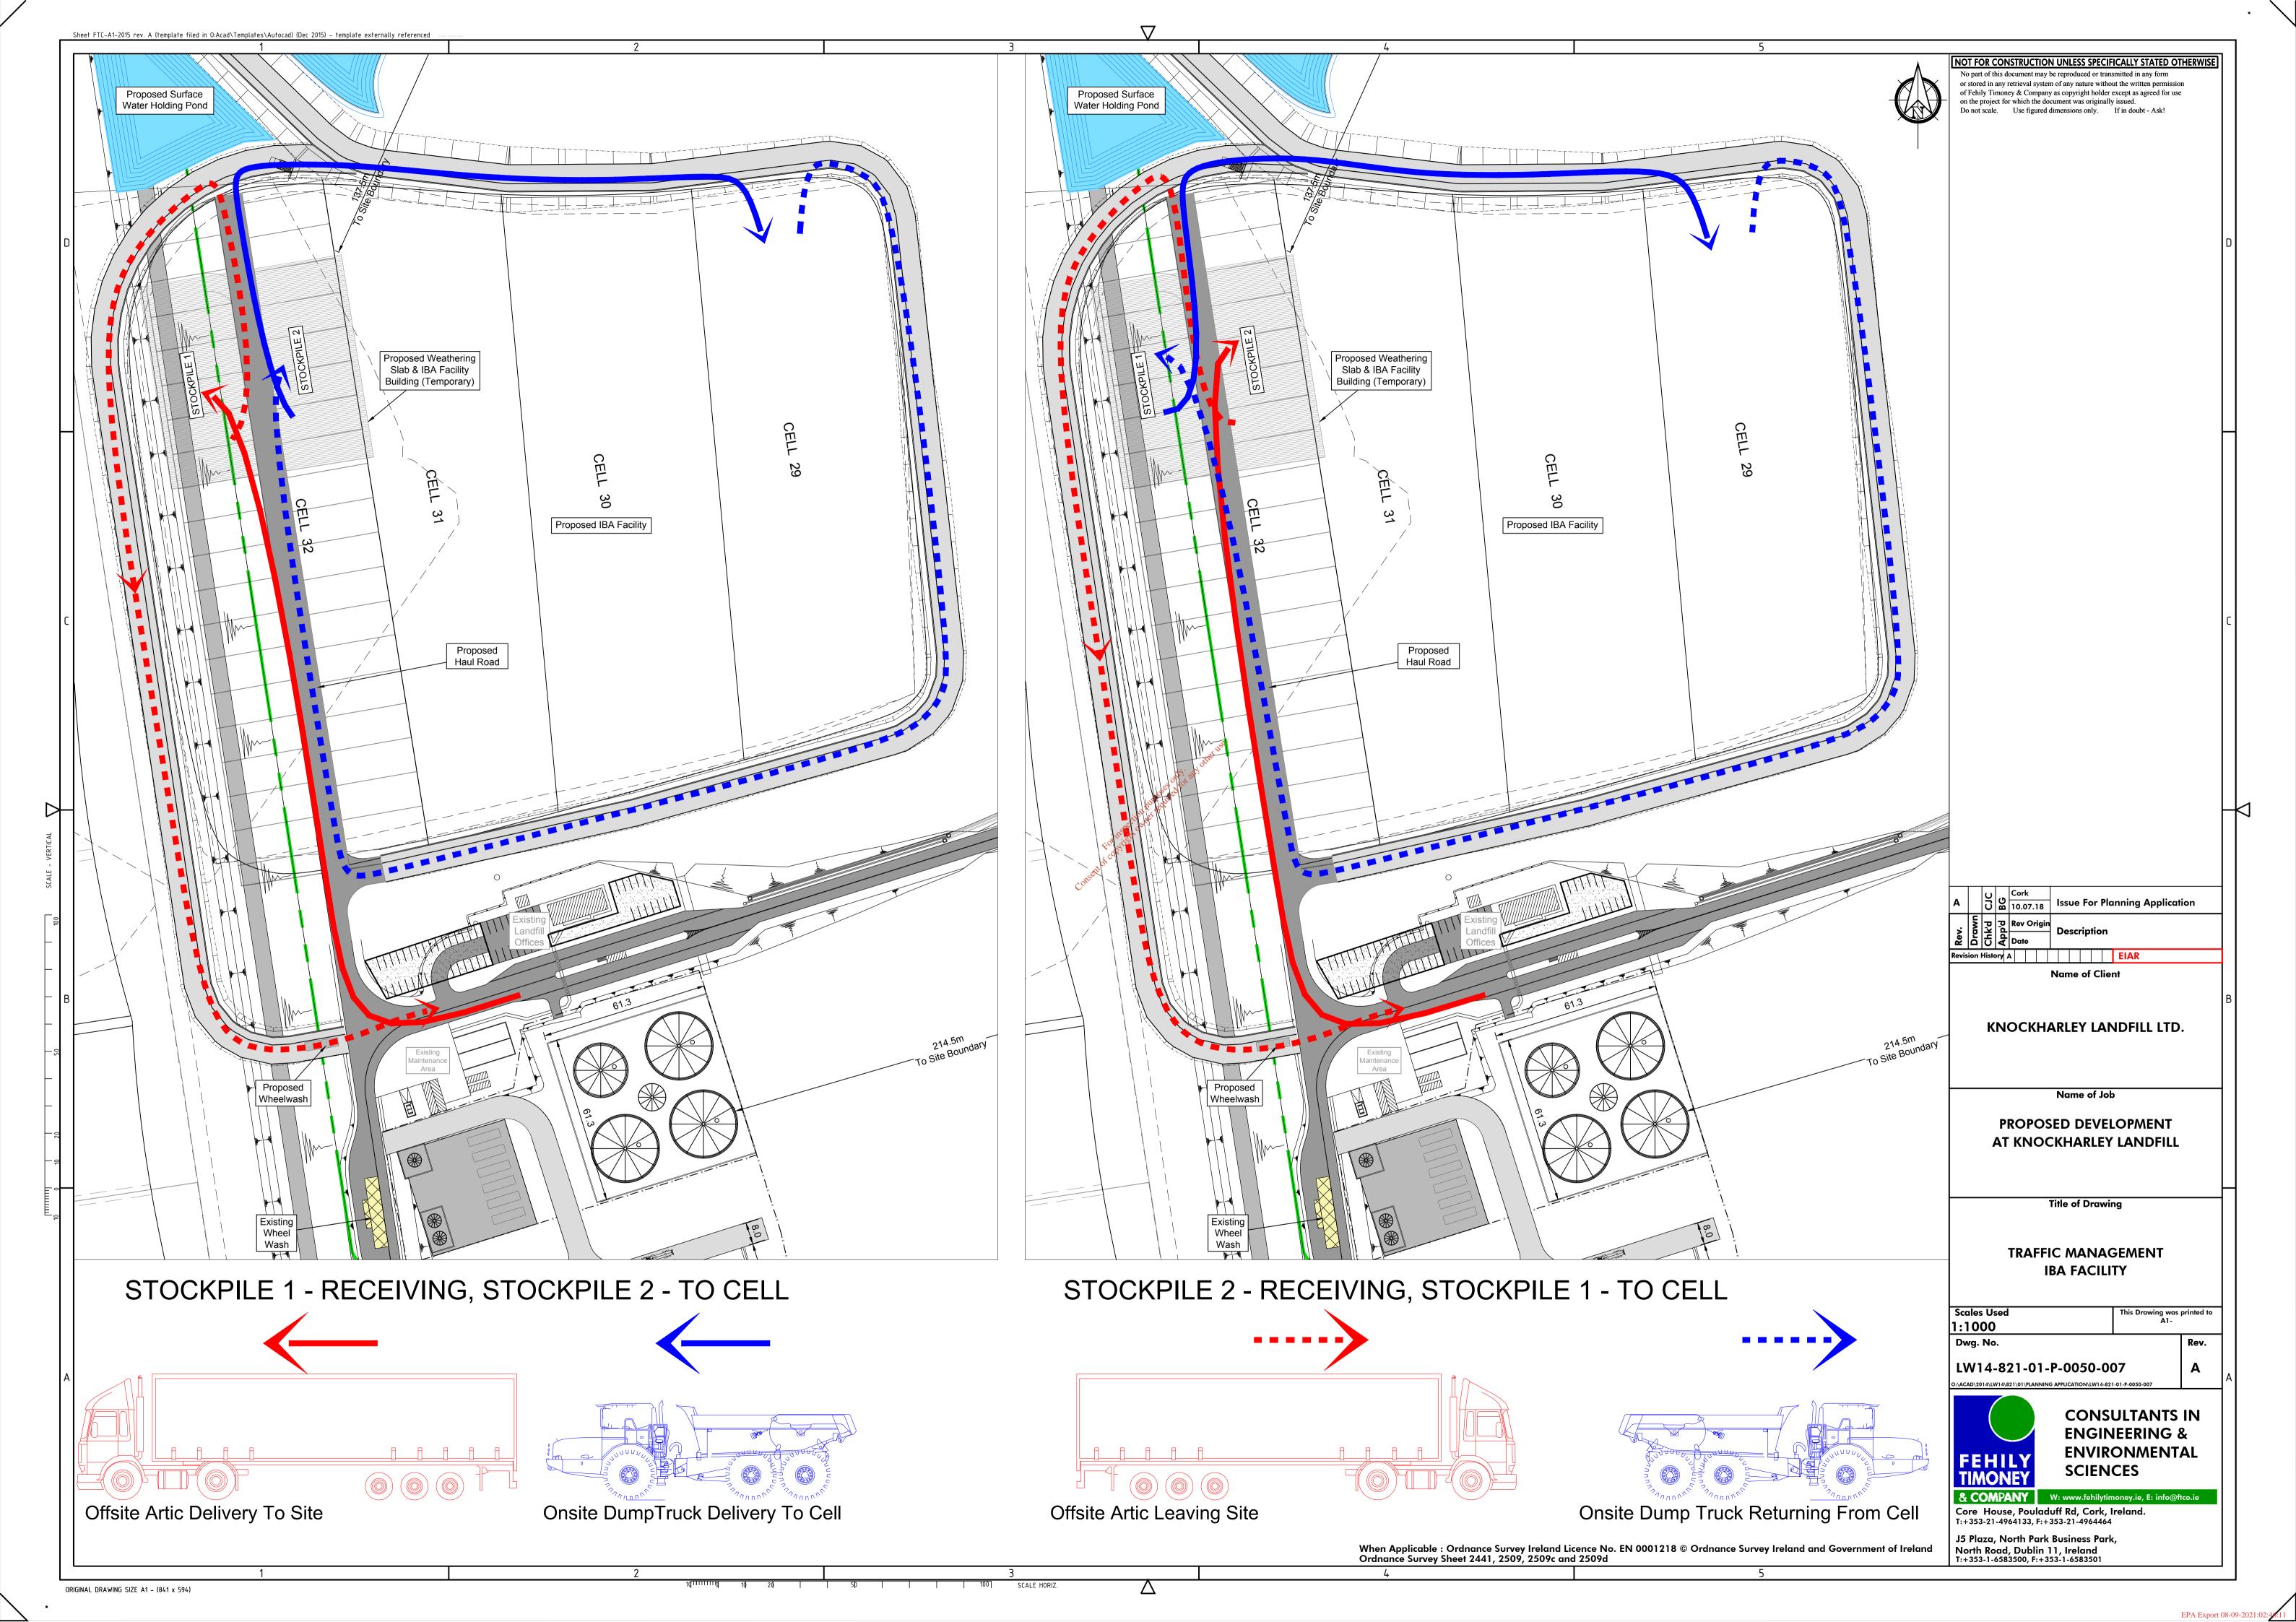


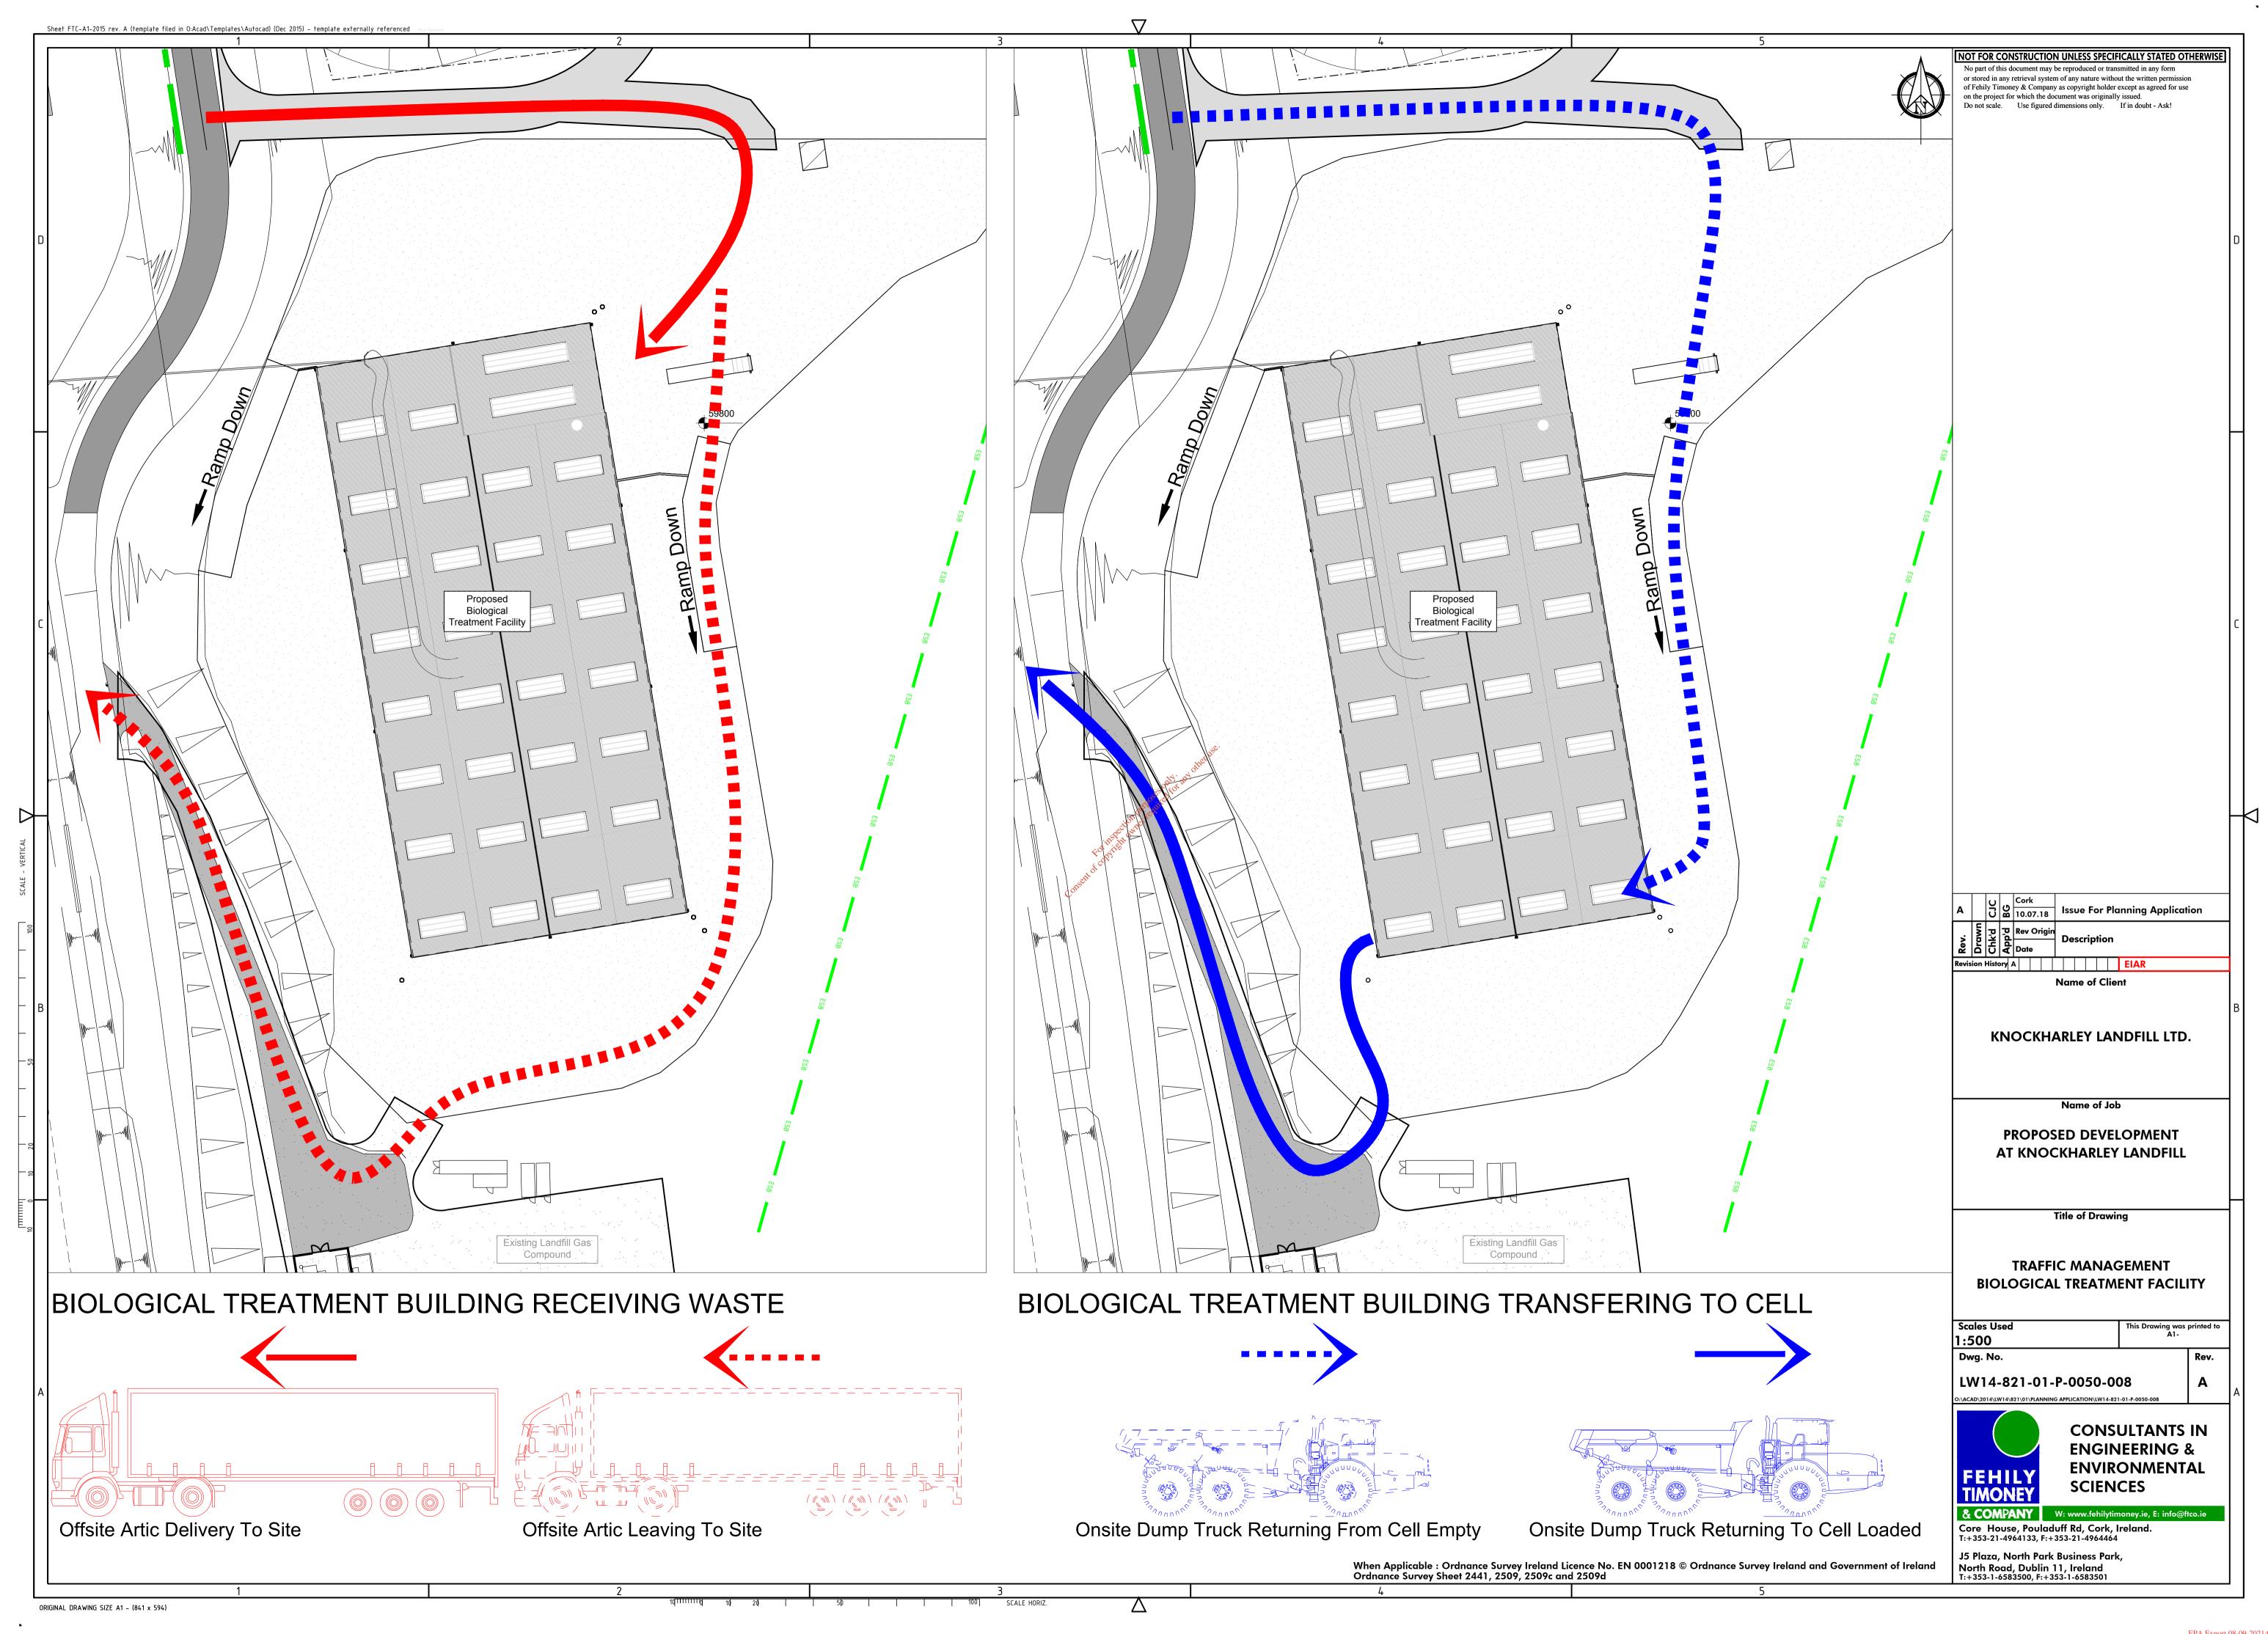




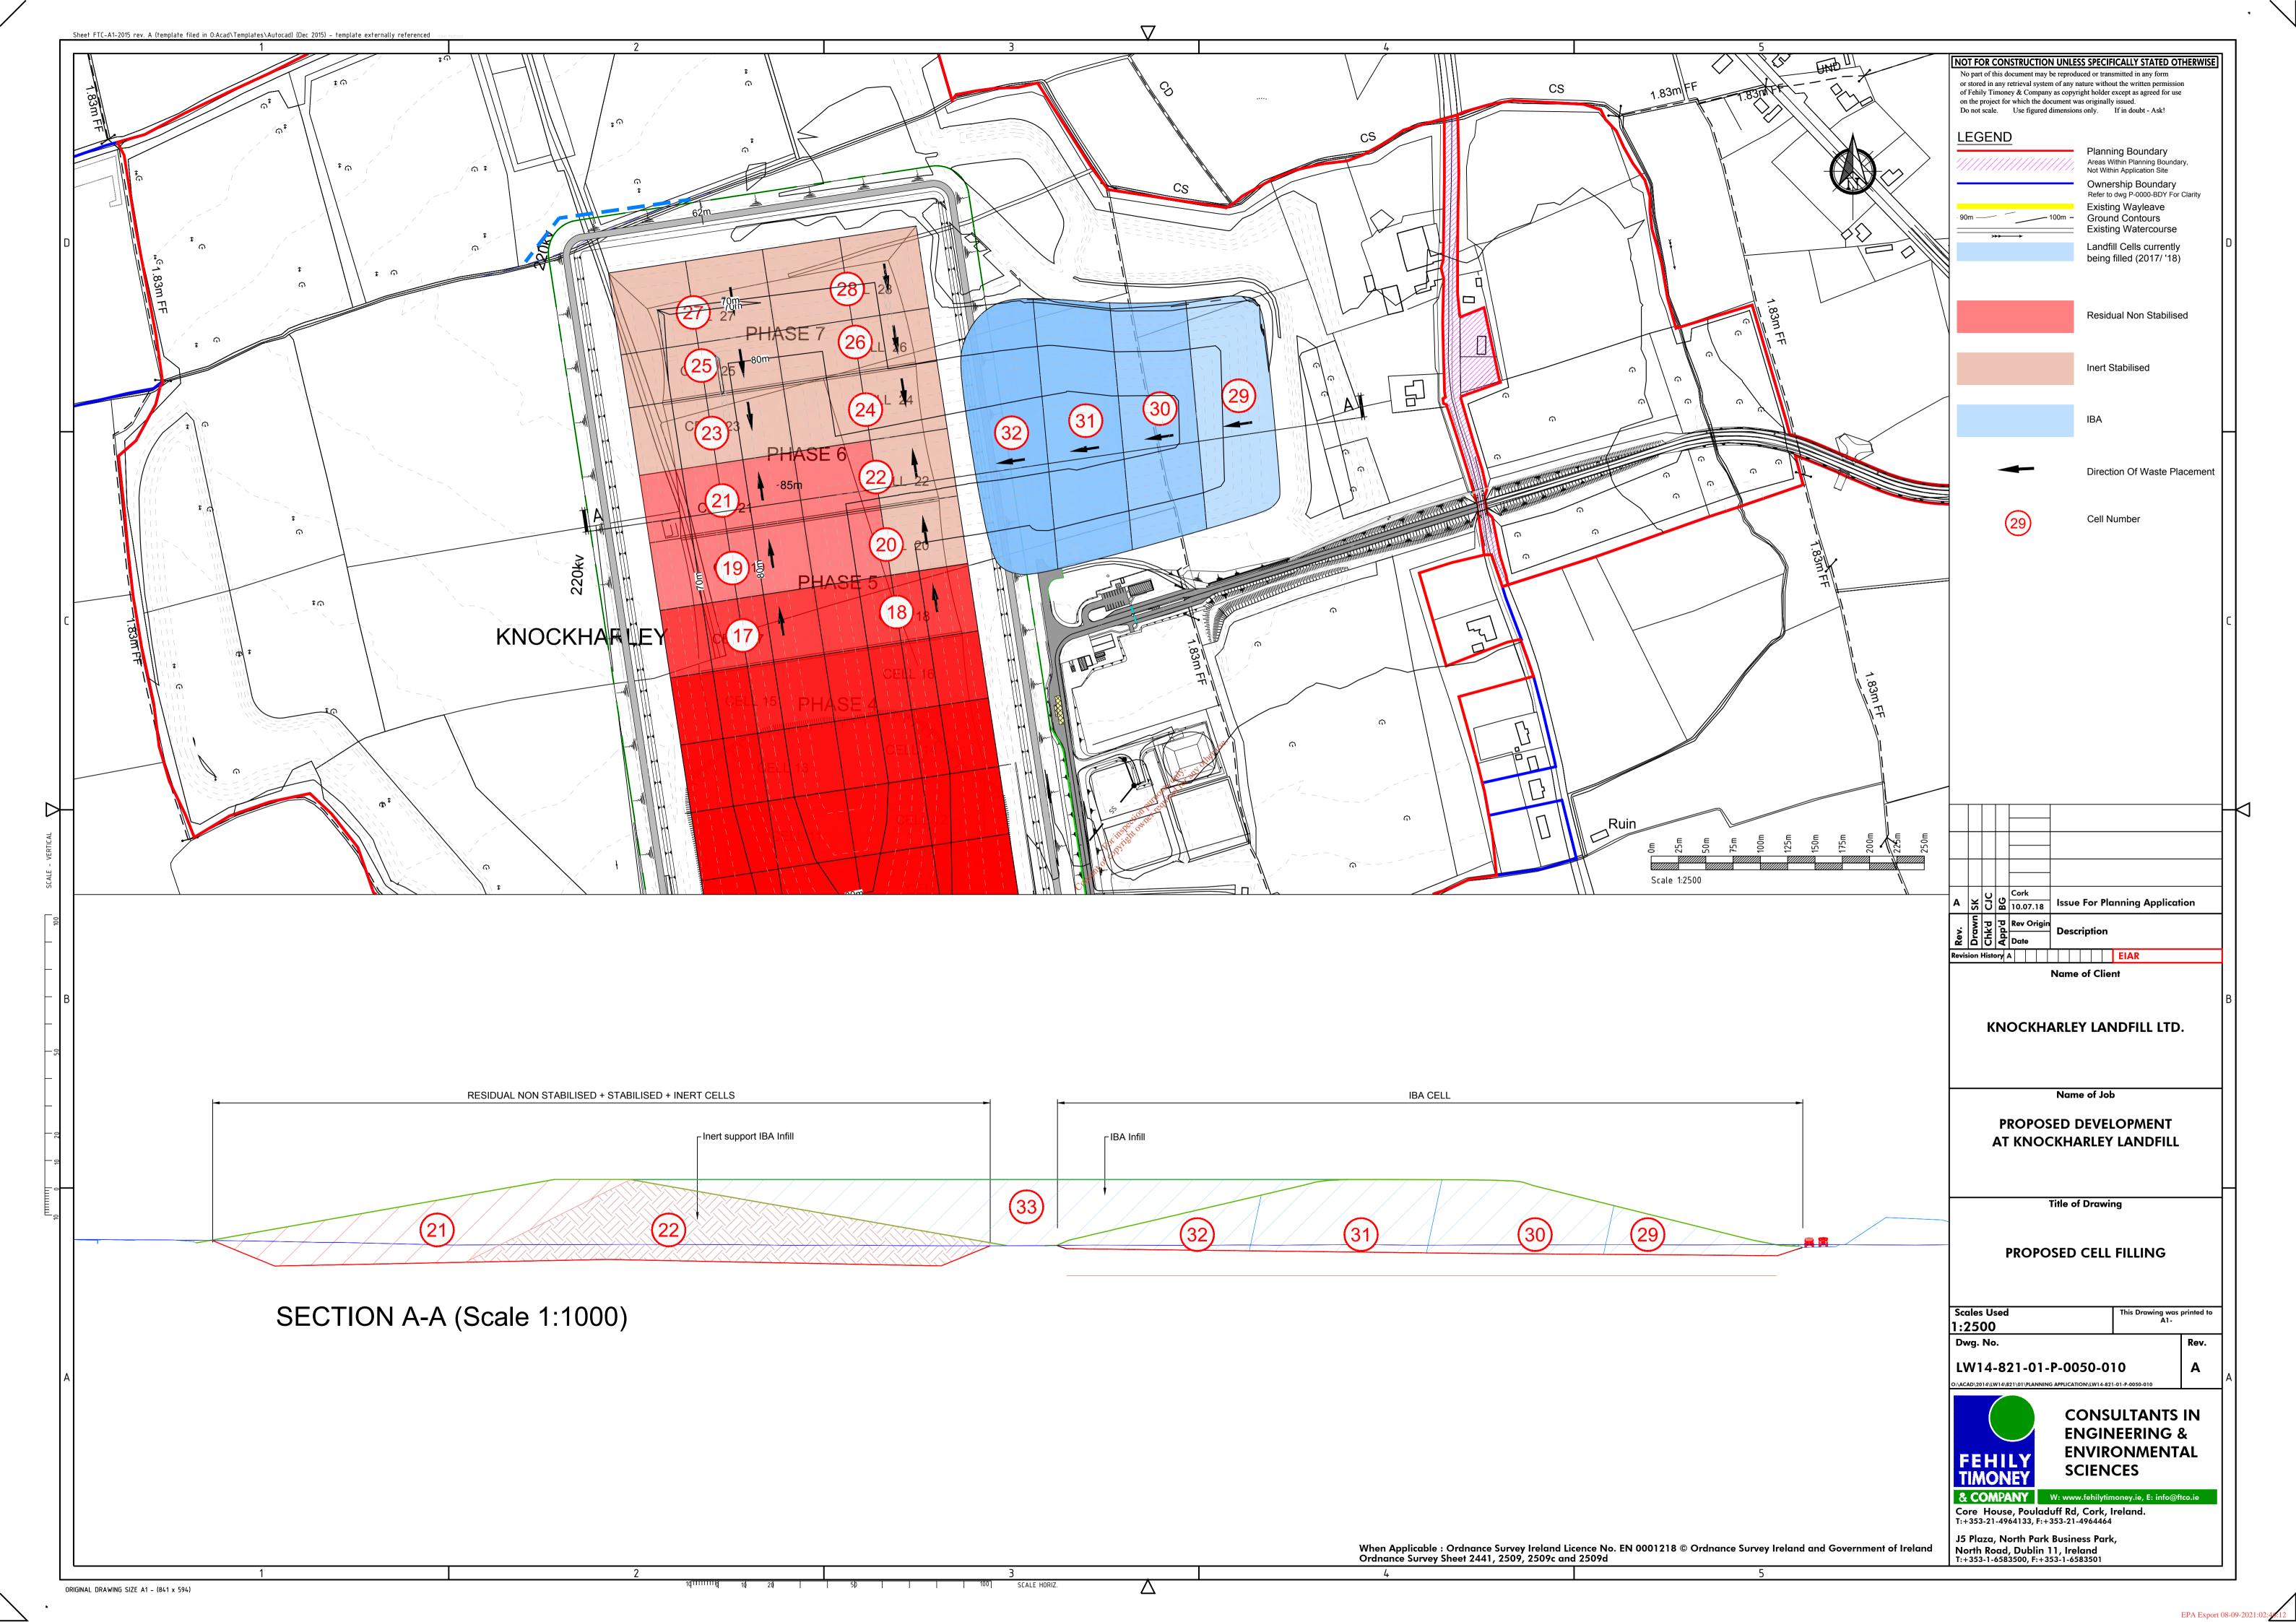


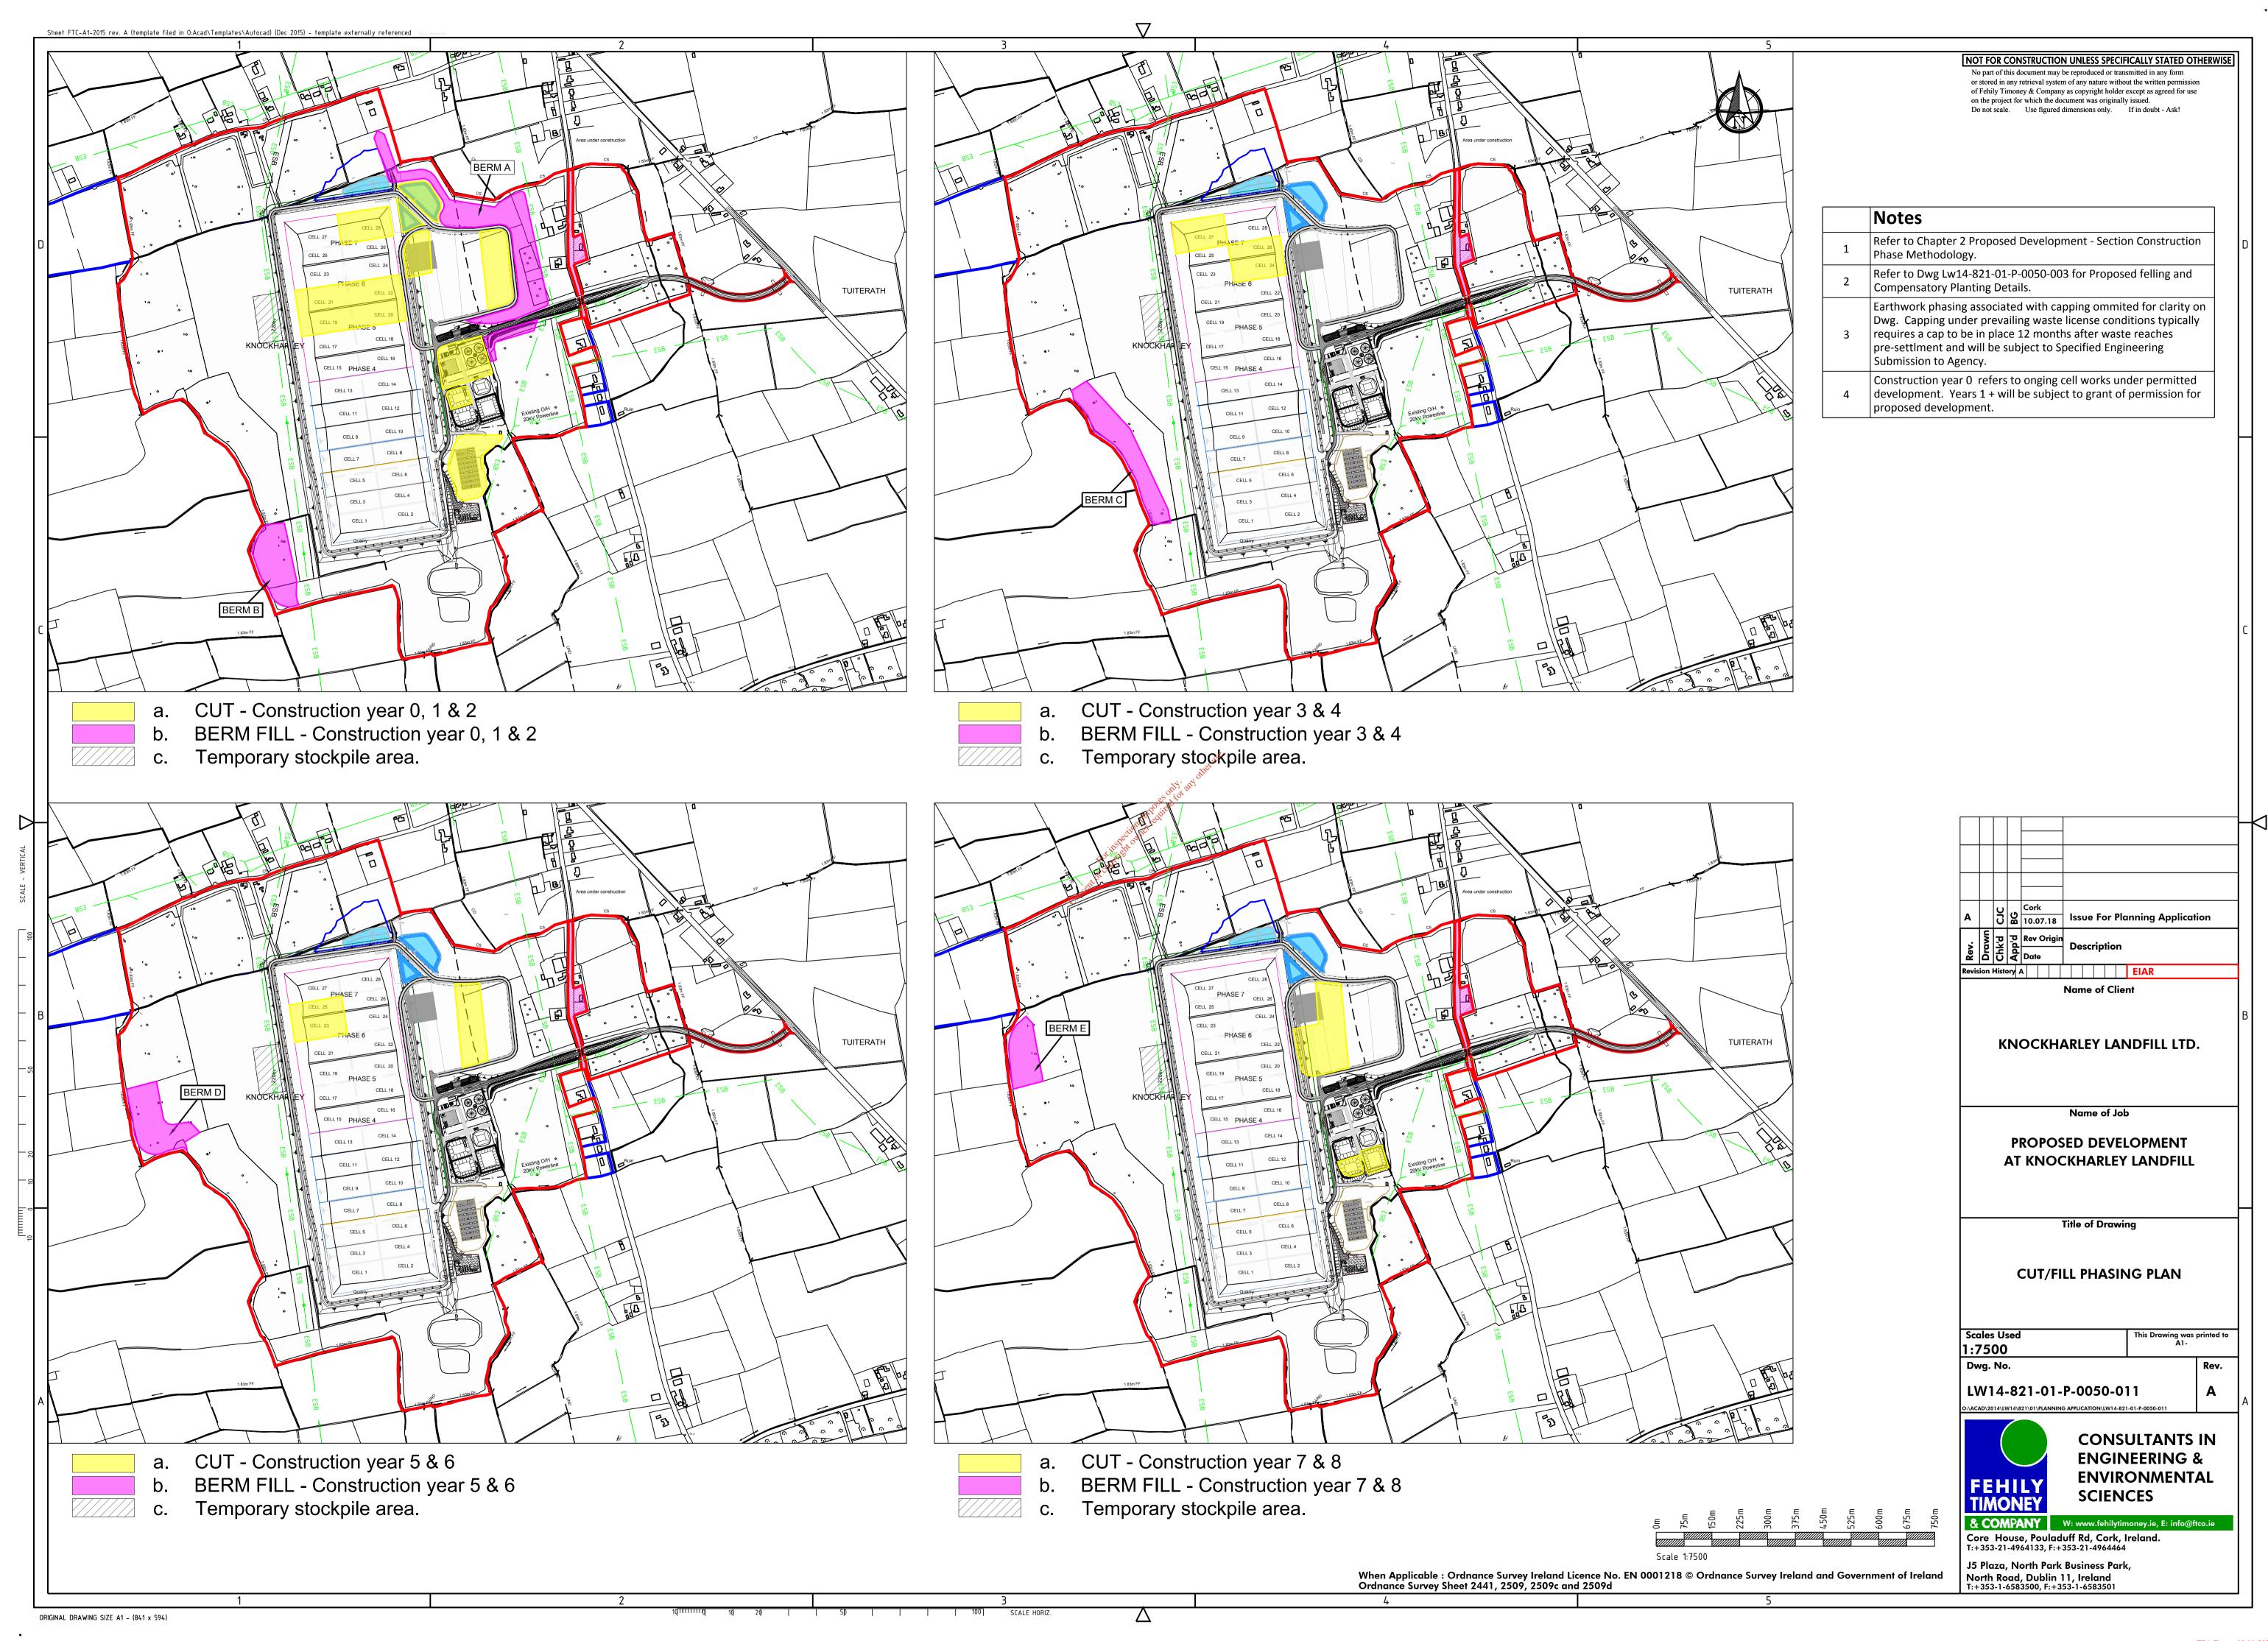




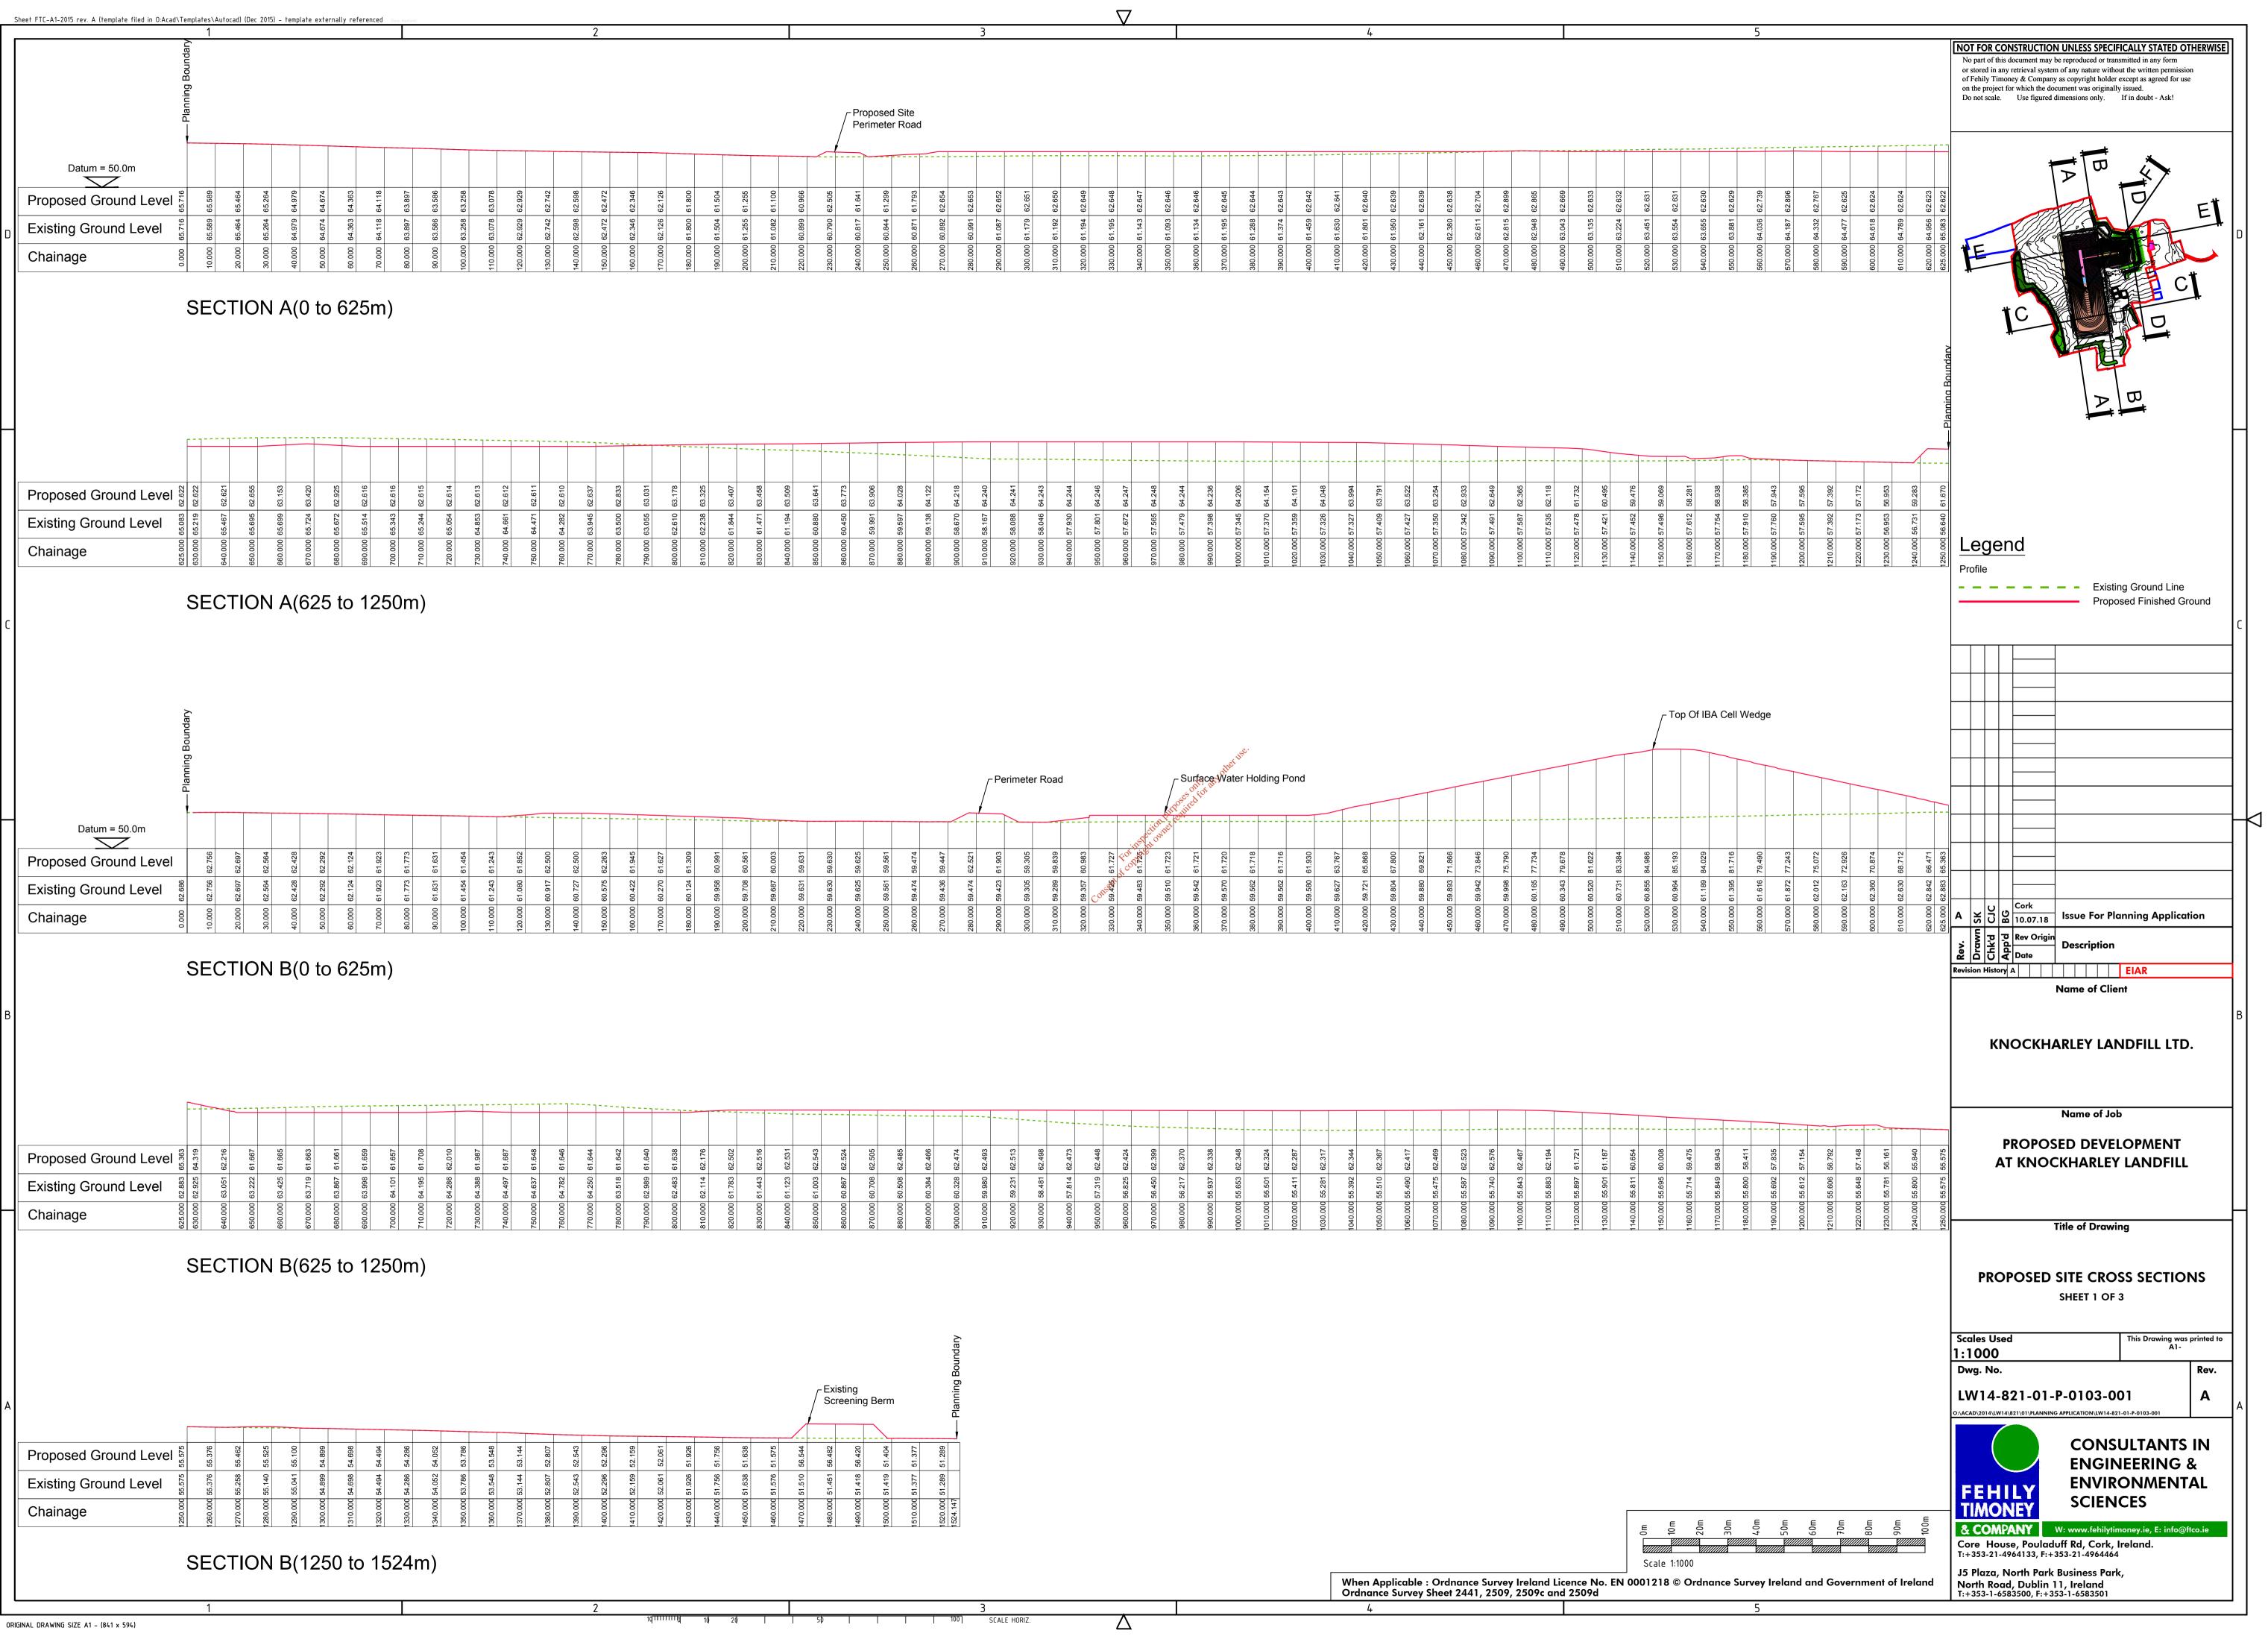




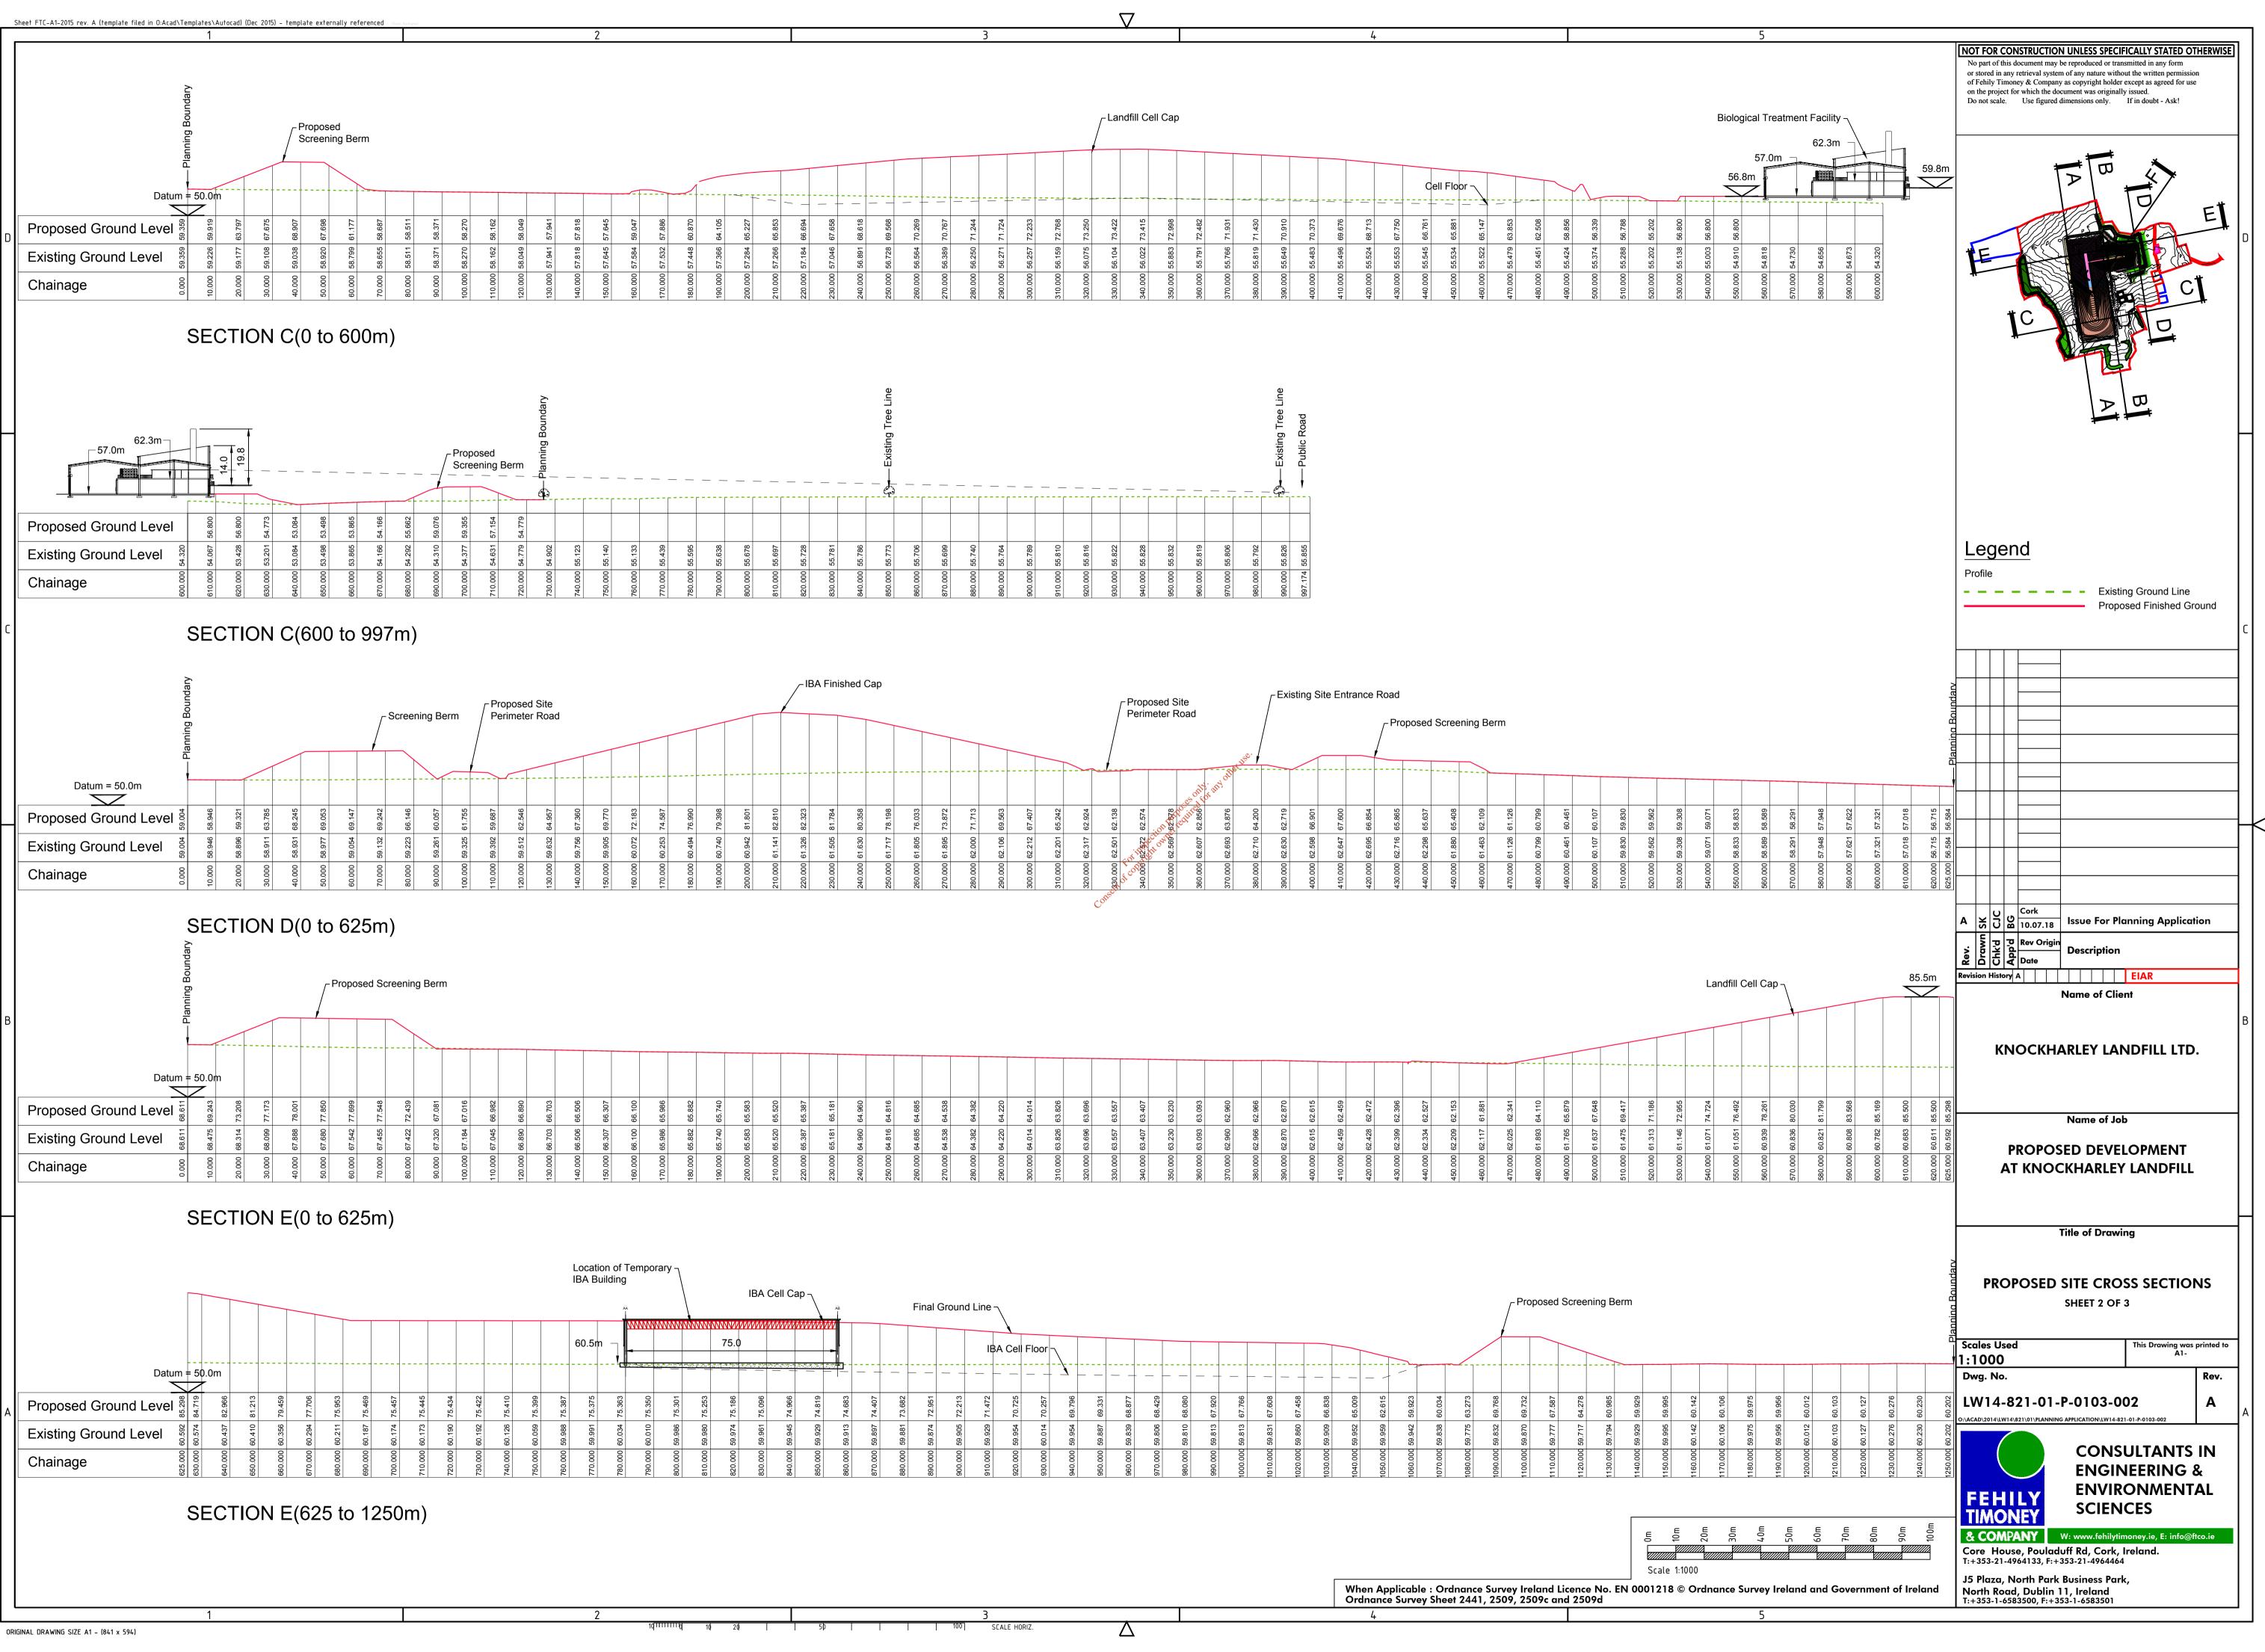




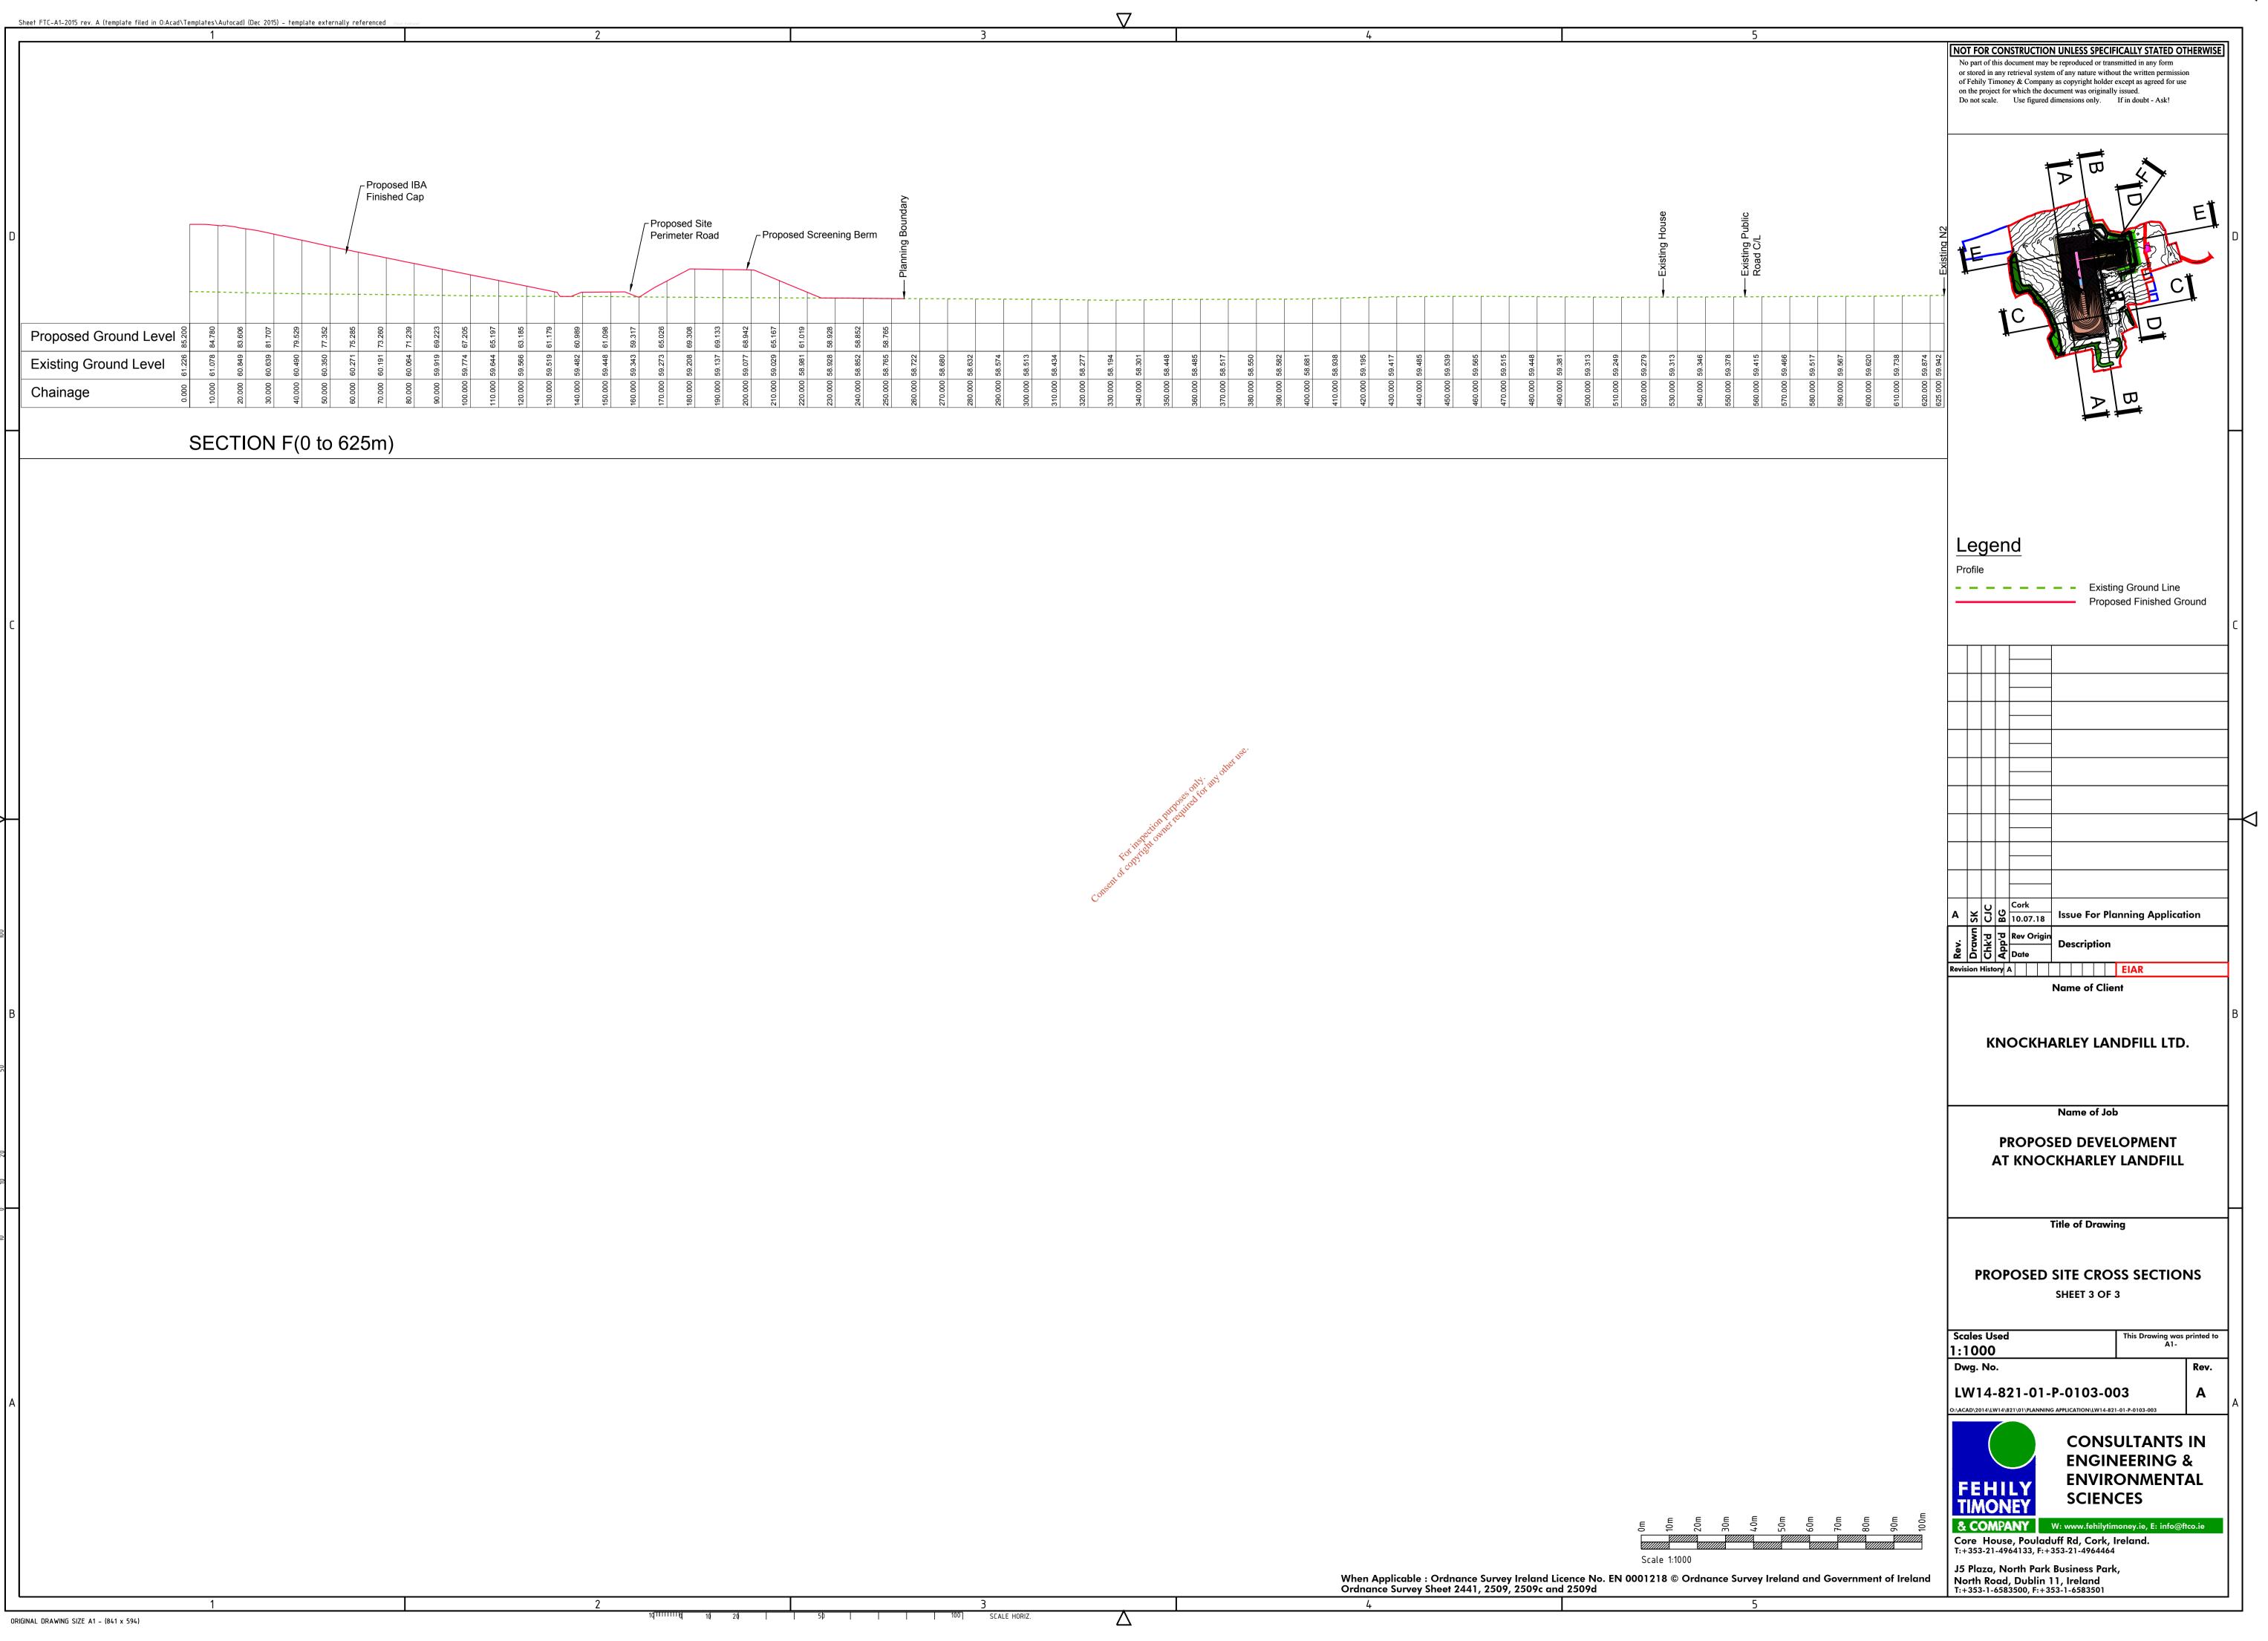




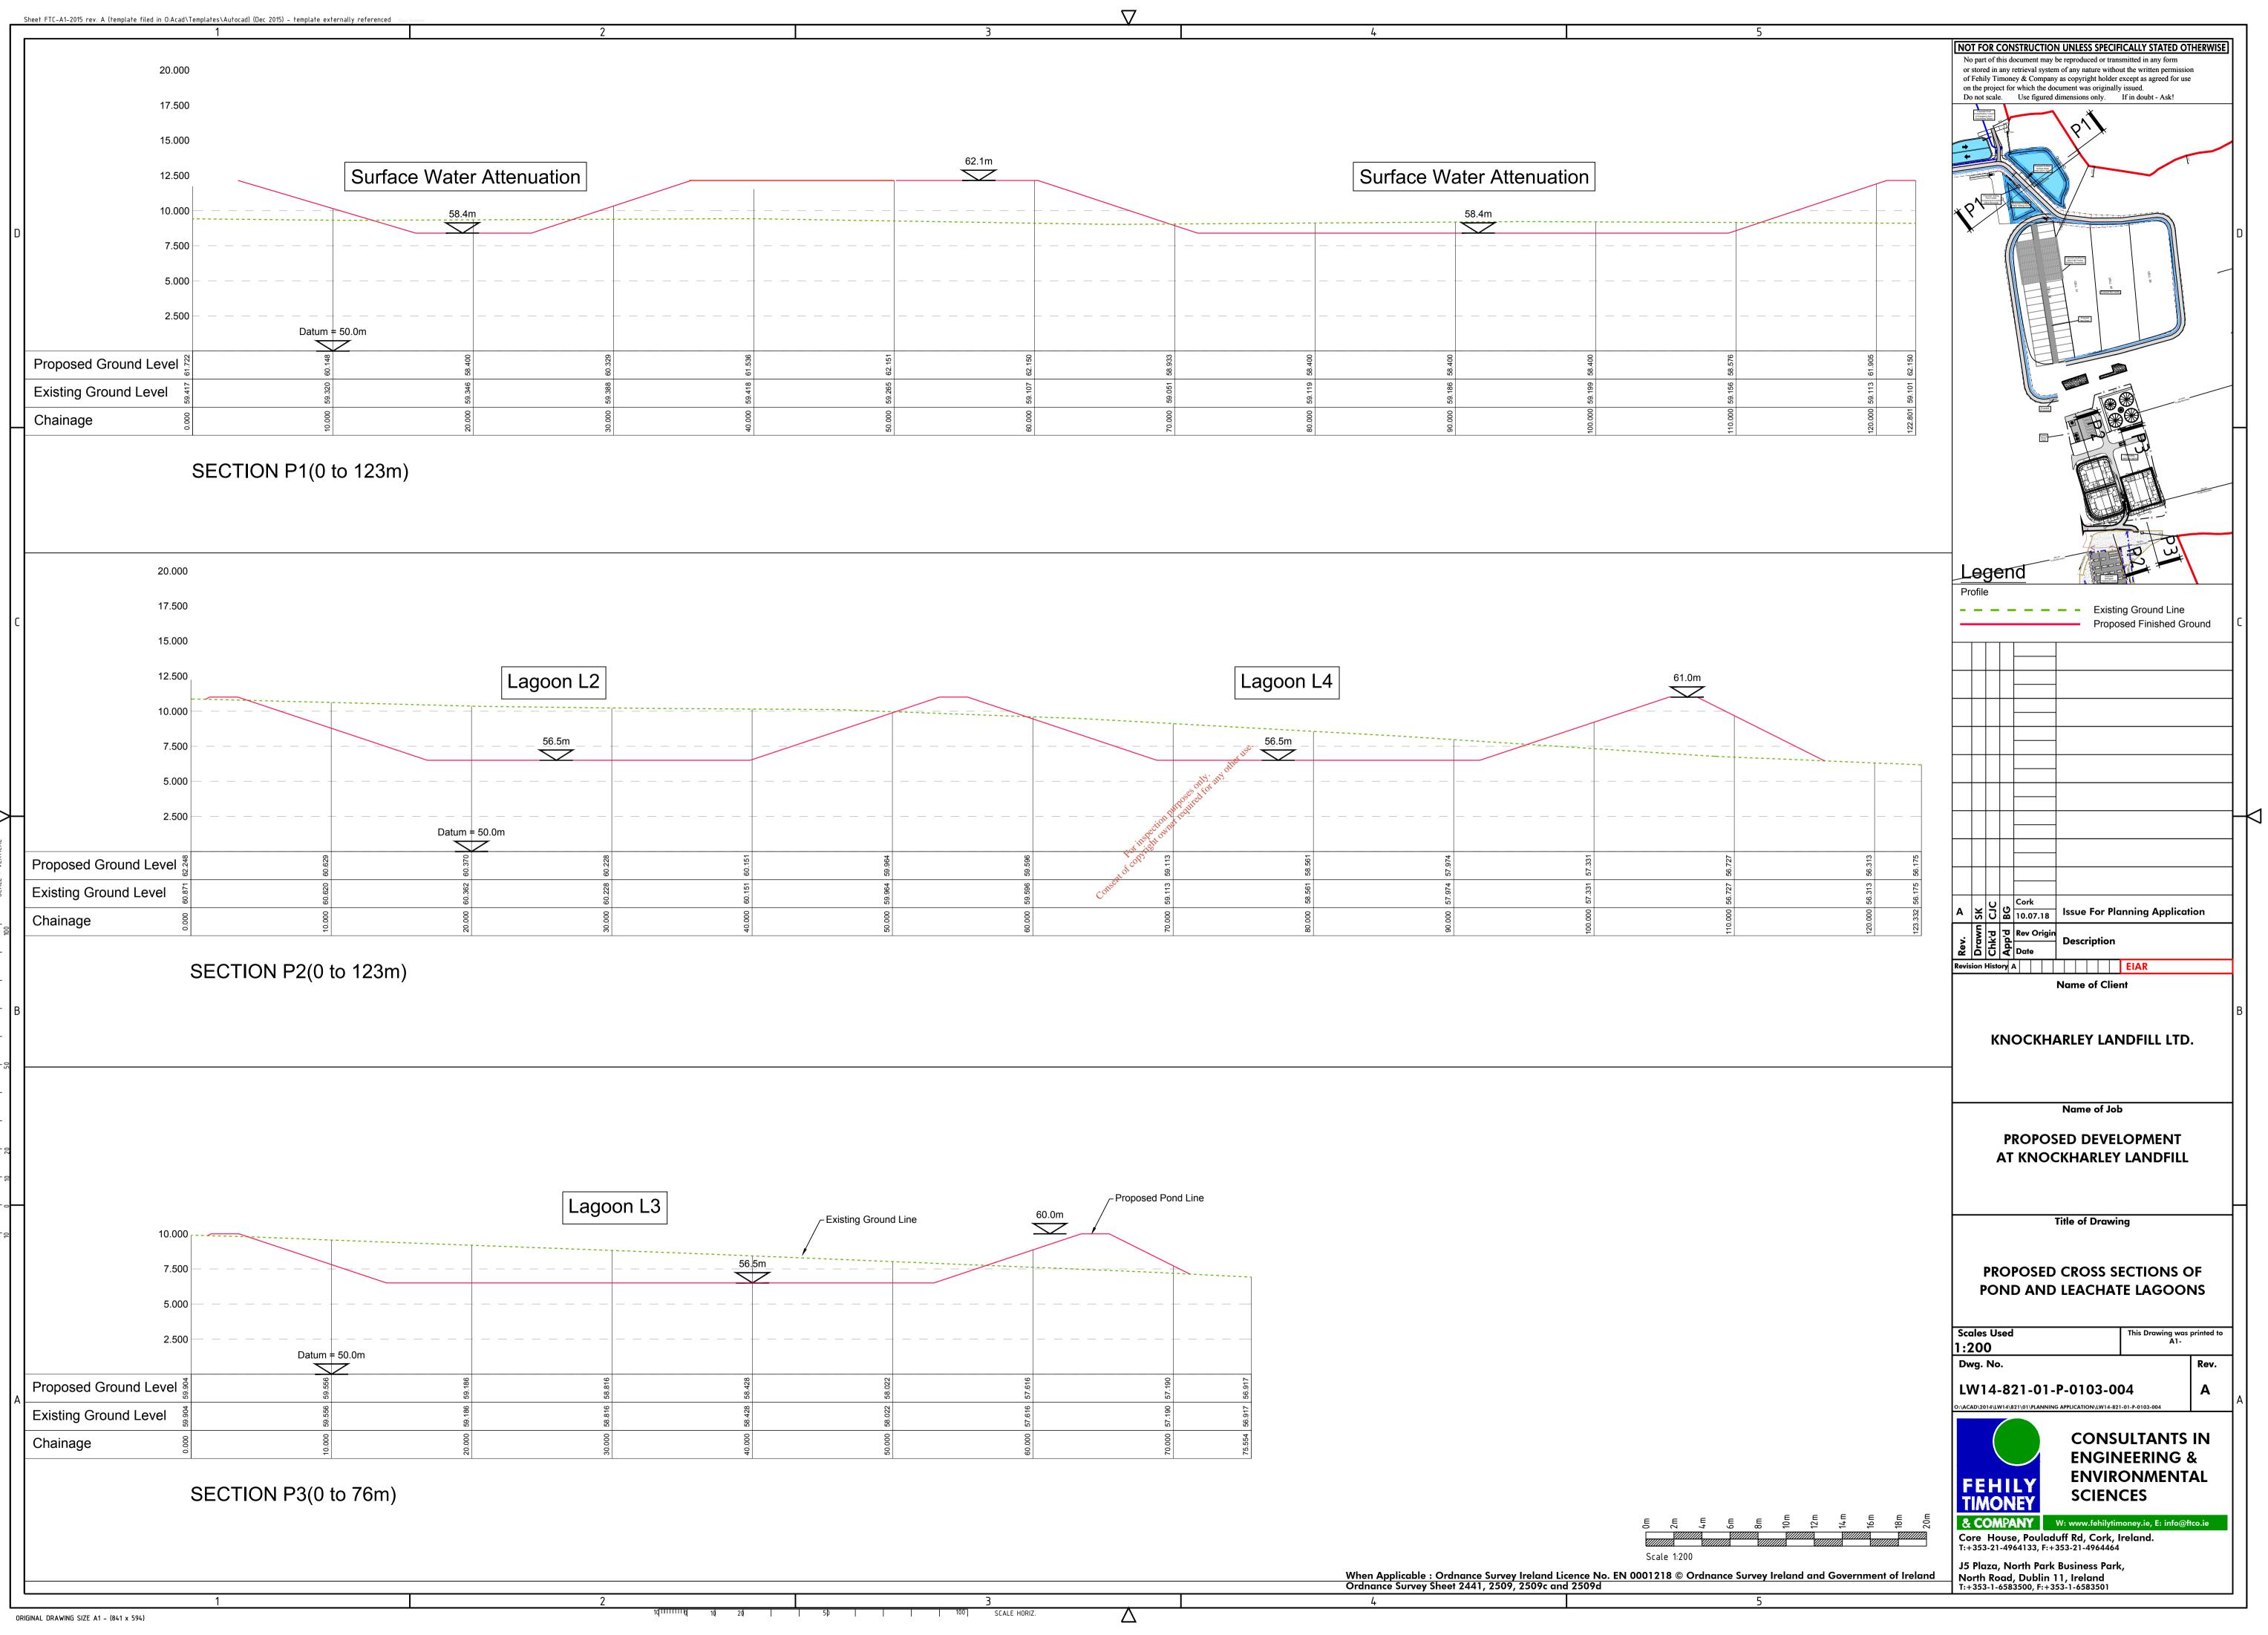
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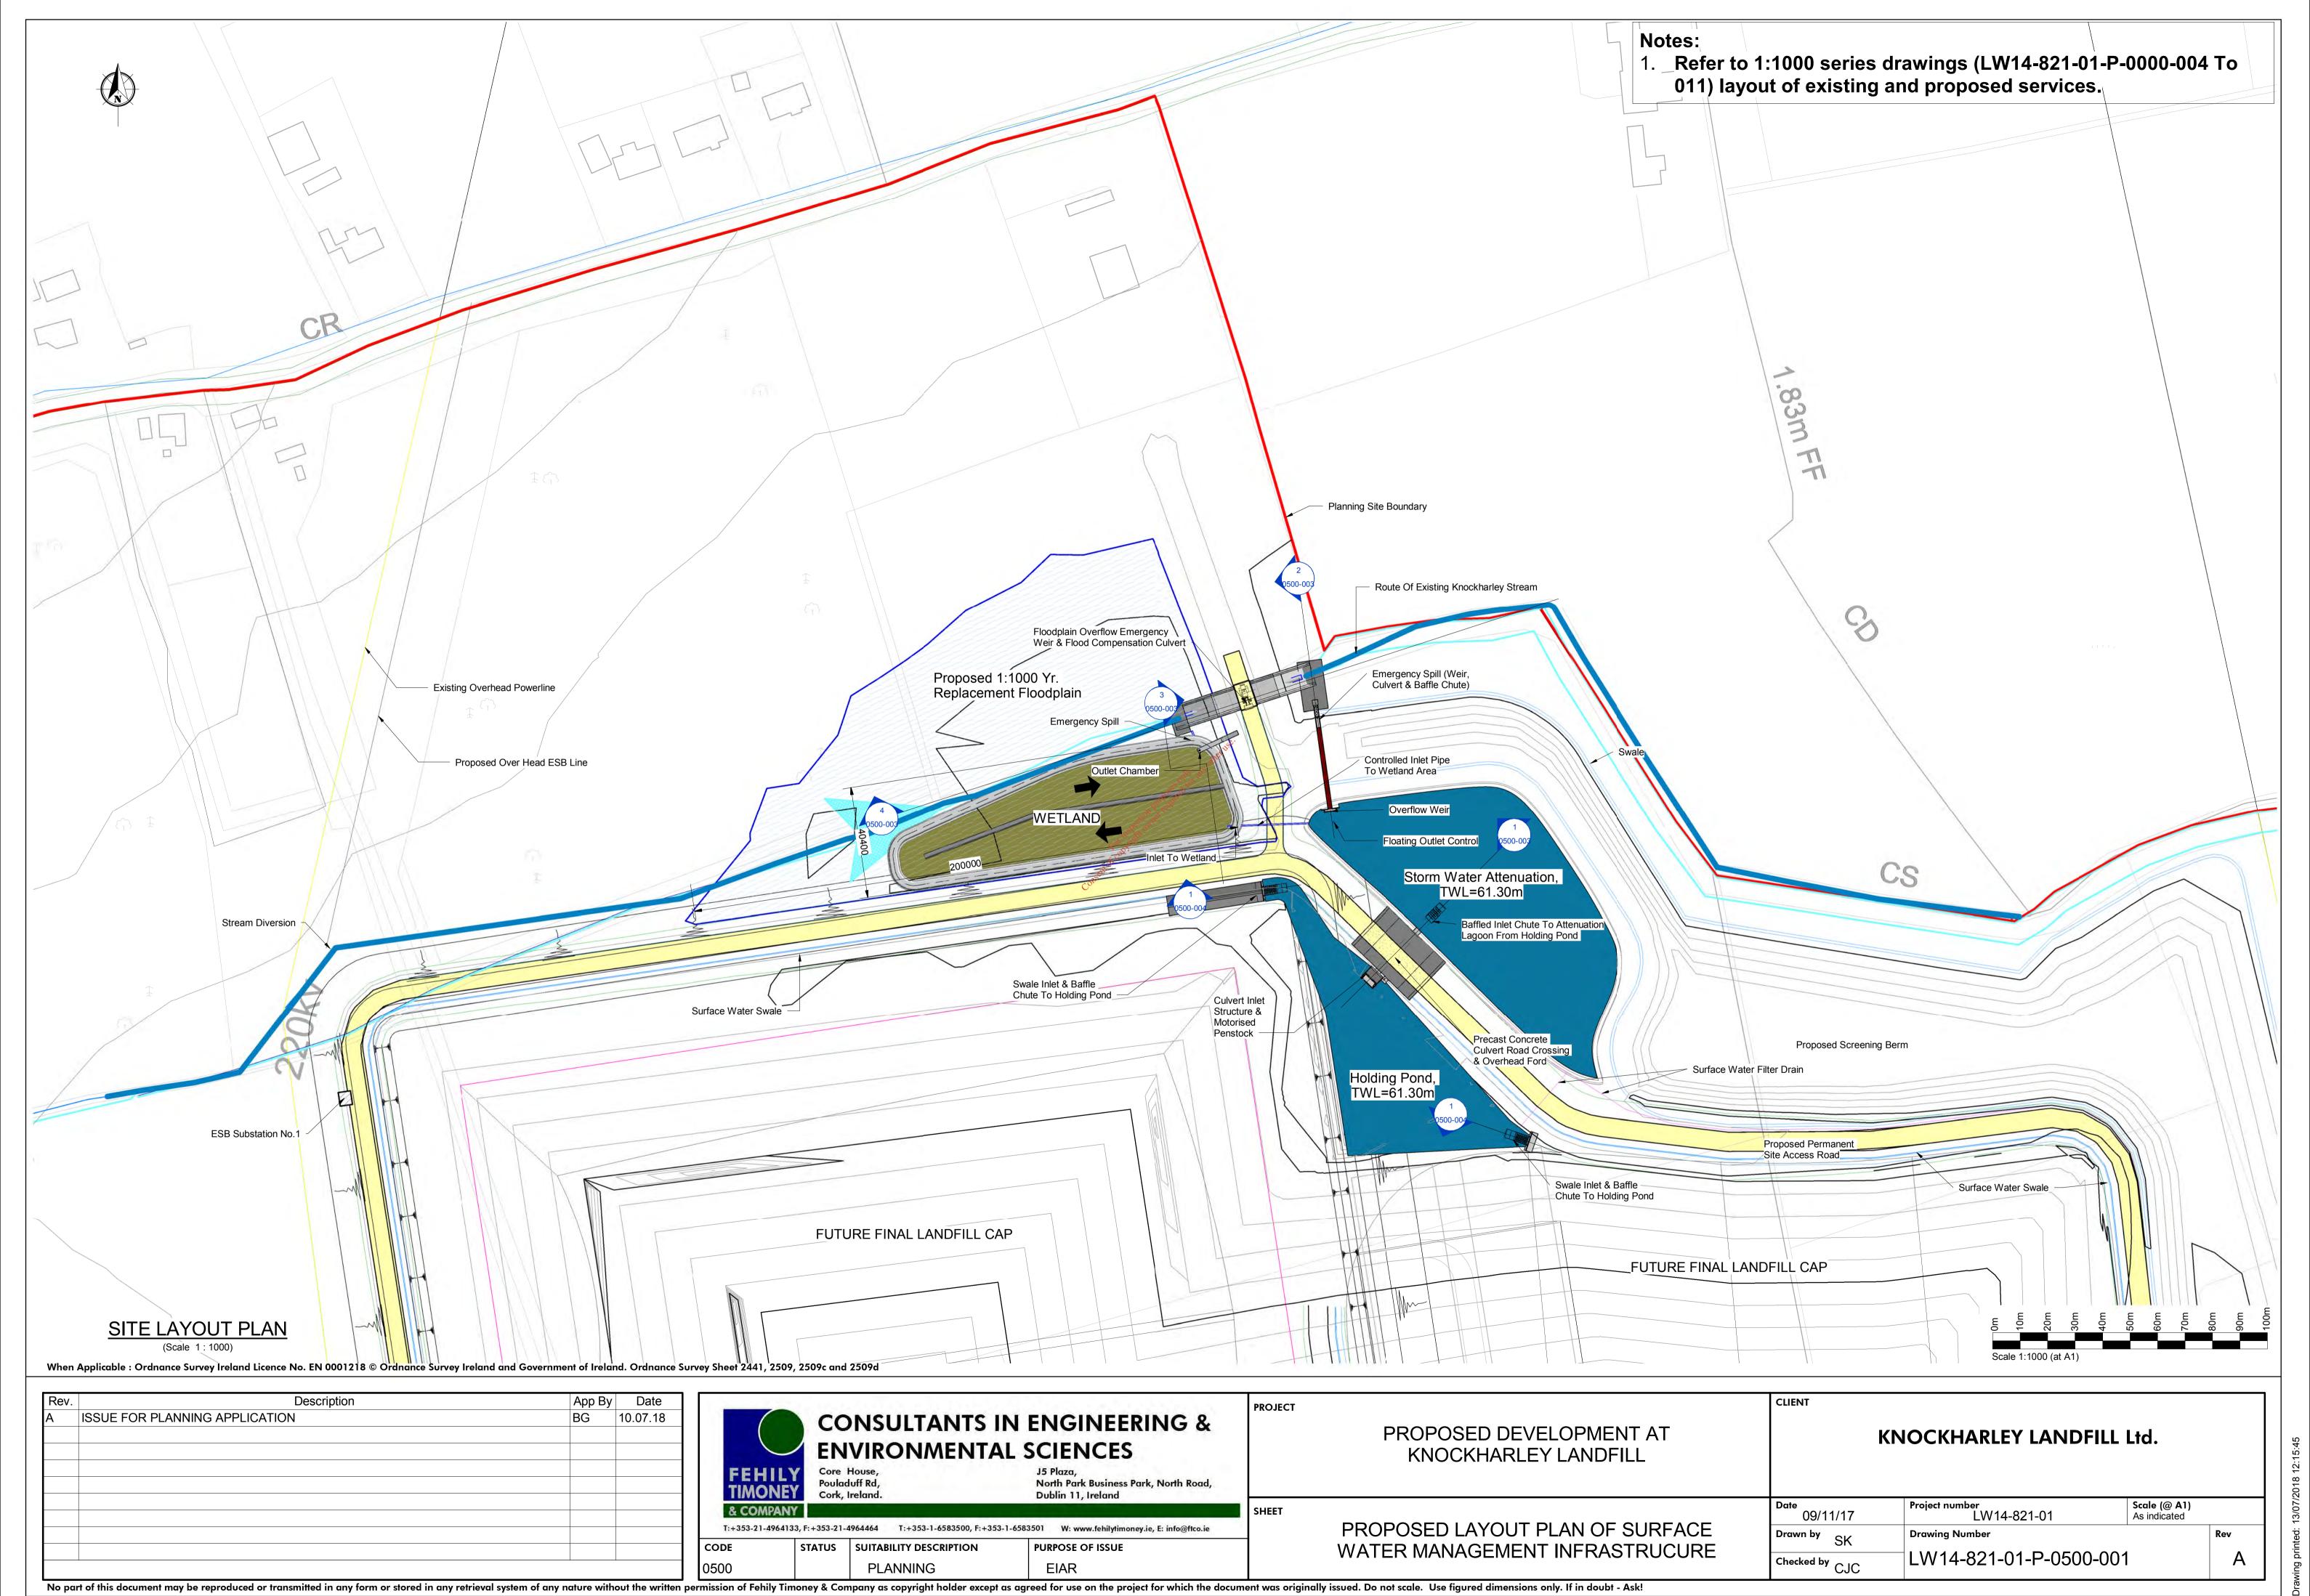
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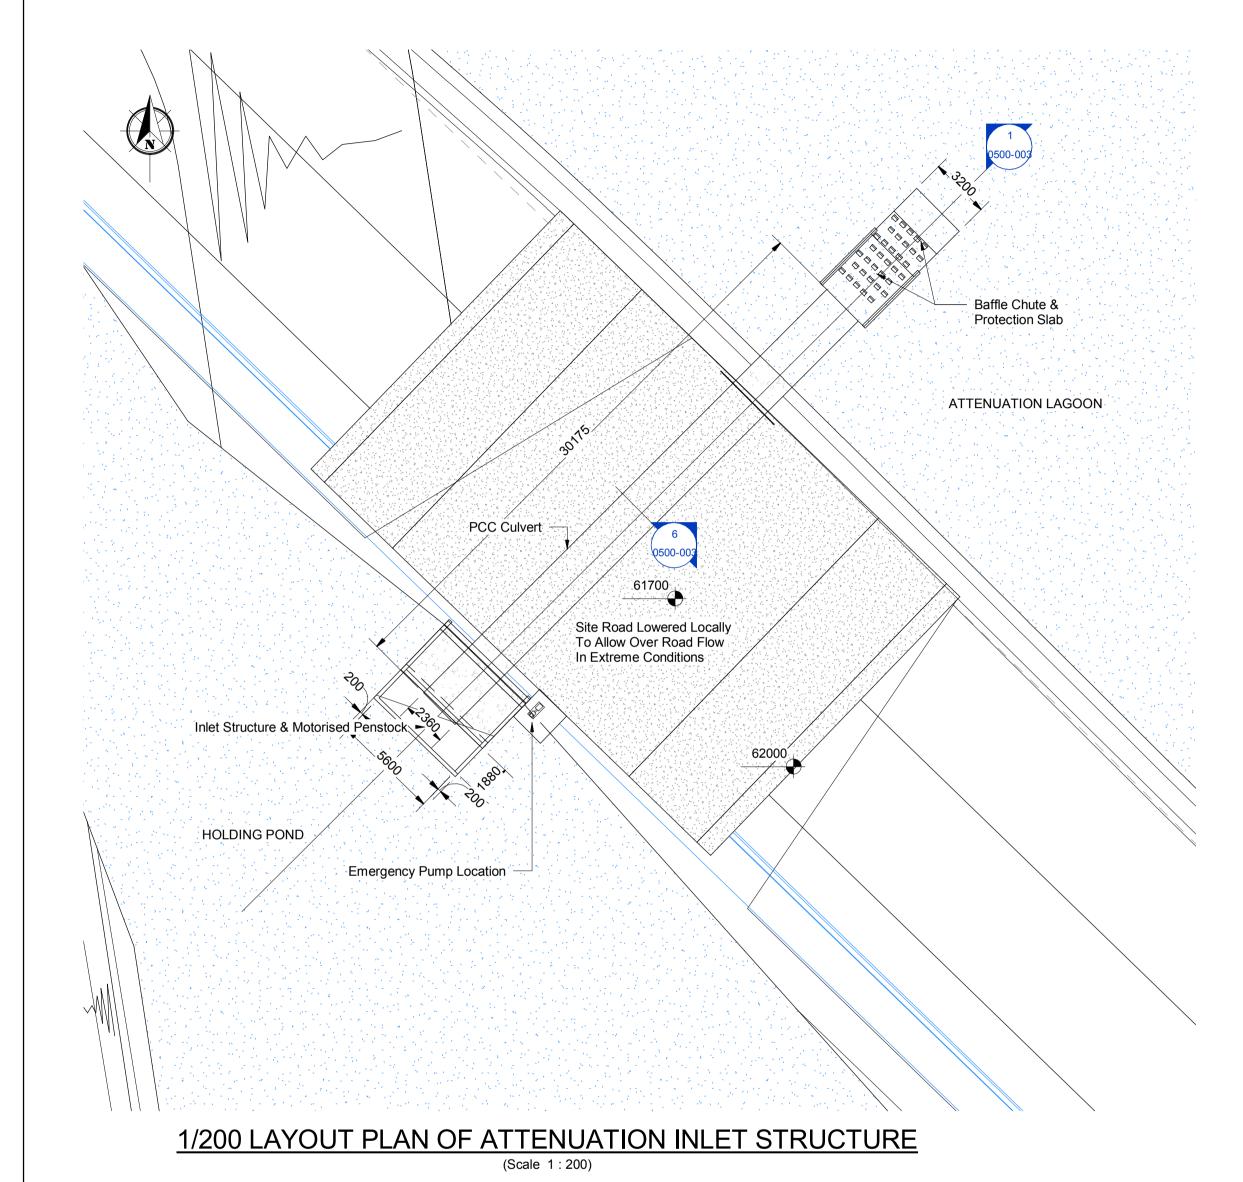


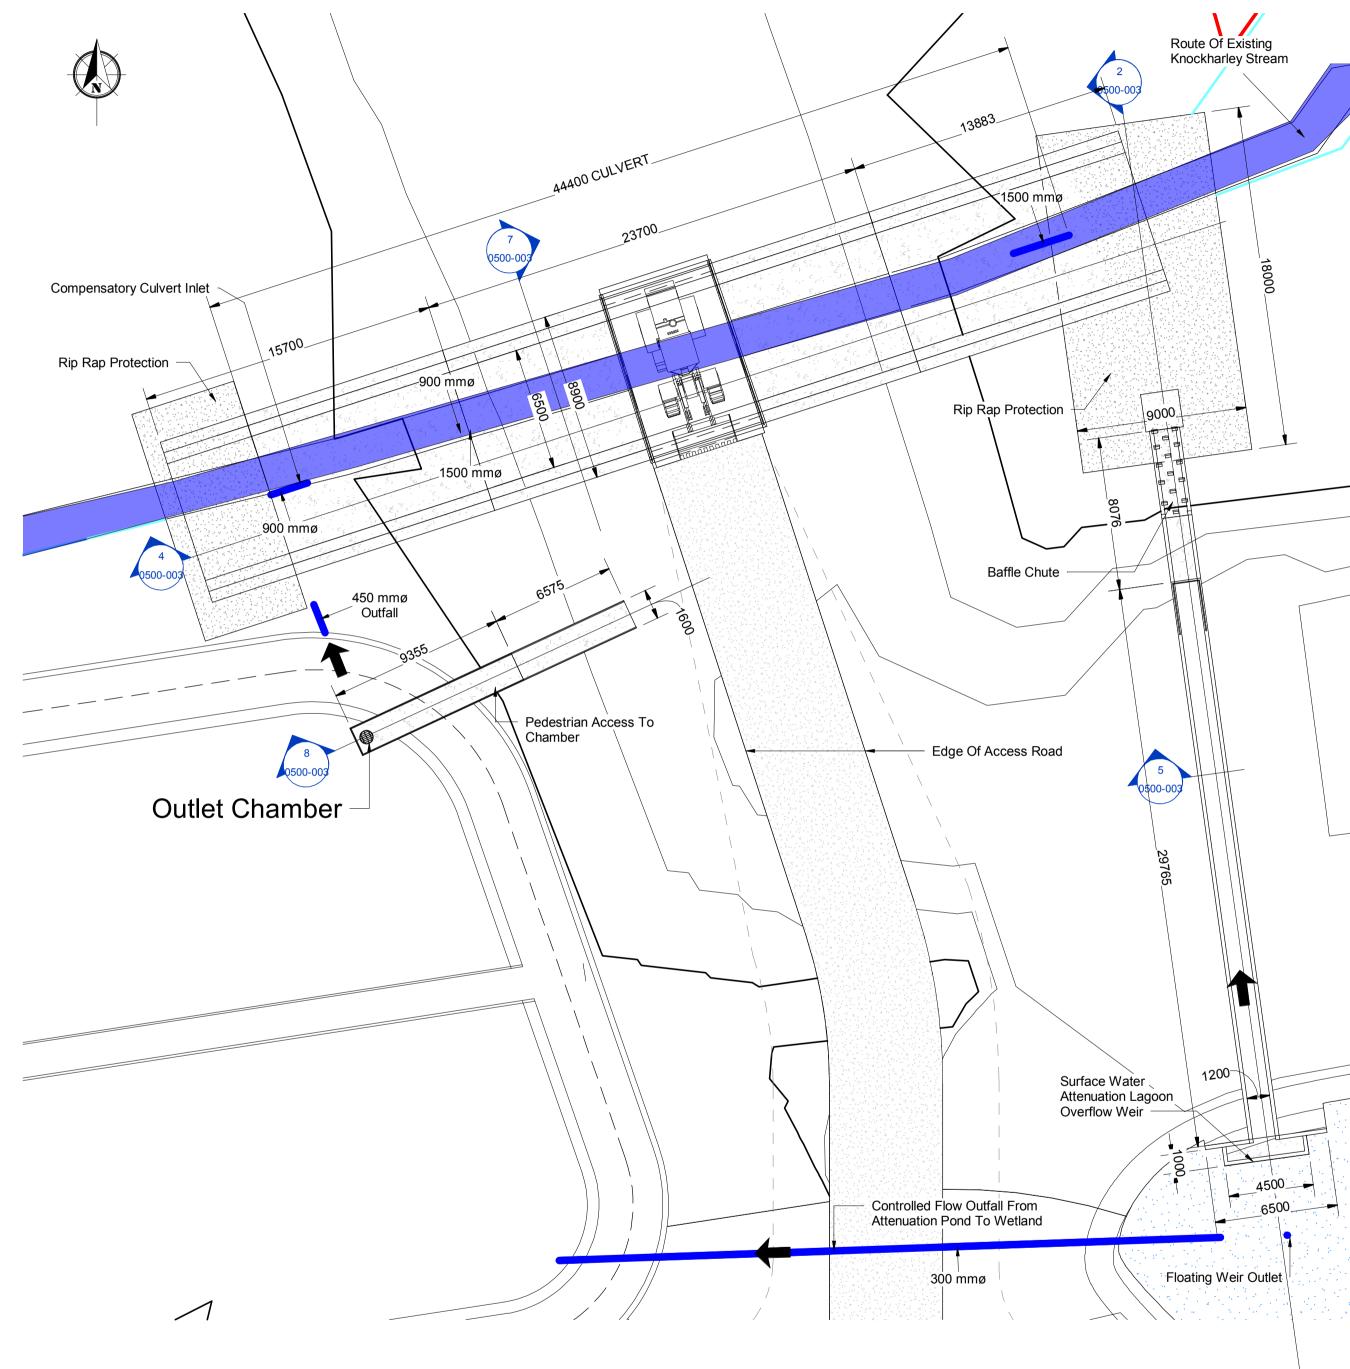
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## Notes:

1. Refer to 1:1000 series drawings (LW14-821-01-P-0000-004 To 011) layout of existing and proposed services.





1/200 LAYOUT PLAN OF FLOODPLAIN OVERFLOW WEIR AND ATTENUATION POND OVERFLOW



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Rev.	Description	App By	Date
4	ISSUE FOR PLANNING APPLICATION	BG	10.07.18

		NSULTANTS II	N ENGINEERING & L SCIENCES	PROJECT
	Core Poula	House, duff Rd, Ireland.	J5 Plaza, North Park Business Park, North Road, Dublin 11, Ireland	
	-4964133, F: +353-21-	4964464 T:+353-1-6583500, F:+353-	1-6583501 W: www.fehilytimoney.ie, E: info@ftco.ie	SHEET
0500	STATUS	SUITABILITY DESCRIPTION PLANNING	PURPOSE OF ISSUE EIAR	

PROPOSED DEVELOPMENT AT	
KNOCKHARLEY LANDFILL	

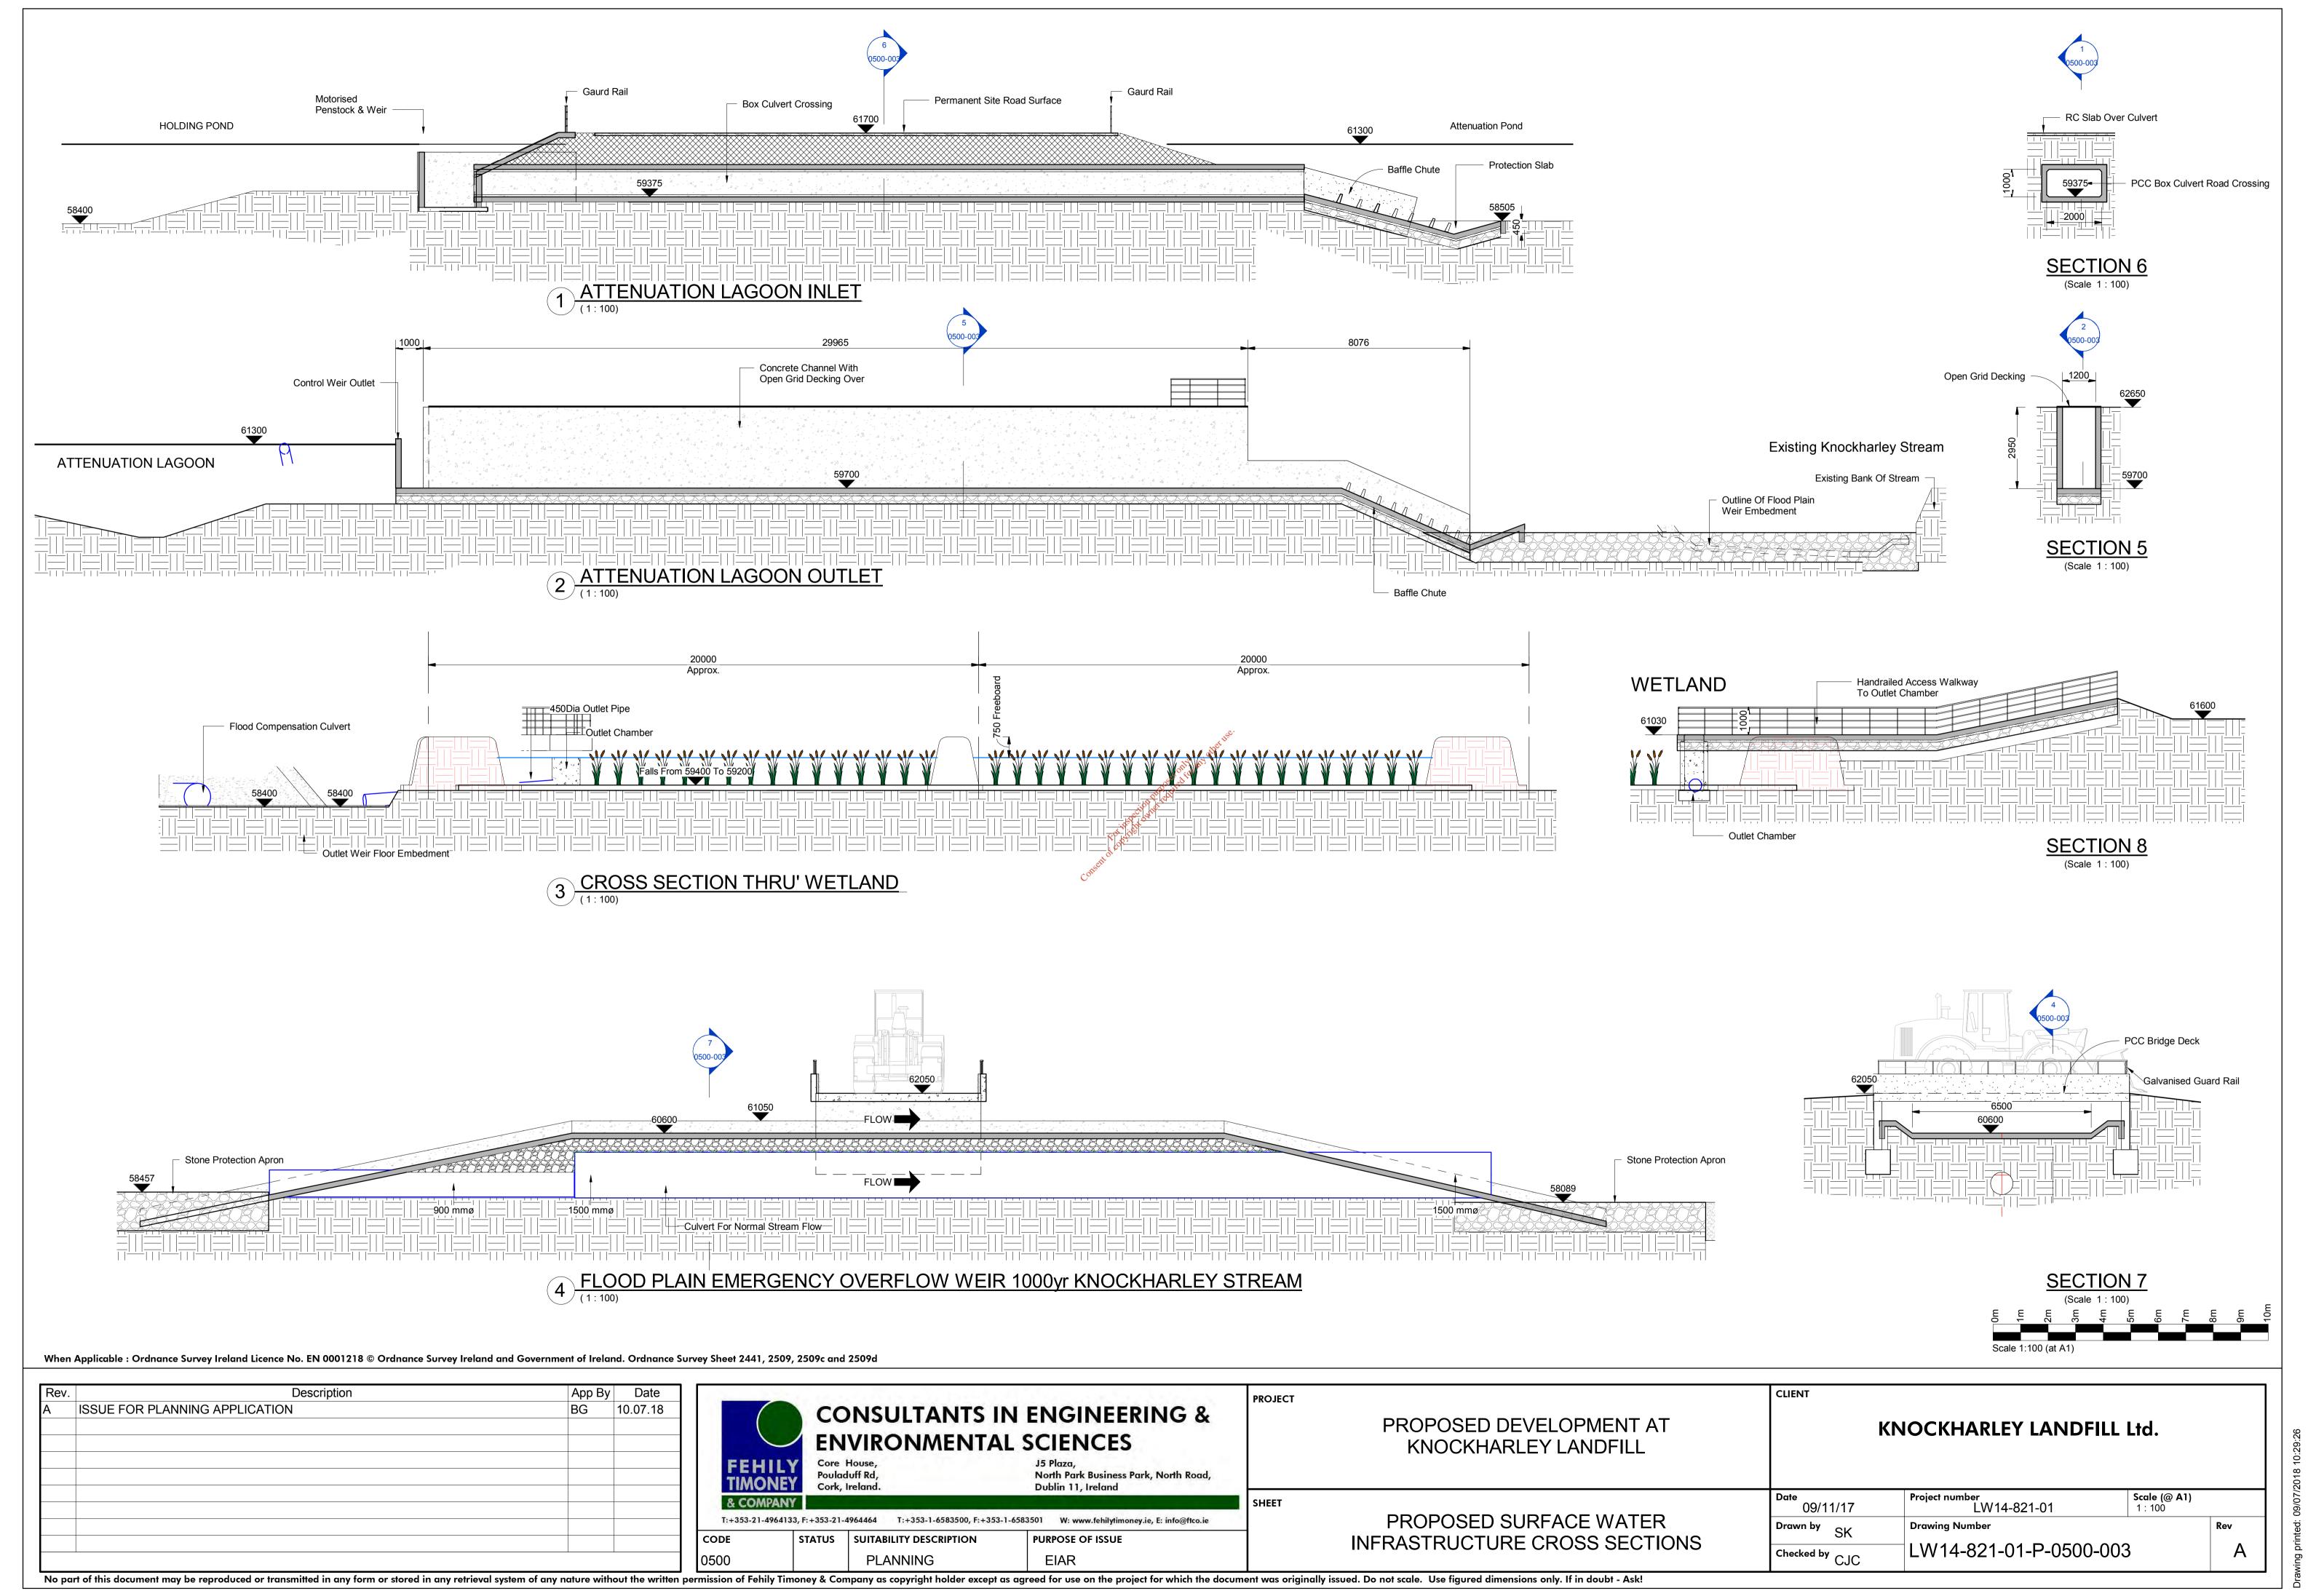
SURFACE WATER MANAGEMENT

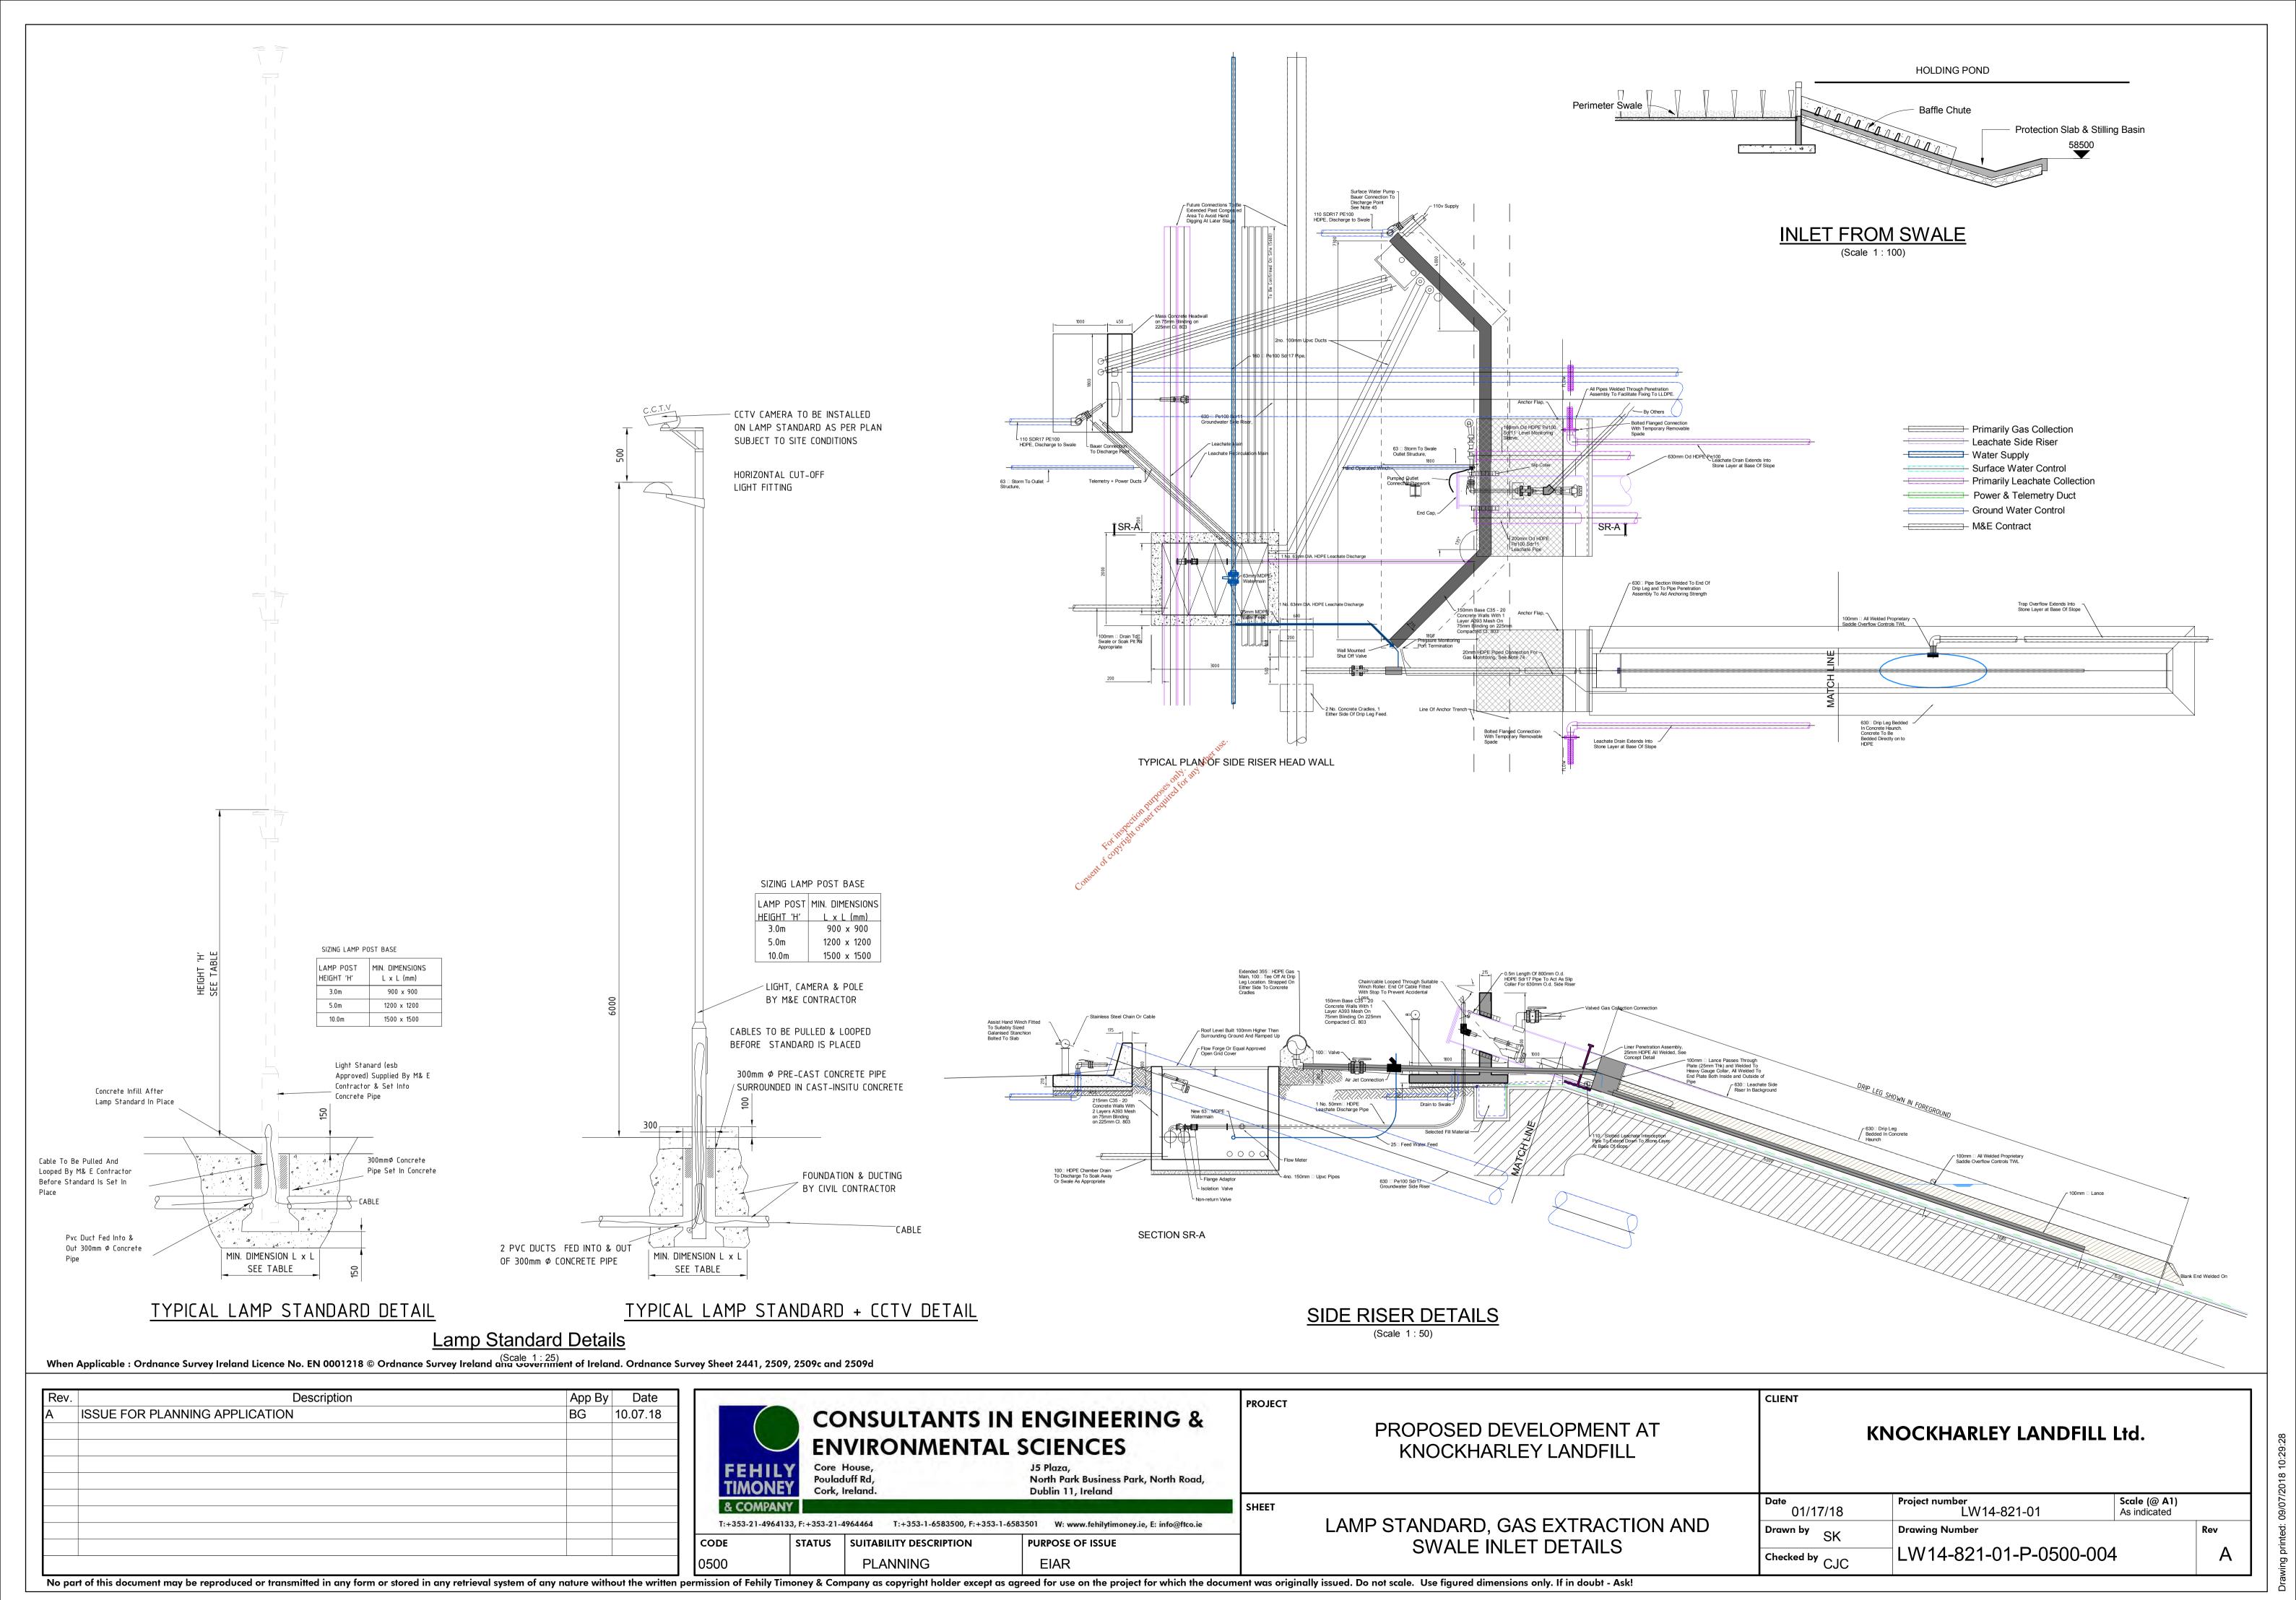
INFRASTRUCTURE LAYOUT PLANS

K	ILL Ltd.	
Date 09/11/17	Project number LW14-821-01	Scale (@ A1) As indicated

Date 09/11/17	Project number LW14-821-01	Scale (@ A1) As indicated	
Drawn by SK	Drawing Number		Rev
Checked by C.I.C. LW14-821-01-P-0500-002			

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### SILT FENCE DETAILS

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Rev.	Description	App By	Date
A	ISSUE FOR PLANNING APPLICATION	BG	10.07.18

		NSULTANTS I	N ENGINEERING & L SCIENCES	PROJEC
FEHILY	Poula	House, duff Rd, Ireland.	J5 Plaza, North Park Business Park, North Road, Dublin 11, Ireland	
& COMPANY T:+353-21-496413		4964464 T:+353-1-6583500, F:+353	-1-6583501 W: www.fehilytimoney.ie, E: info@ftco.ie	SHEET
CODE	STATUS	SUITABILITY DESCRIPTION	PURPOSE OF ISSUE	

PROPOSED DEVELOPMENT AT KNOCKHARLEY LANDFILL

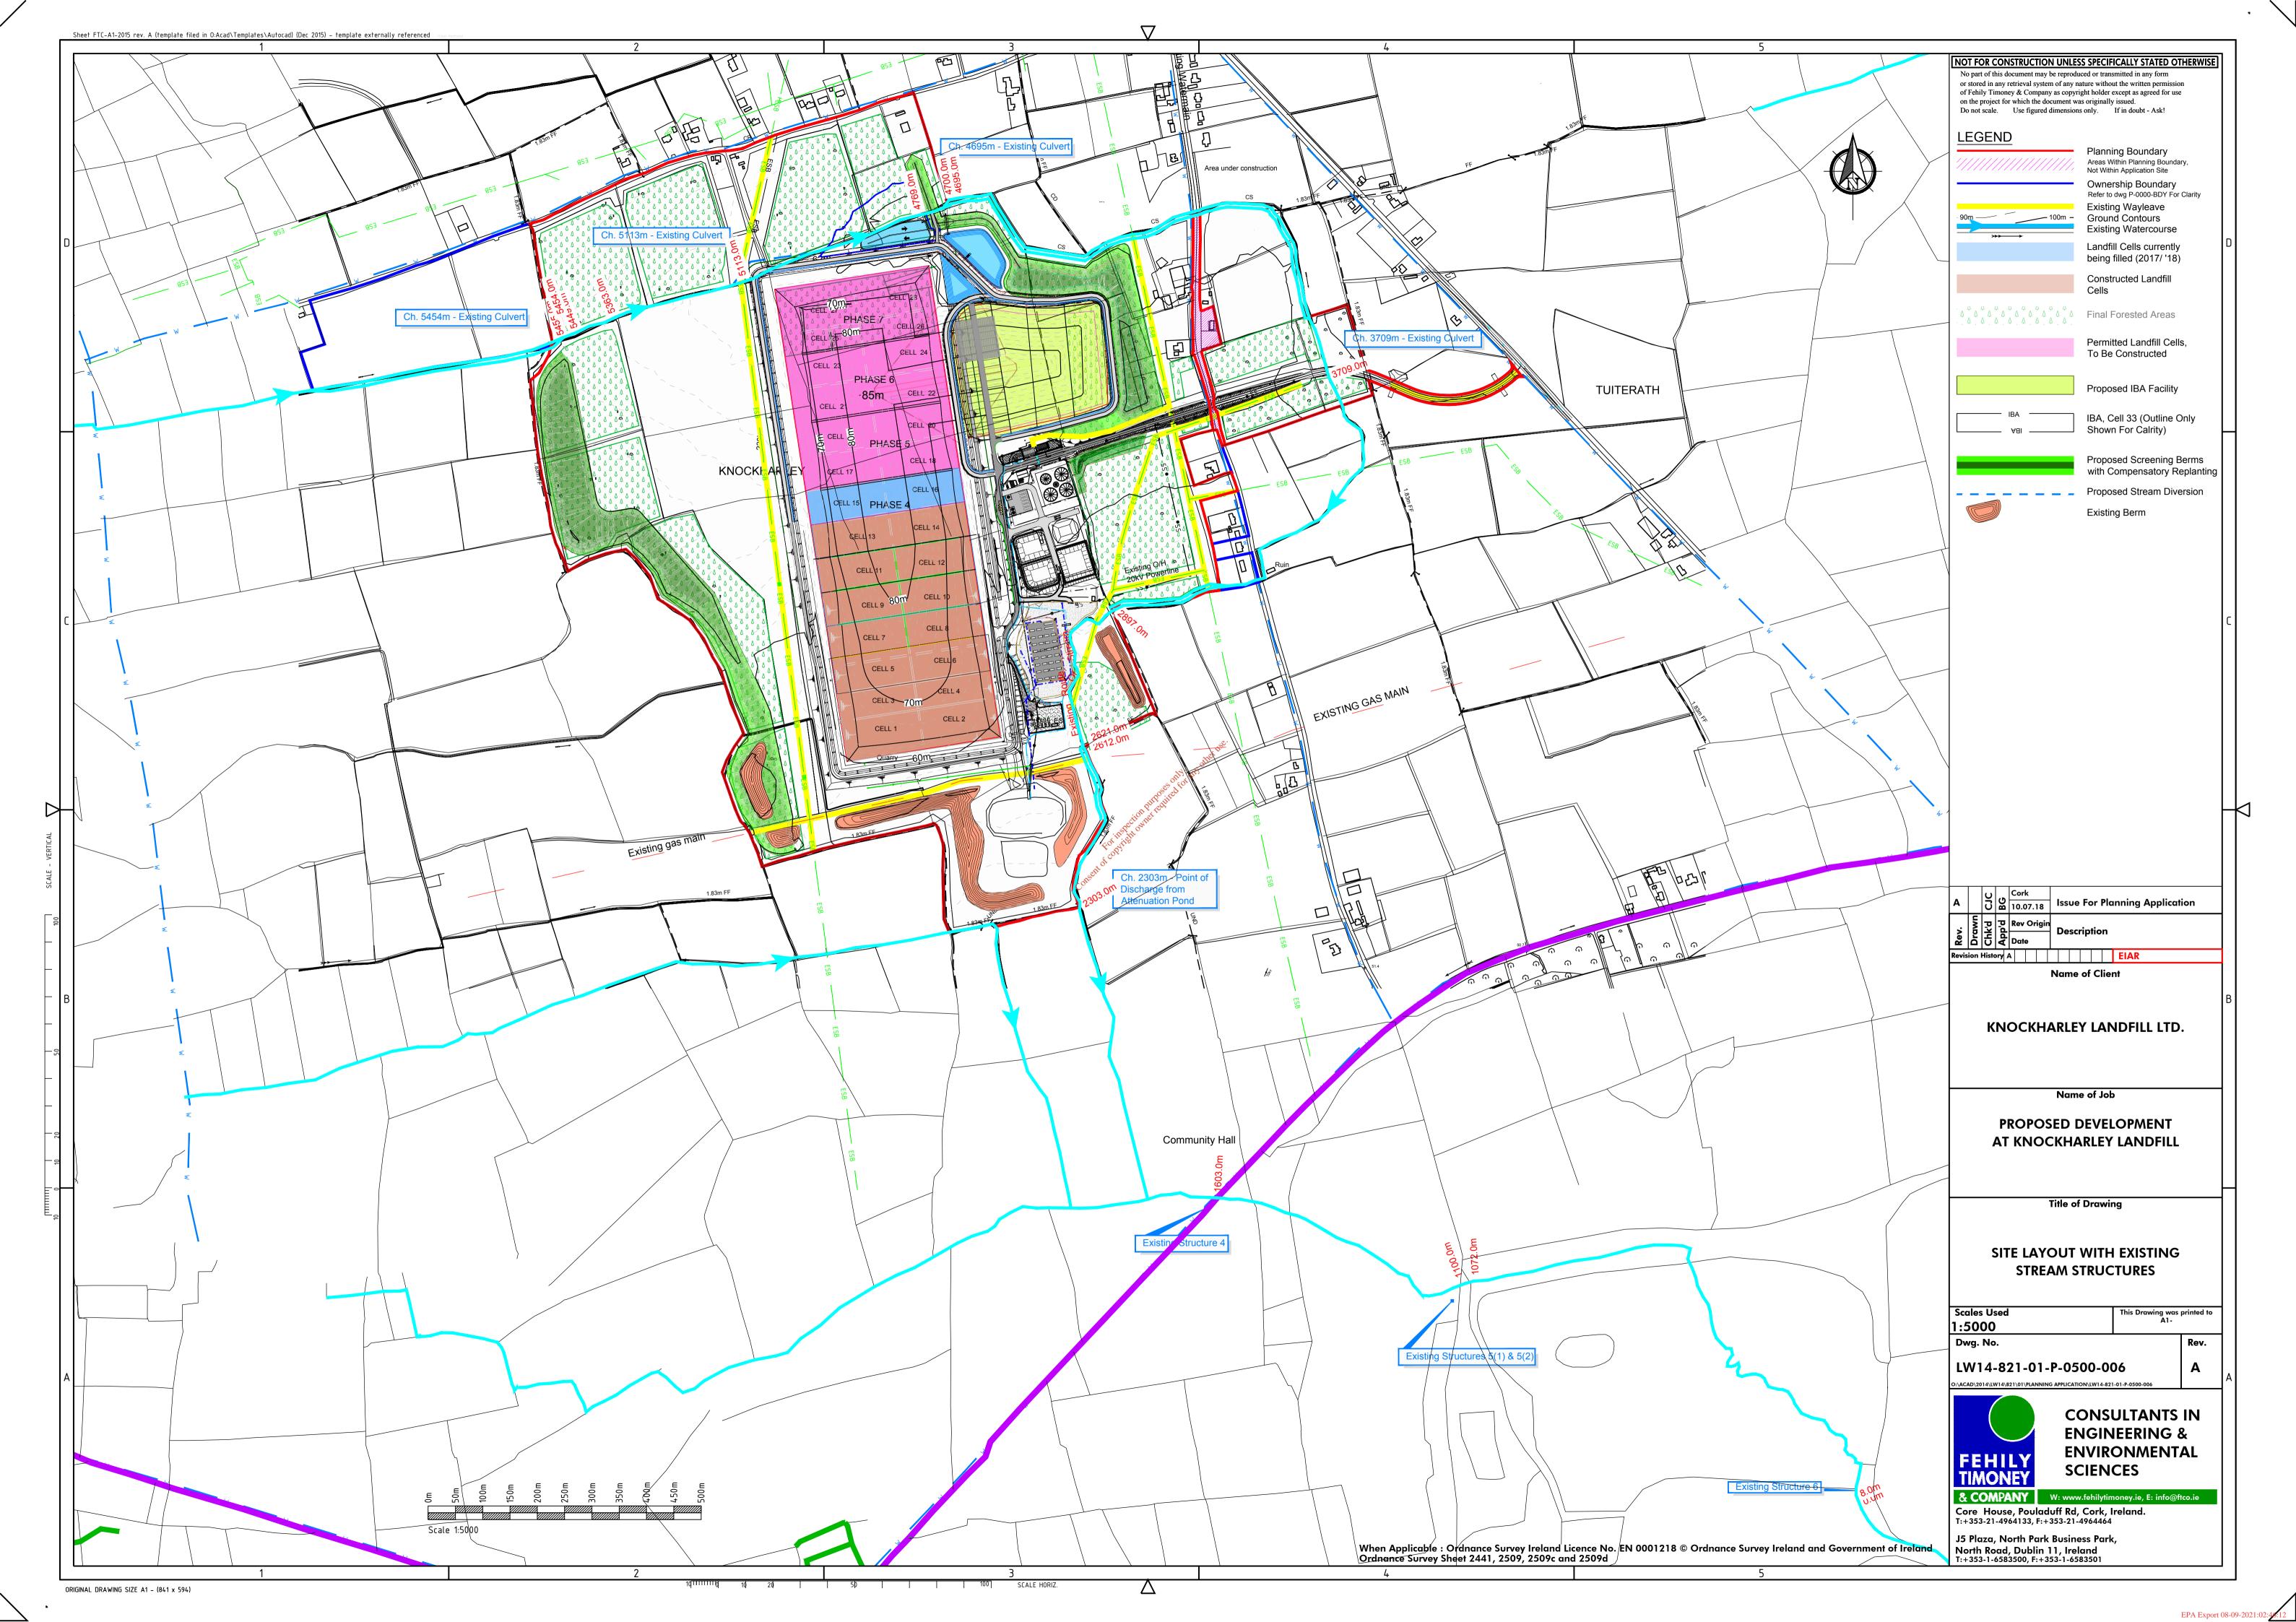
DETAILS OF SILT FENCE

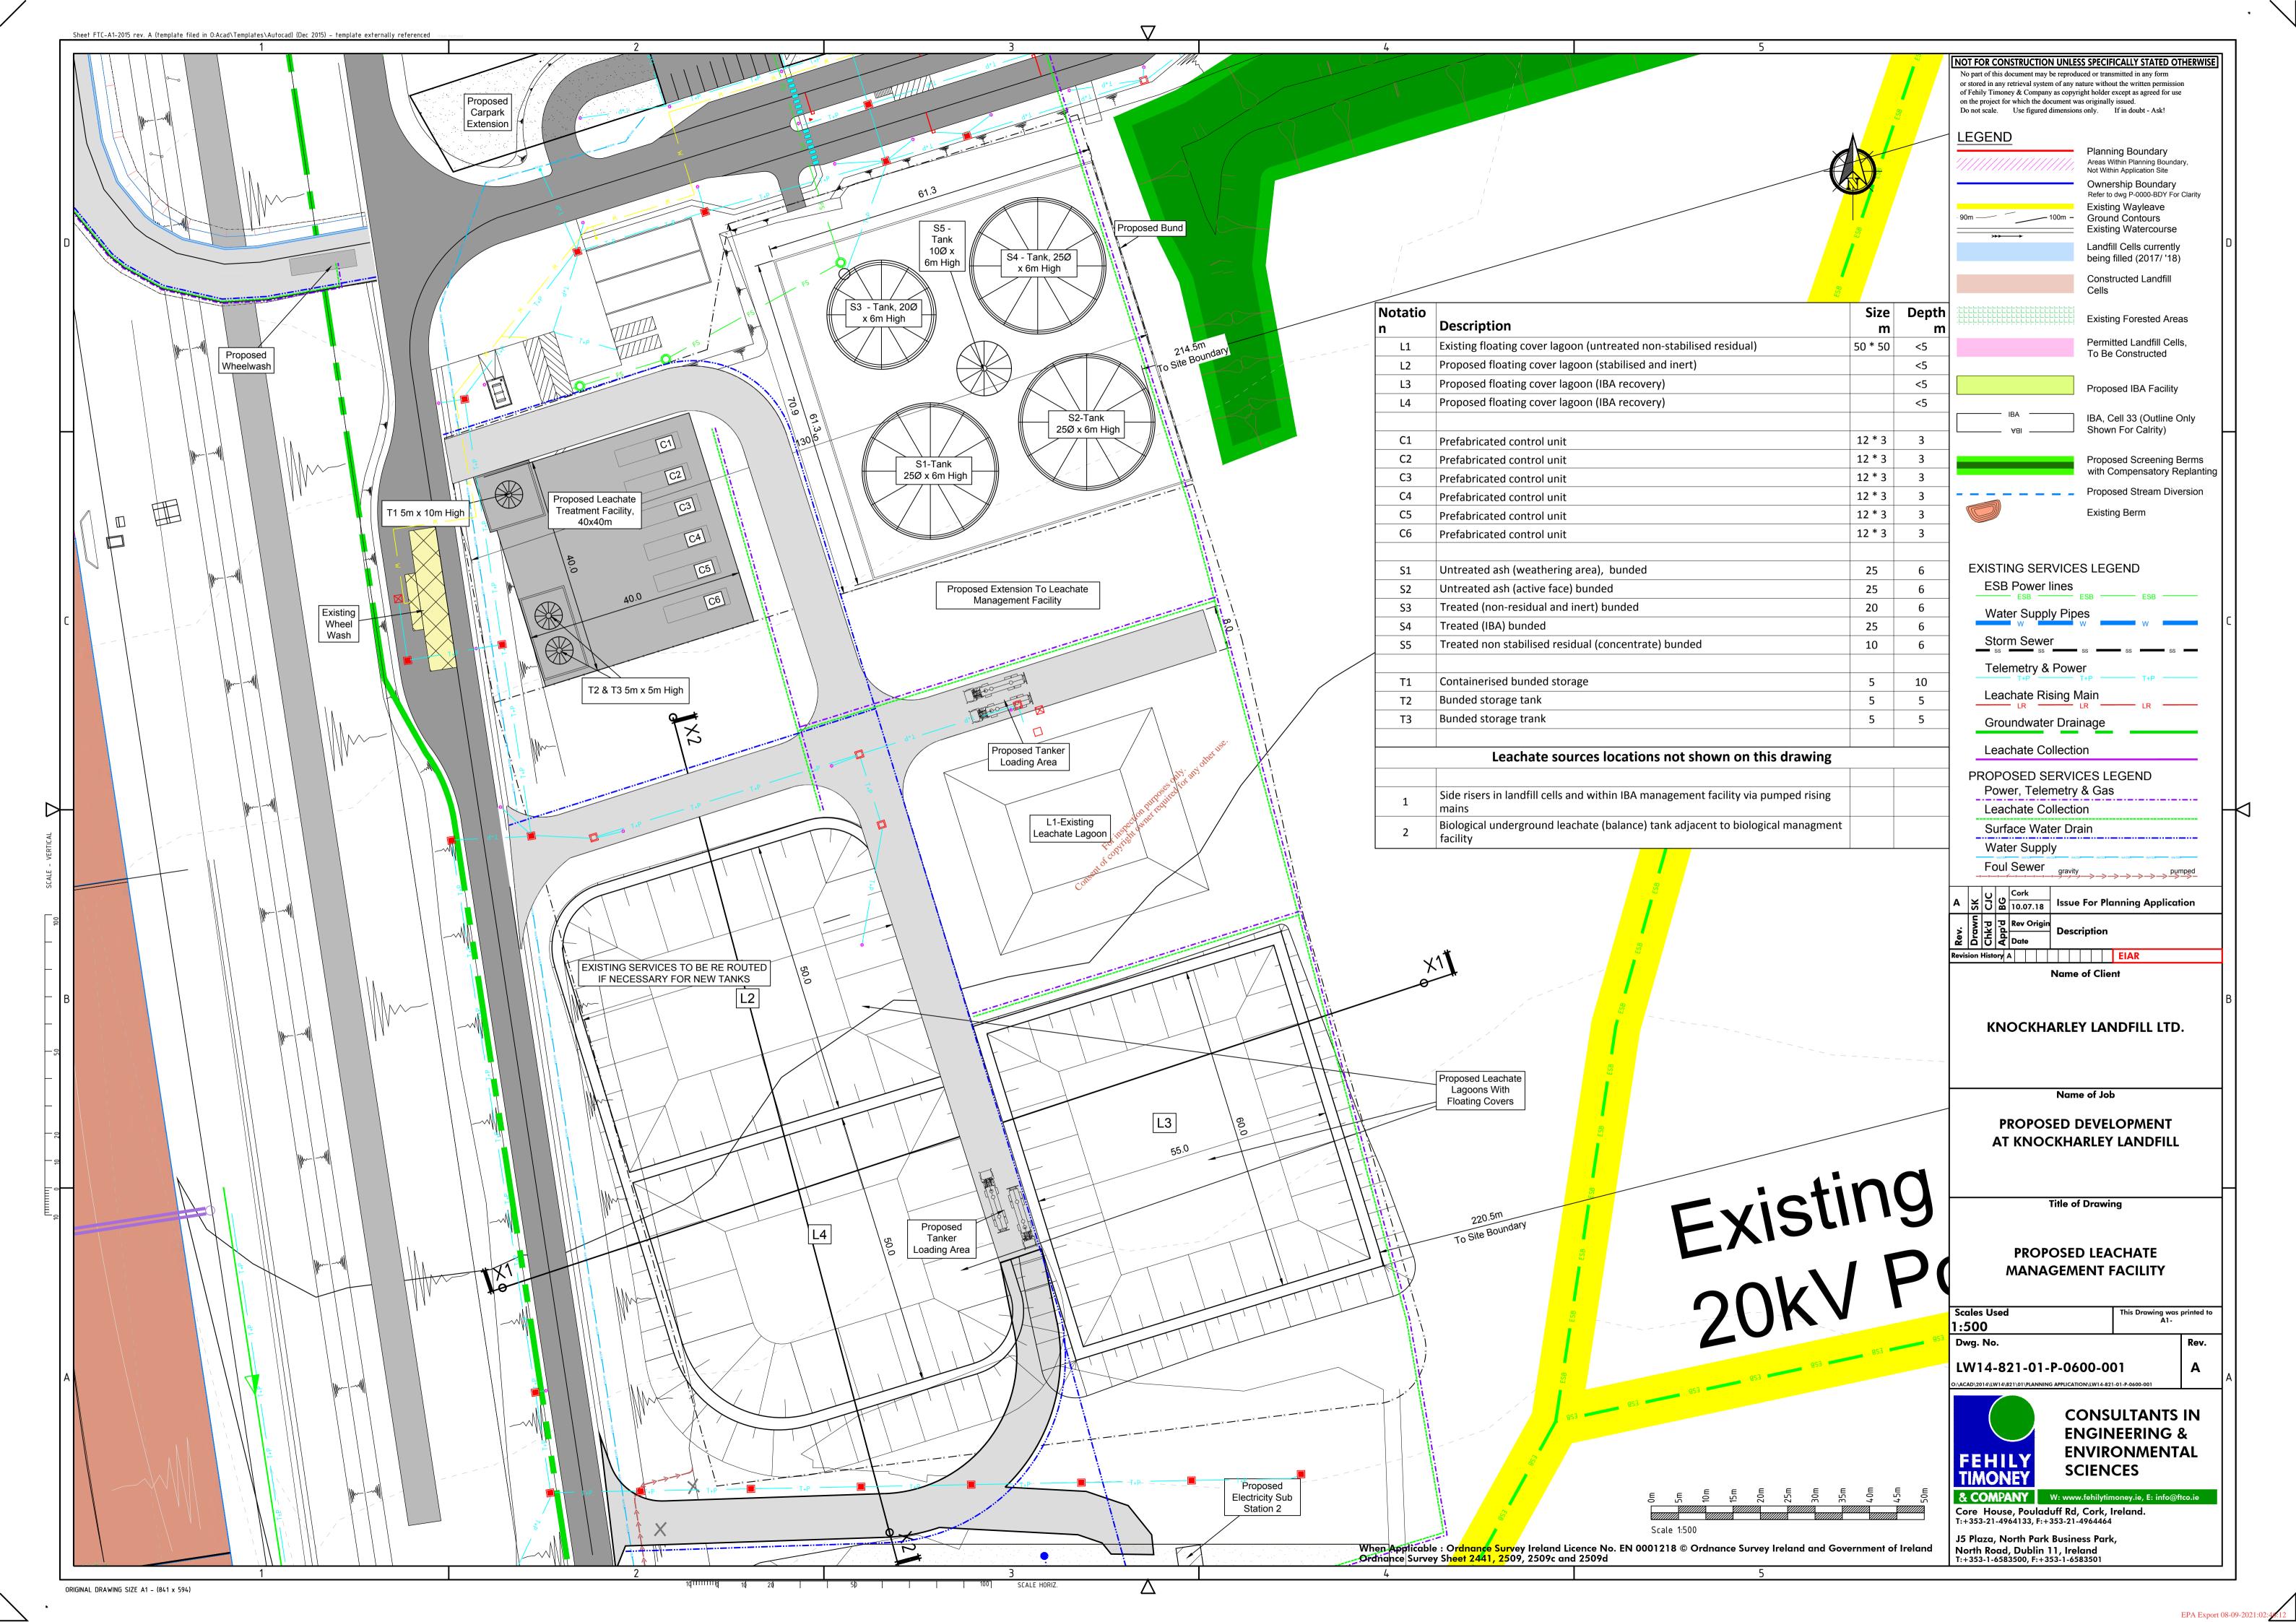
KNOCKHARLEY LANDFILL Ltd.

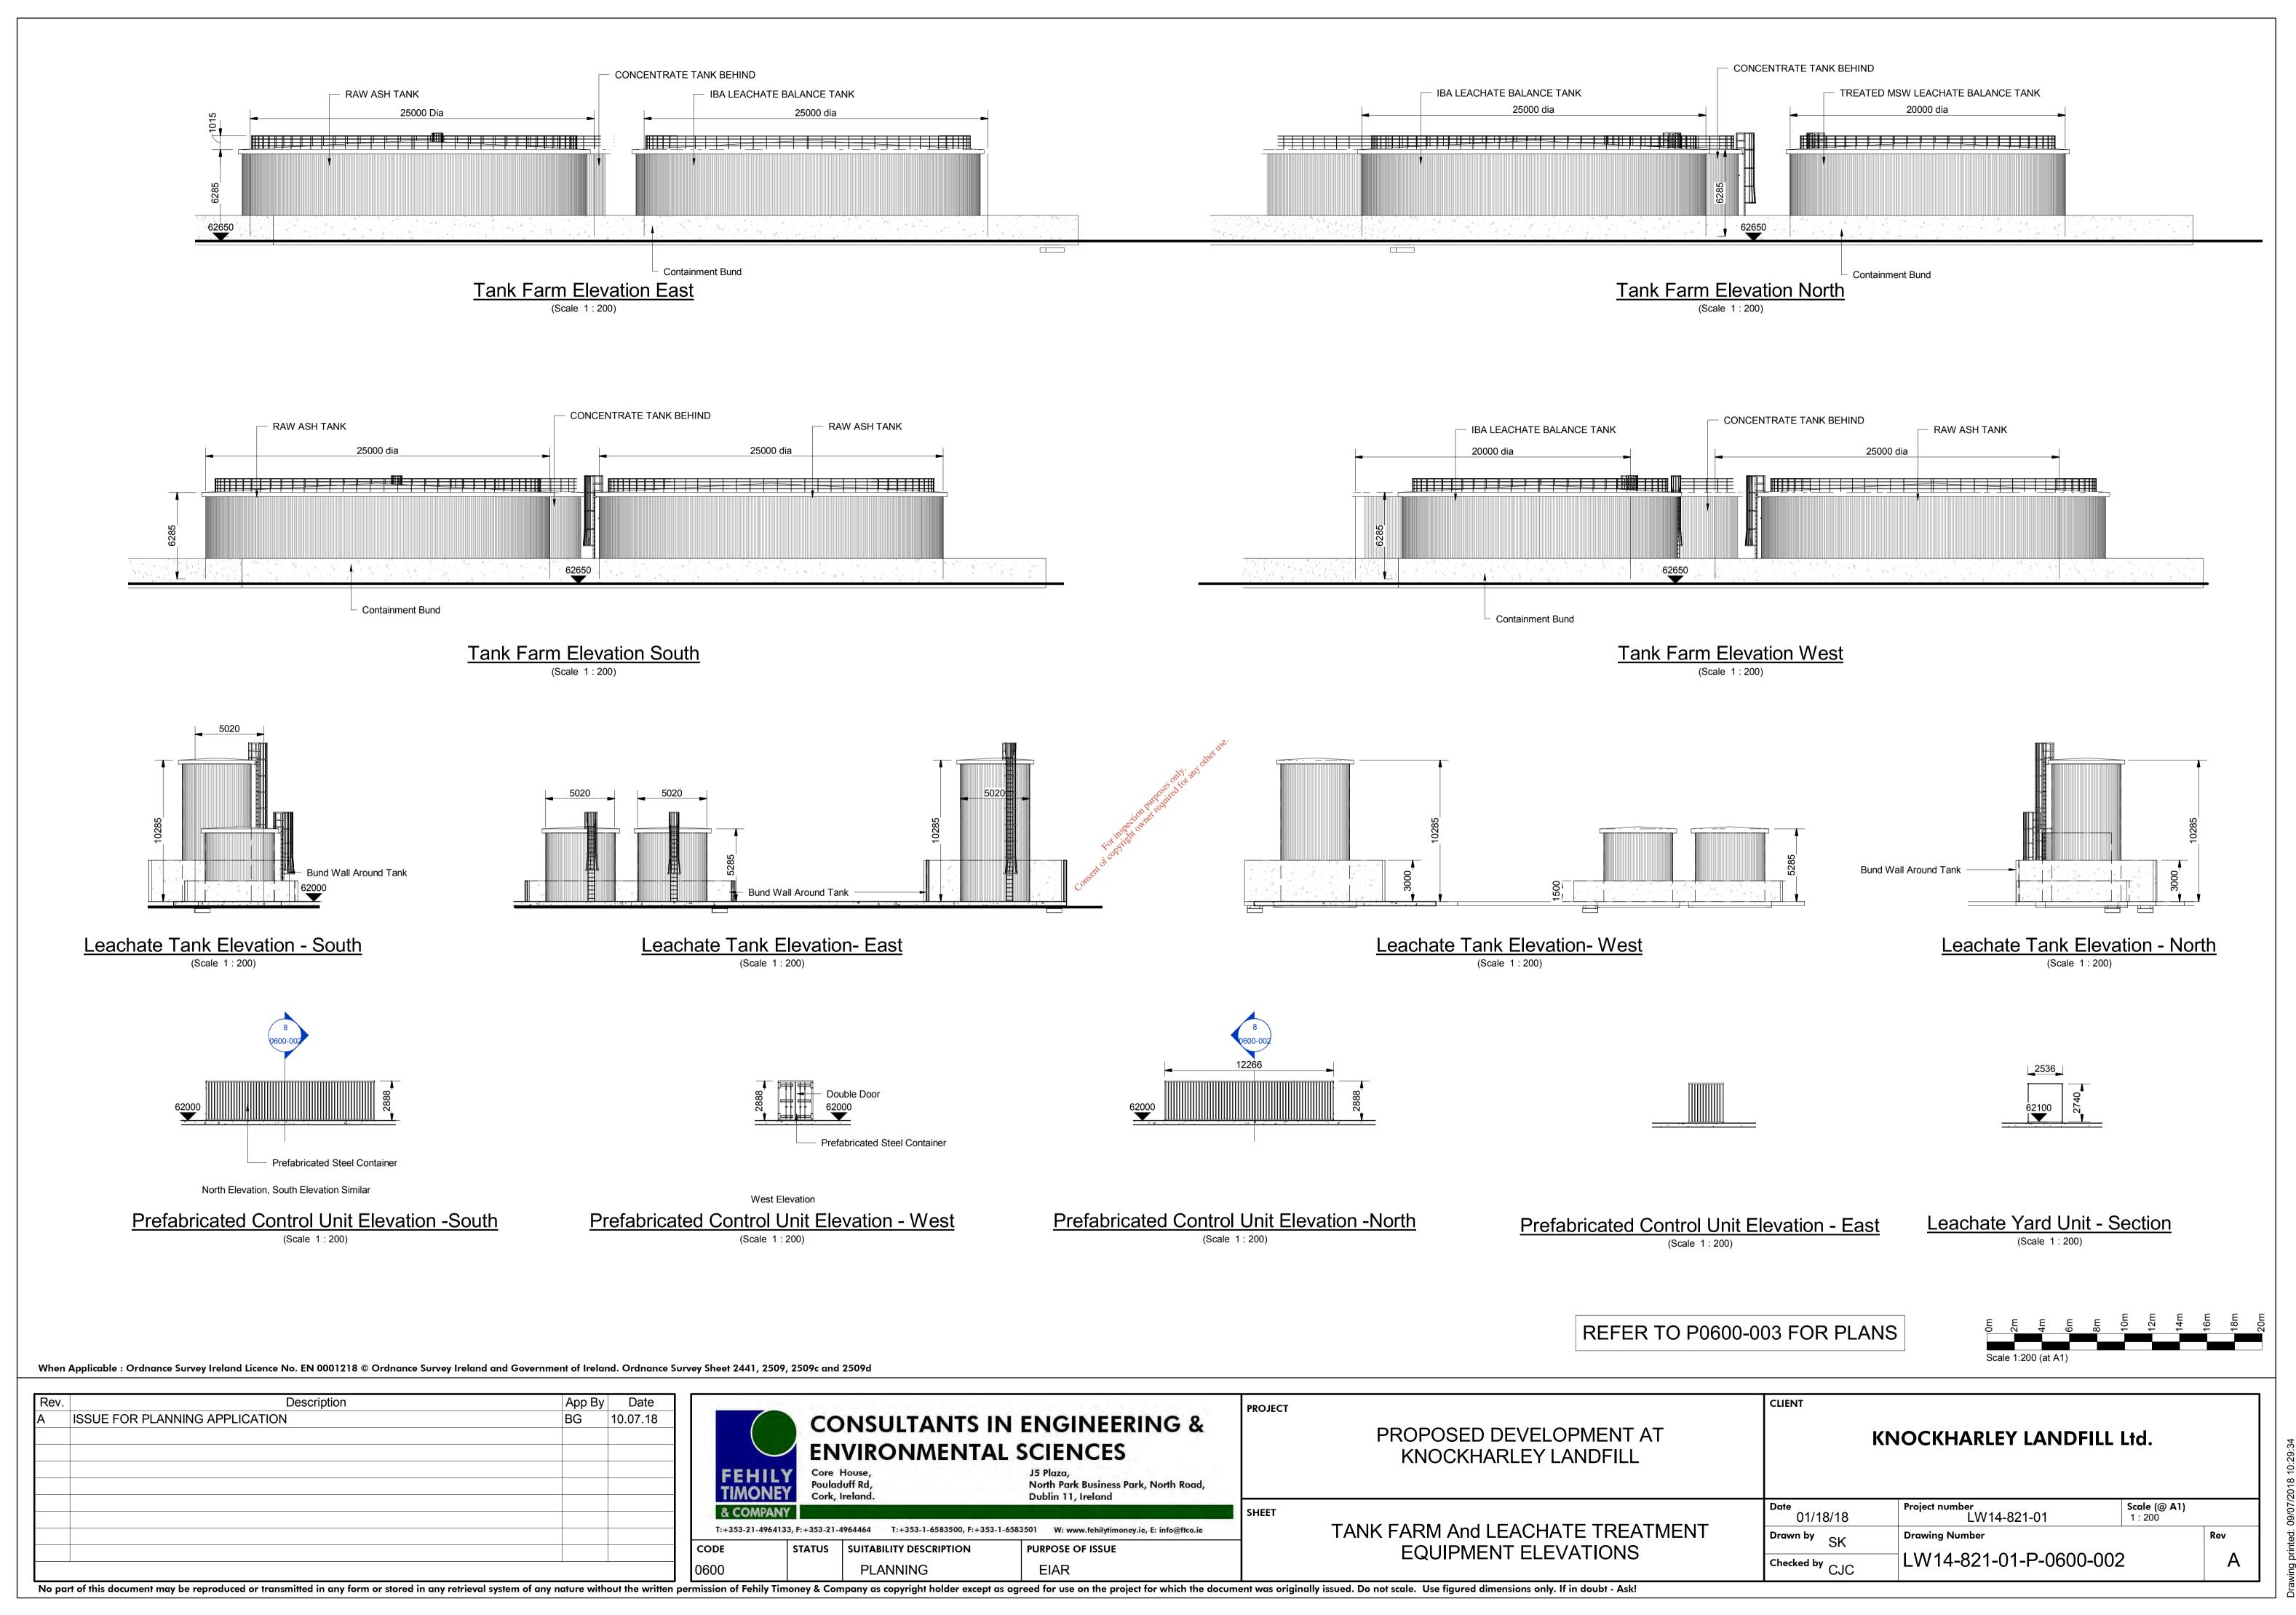
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Α

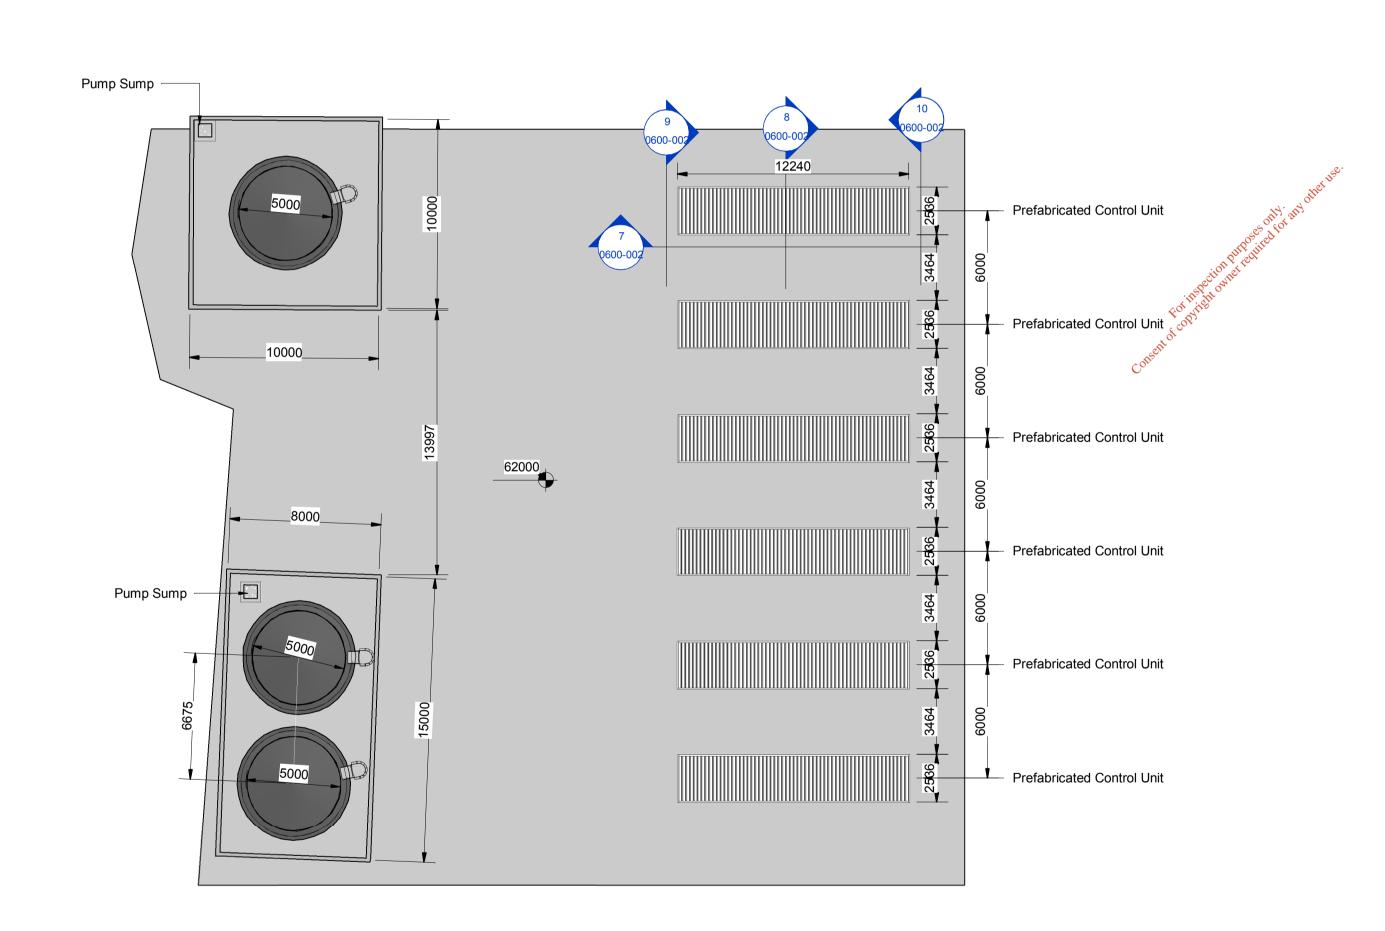


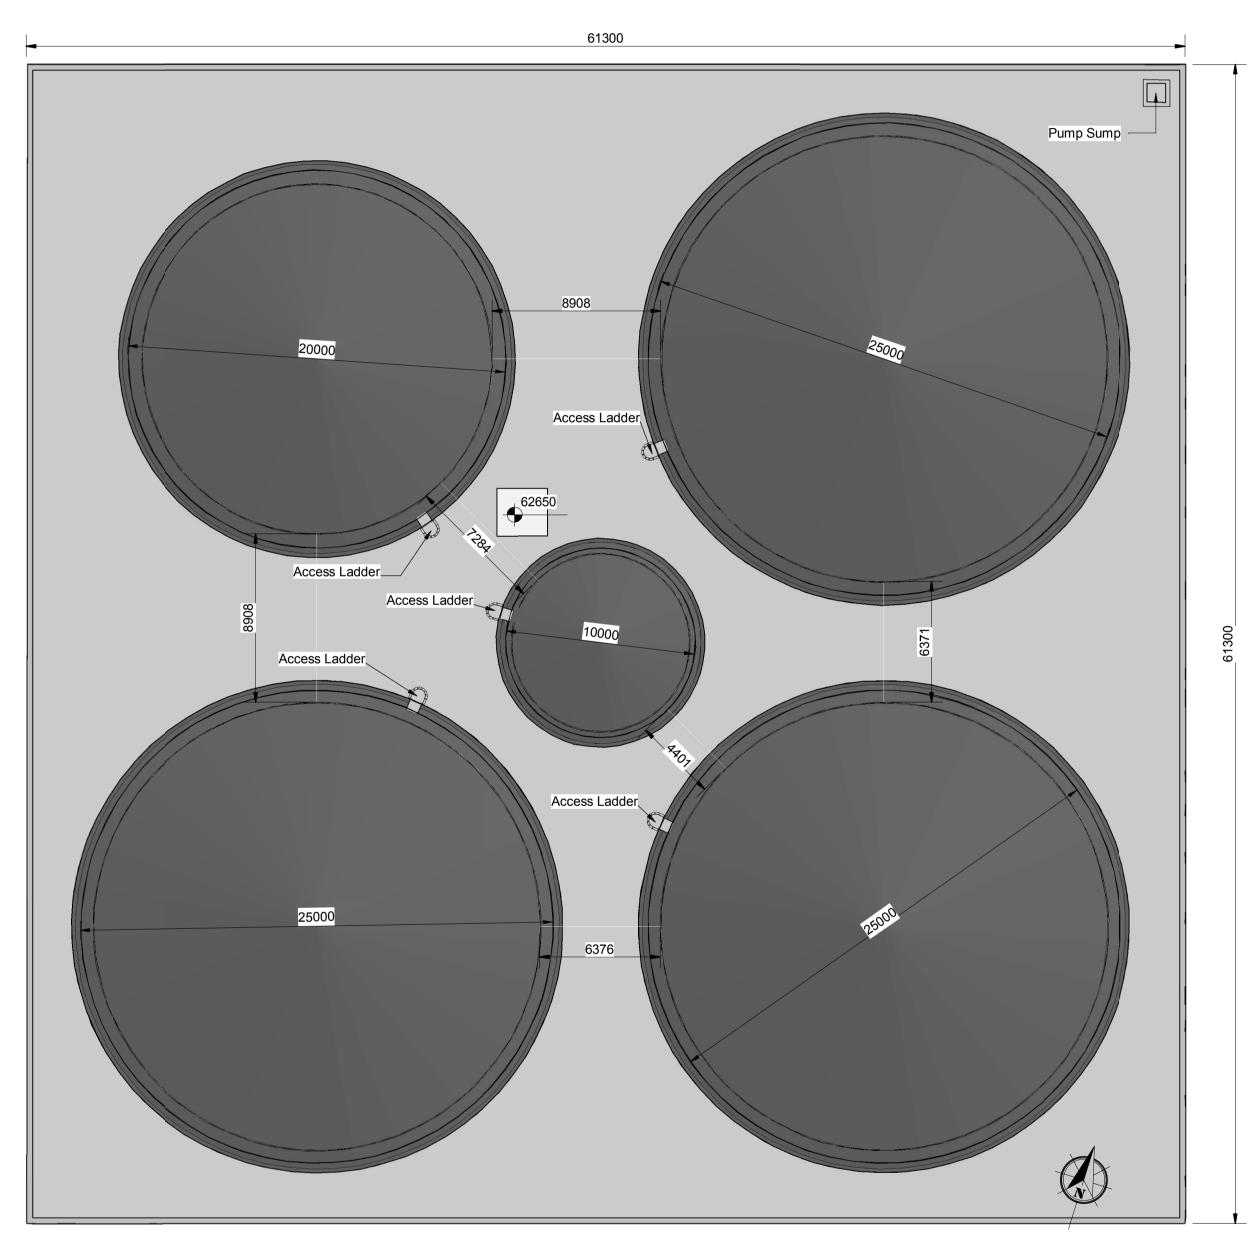




### Notes:

Refer to 1:1000 series drawings (LW14-821-01-P-0000-004 To 011) layout of existing and proposed services.





LEACHATE YARD
(Scale 1:200)

į	E	2m	4m	6m	8m	10m	12m	14m	16m	18m	20m
;	Scal	e 1:20	00 (at A	<b>\1</b> )							

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Rev.	Description	App By	Date
A	ISSUE FOR PLANNING APPLICATION	BG	10.07.18

		NSULTANTS I	N ENGINEERING & L SCIENCES	PROJECT
FEH	Poula	House, duff Rd, Ireland.	J5 Plaza, North Park Business Park, North Road, Dublin 11, Ireland	
& COM	1PANY 4964133, F:+353-21-	4964464 T:+353-1-6583500, F:+353-	1-6583501 W: www.fehilytimoney.ie, E: info@ftco.ie	SHEET
CODE	STATUS	SUITABILITY DESCRIPTION	PURPOSE OF ISSUE	

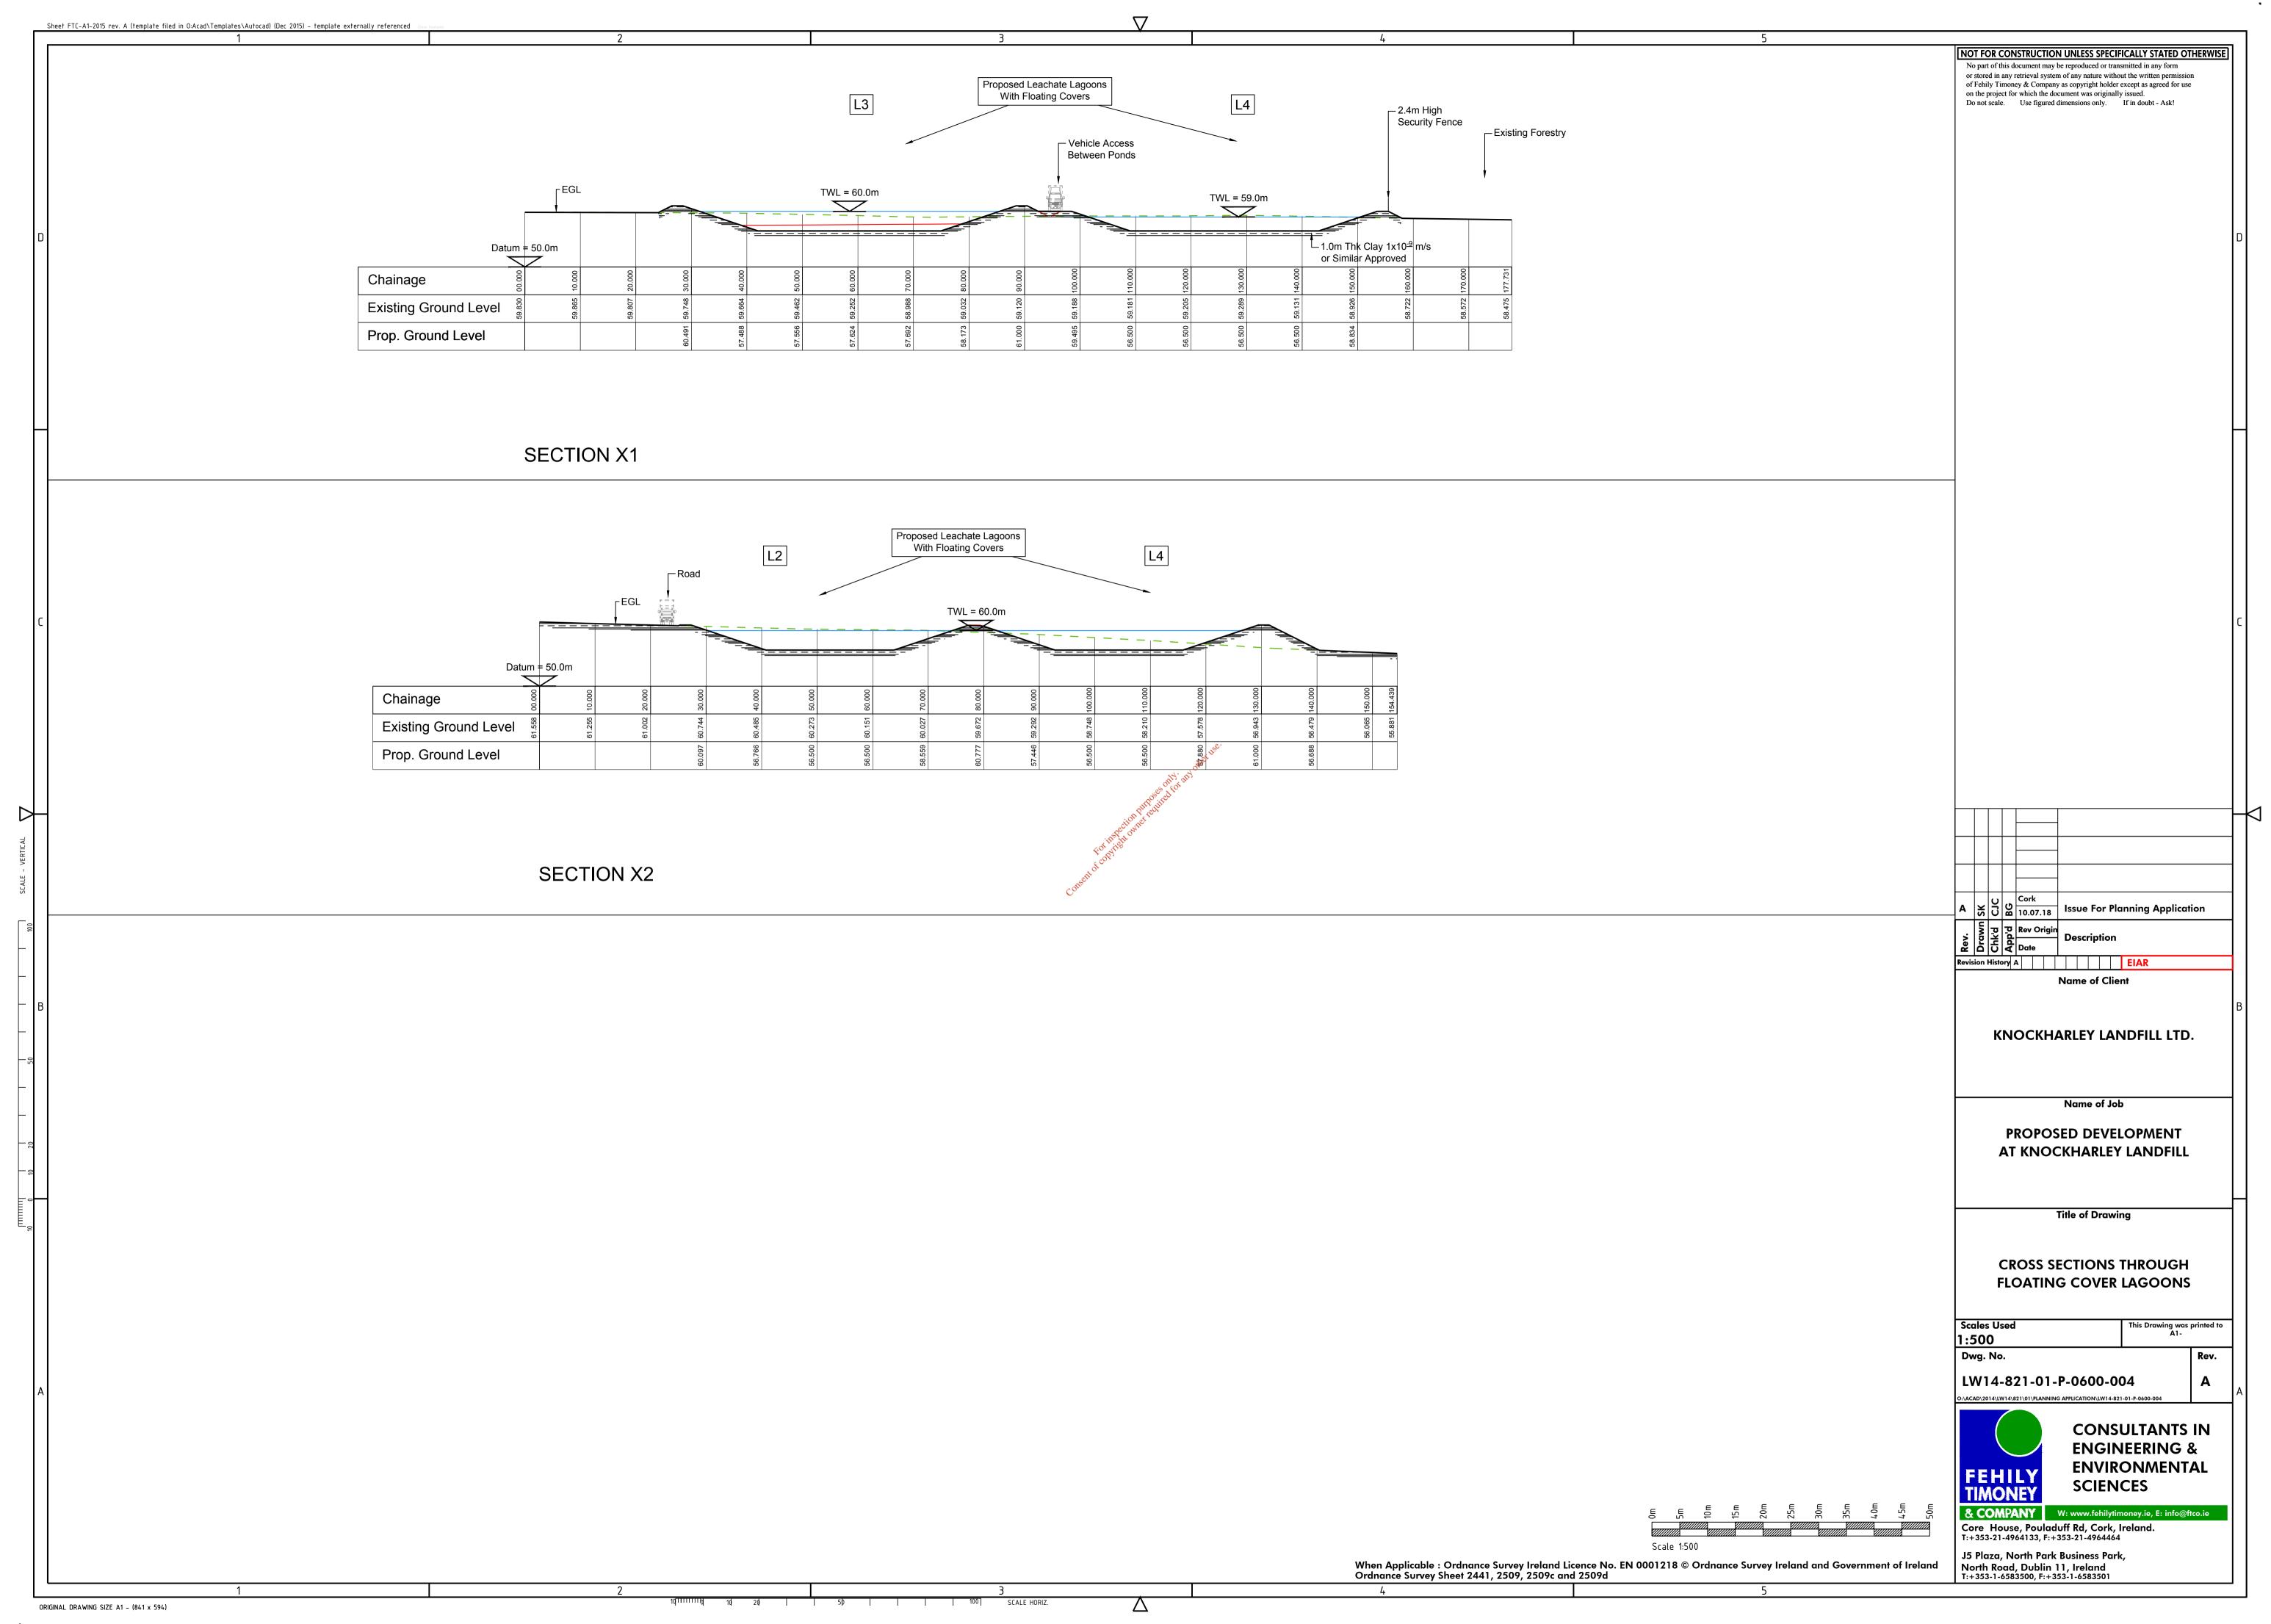
PROPOSED DEVELOPMENT AT
THOT OOLD DEVELOT MENT AT
KNOCKHARLEY LANDFILL

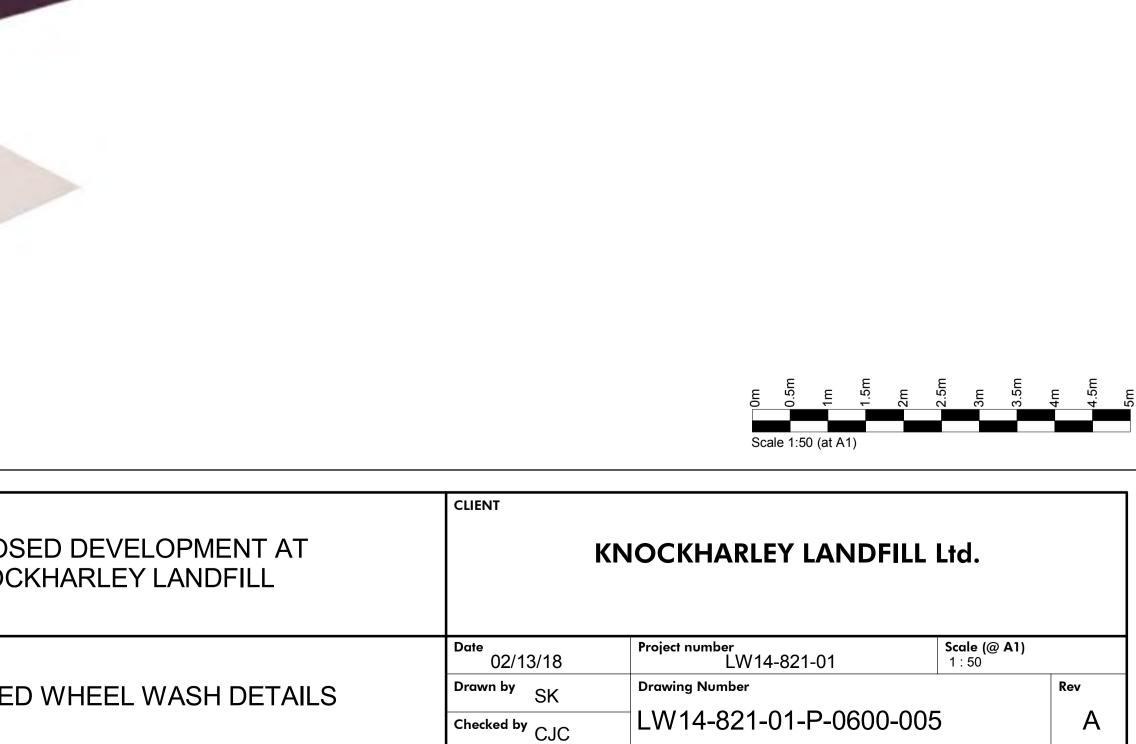
TANK FARM And LEACHATE TREATMENT **EQUIPMENT PLAN** 

# KNOCKHARLEY LANDFILL Ltd.

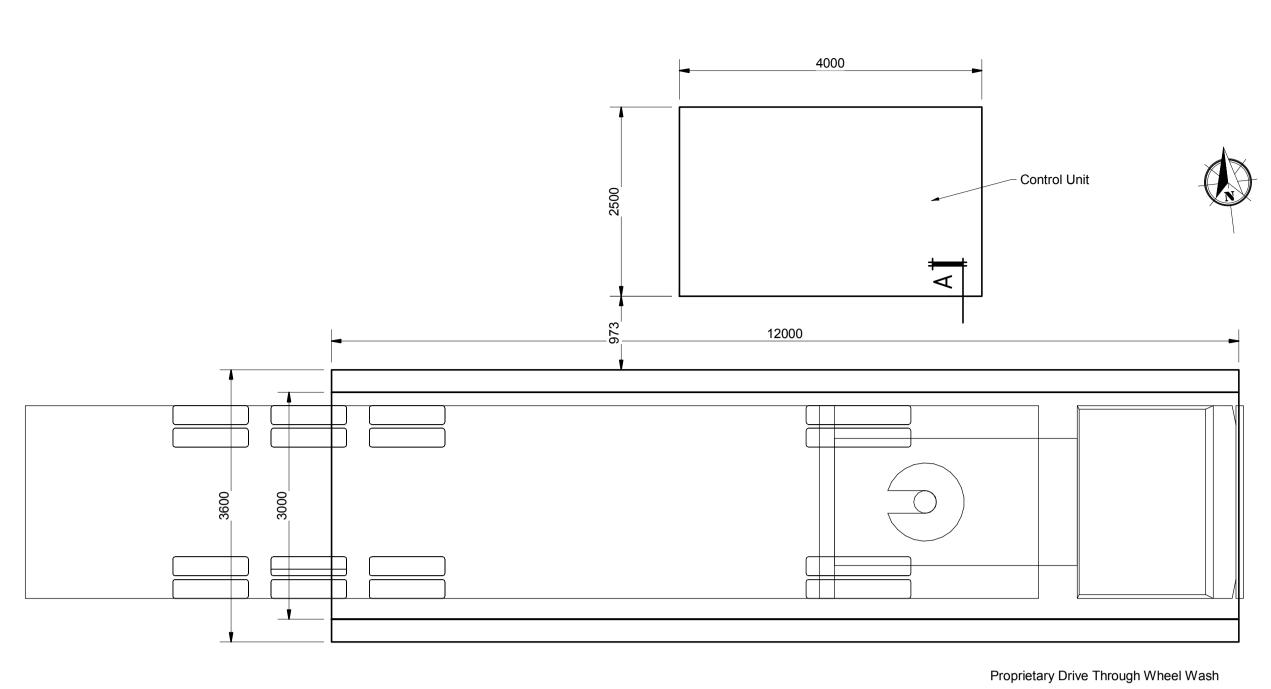
Date 02/12/18	Project number LW14-821-01	Scale (@ A1) As indicated	
Drawn by SK	Drawing Number		Rev
Checked by	LW14-821-01-P-0600-003	3	

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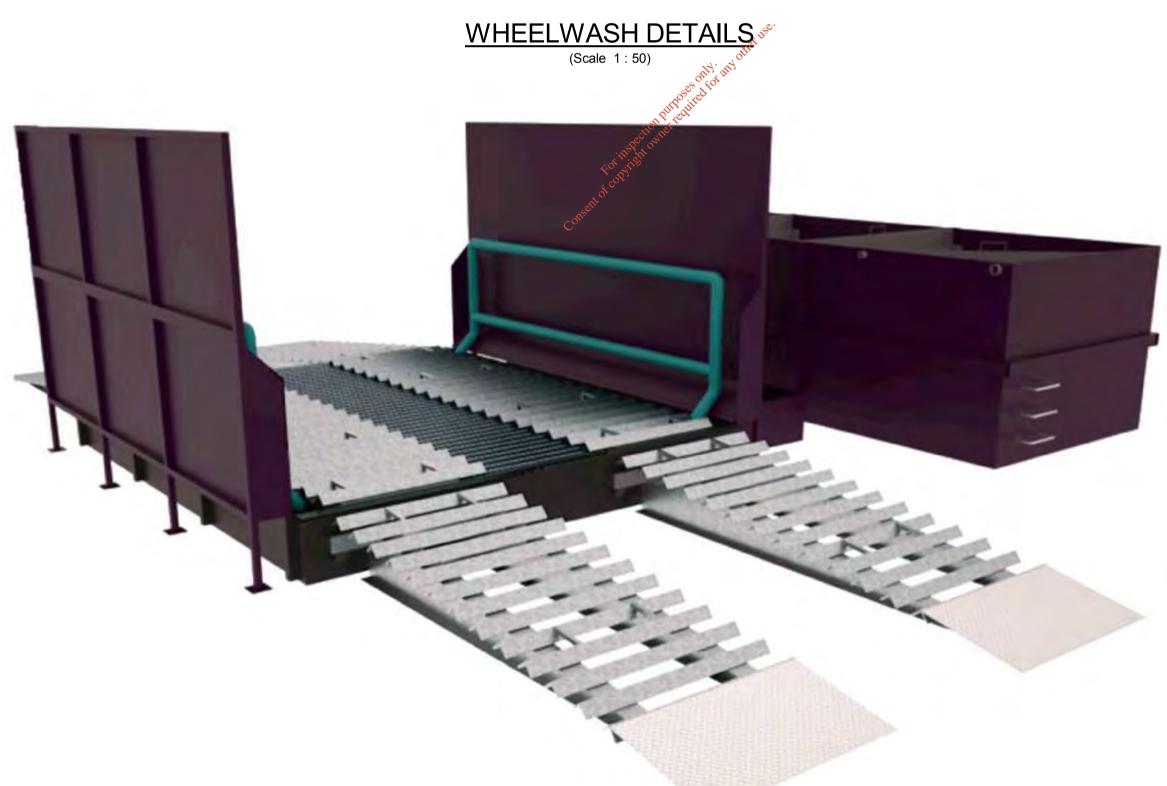
Control Unit



PLAN SECTION A-A

Splash Gaurd Wall and  $\lnot$  Pressure Pipe Housing

63.90m ¬



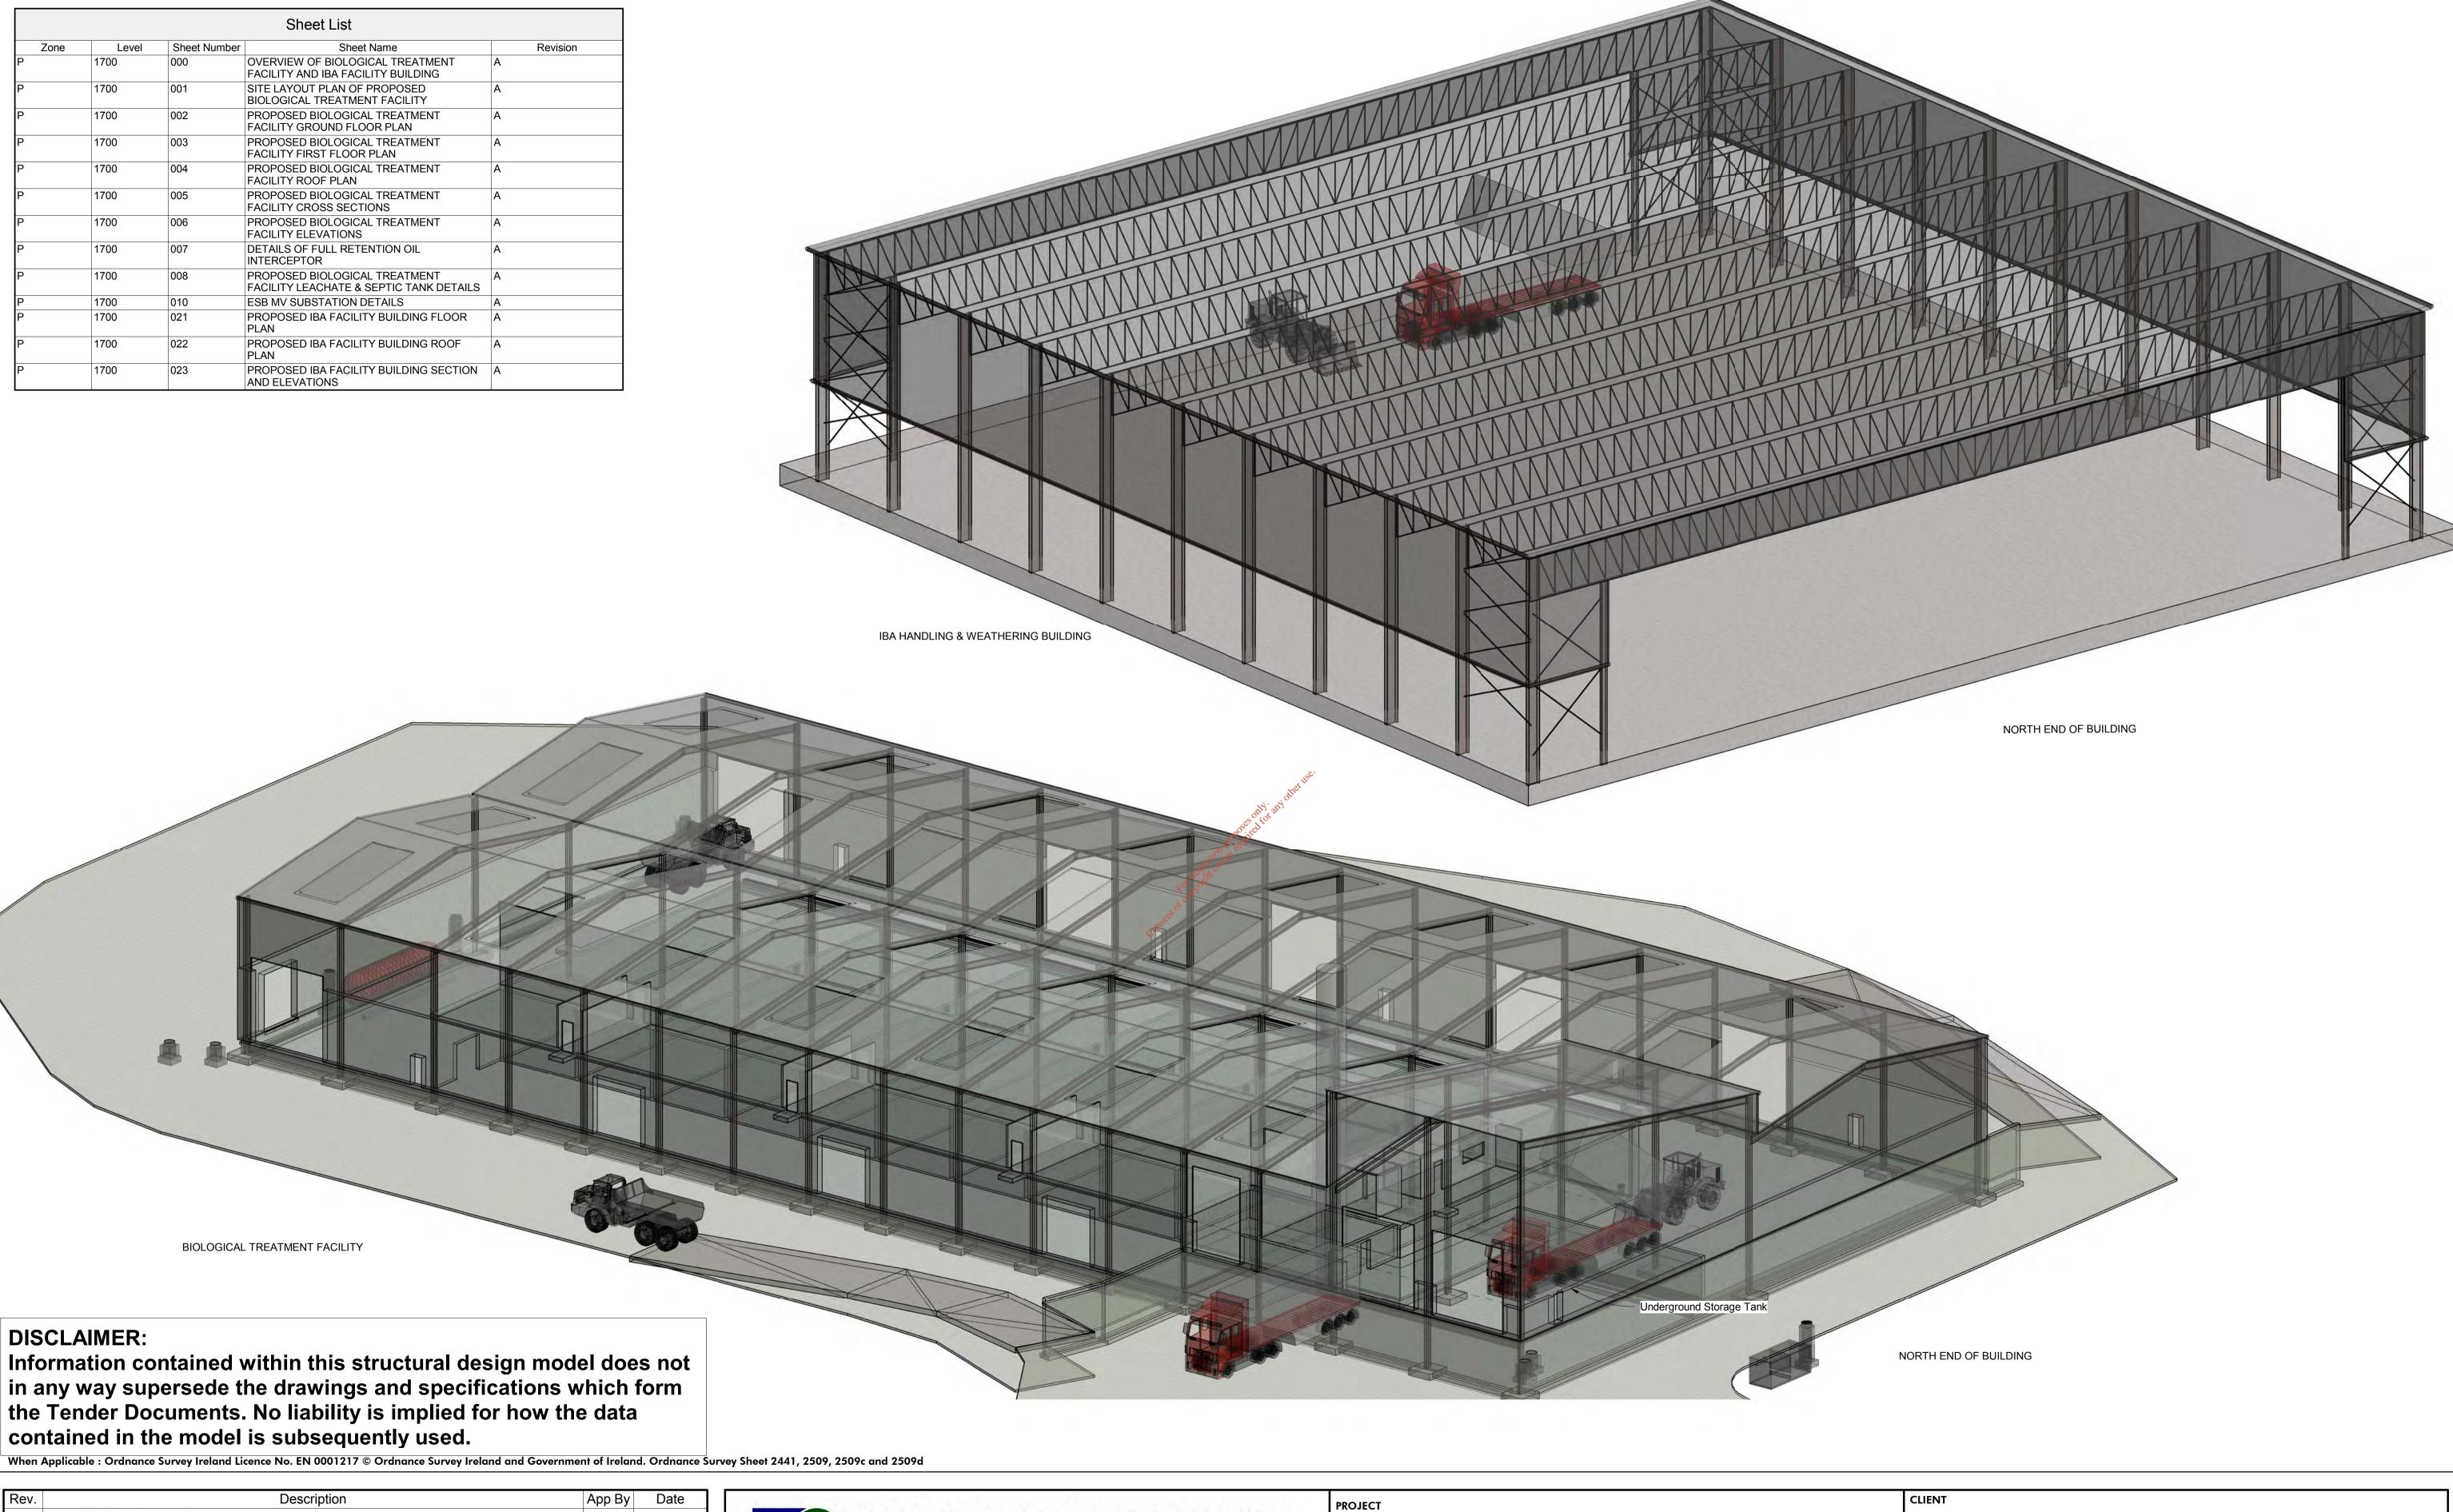
### ISOMETRIC REPRESENTATION OF WHEEL WASH UNIT

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& COMPANY T:+353-21-496413		4964464 T:+353-1-6583500, F:+353	1-6583501 W: www.fehilytimoney.ie, E: info@ftco.ie	SHEET
CODE	STATUS	SUITABILITY DESCRIPTION	PURPOSE OF ISSUE	

Date Project number Scale (@ A1) 1 : 50	
02/13/18 LW14-821-01 1:50	
PROPOSED WHEEL WASH DETAILS  Drawn by SK  Drawing Number	Rev



Rev.	Description	App By	Date
Α	Issue For Planning Application	BG	10.07.18

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	<b>EN</b>	VIRONMENTA	L SCIENCES
	Poula	House, duff Rd, Ireland.	J5 Plaza, North Park Business Park, North Road, Dublin 11, Ireland
& CON	<b>APANY</b> -4964133, F:+353-21-	4964464 T:+353-1-6583500, F:+353	-1-6583501 W: www.fehilytimoney.ie, E: info@ftco.ie
CODE	STATUS	SUITABILITY DESCRIPTION	PURPOSE OF ISSUE
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PROPOSED DEVELOPMENT AT KNOCKHARLEY LANDFILL

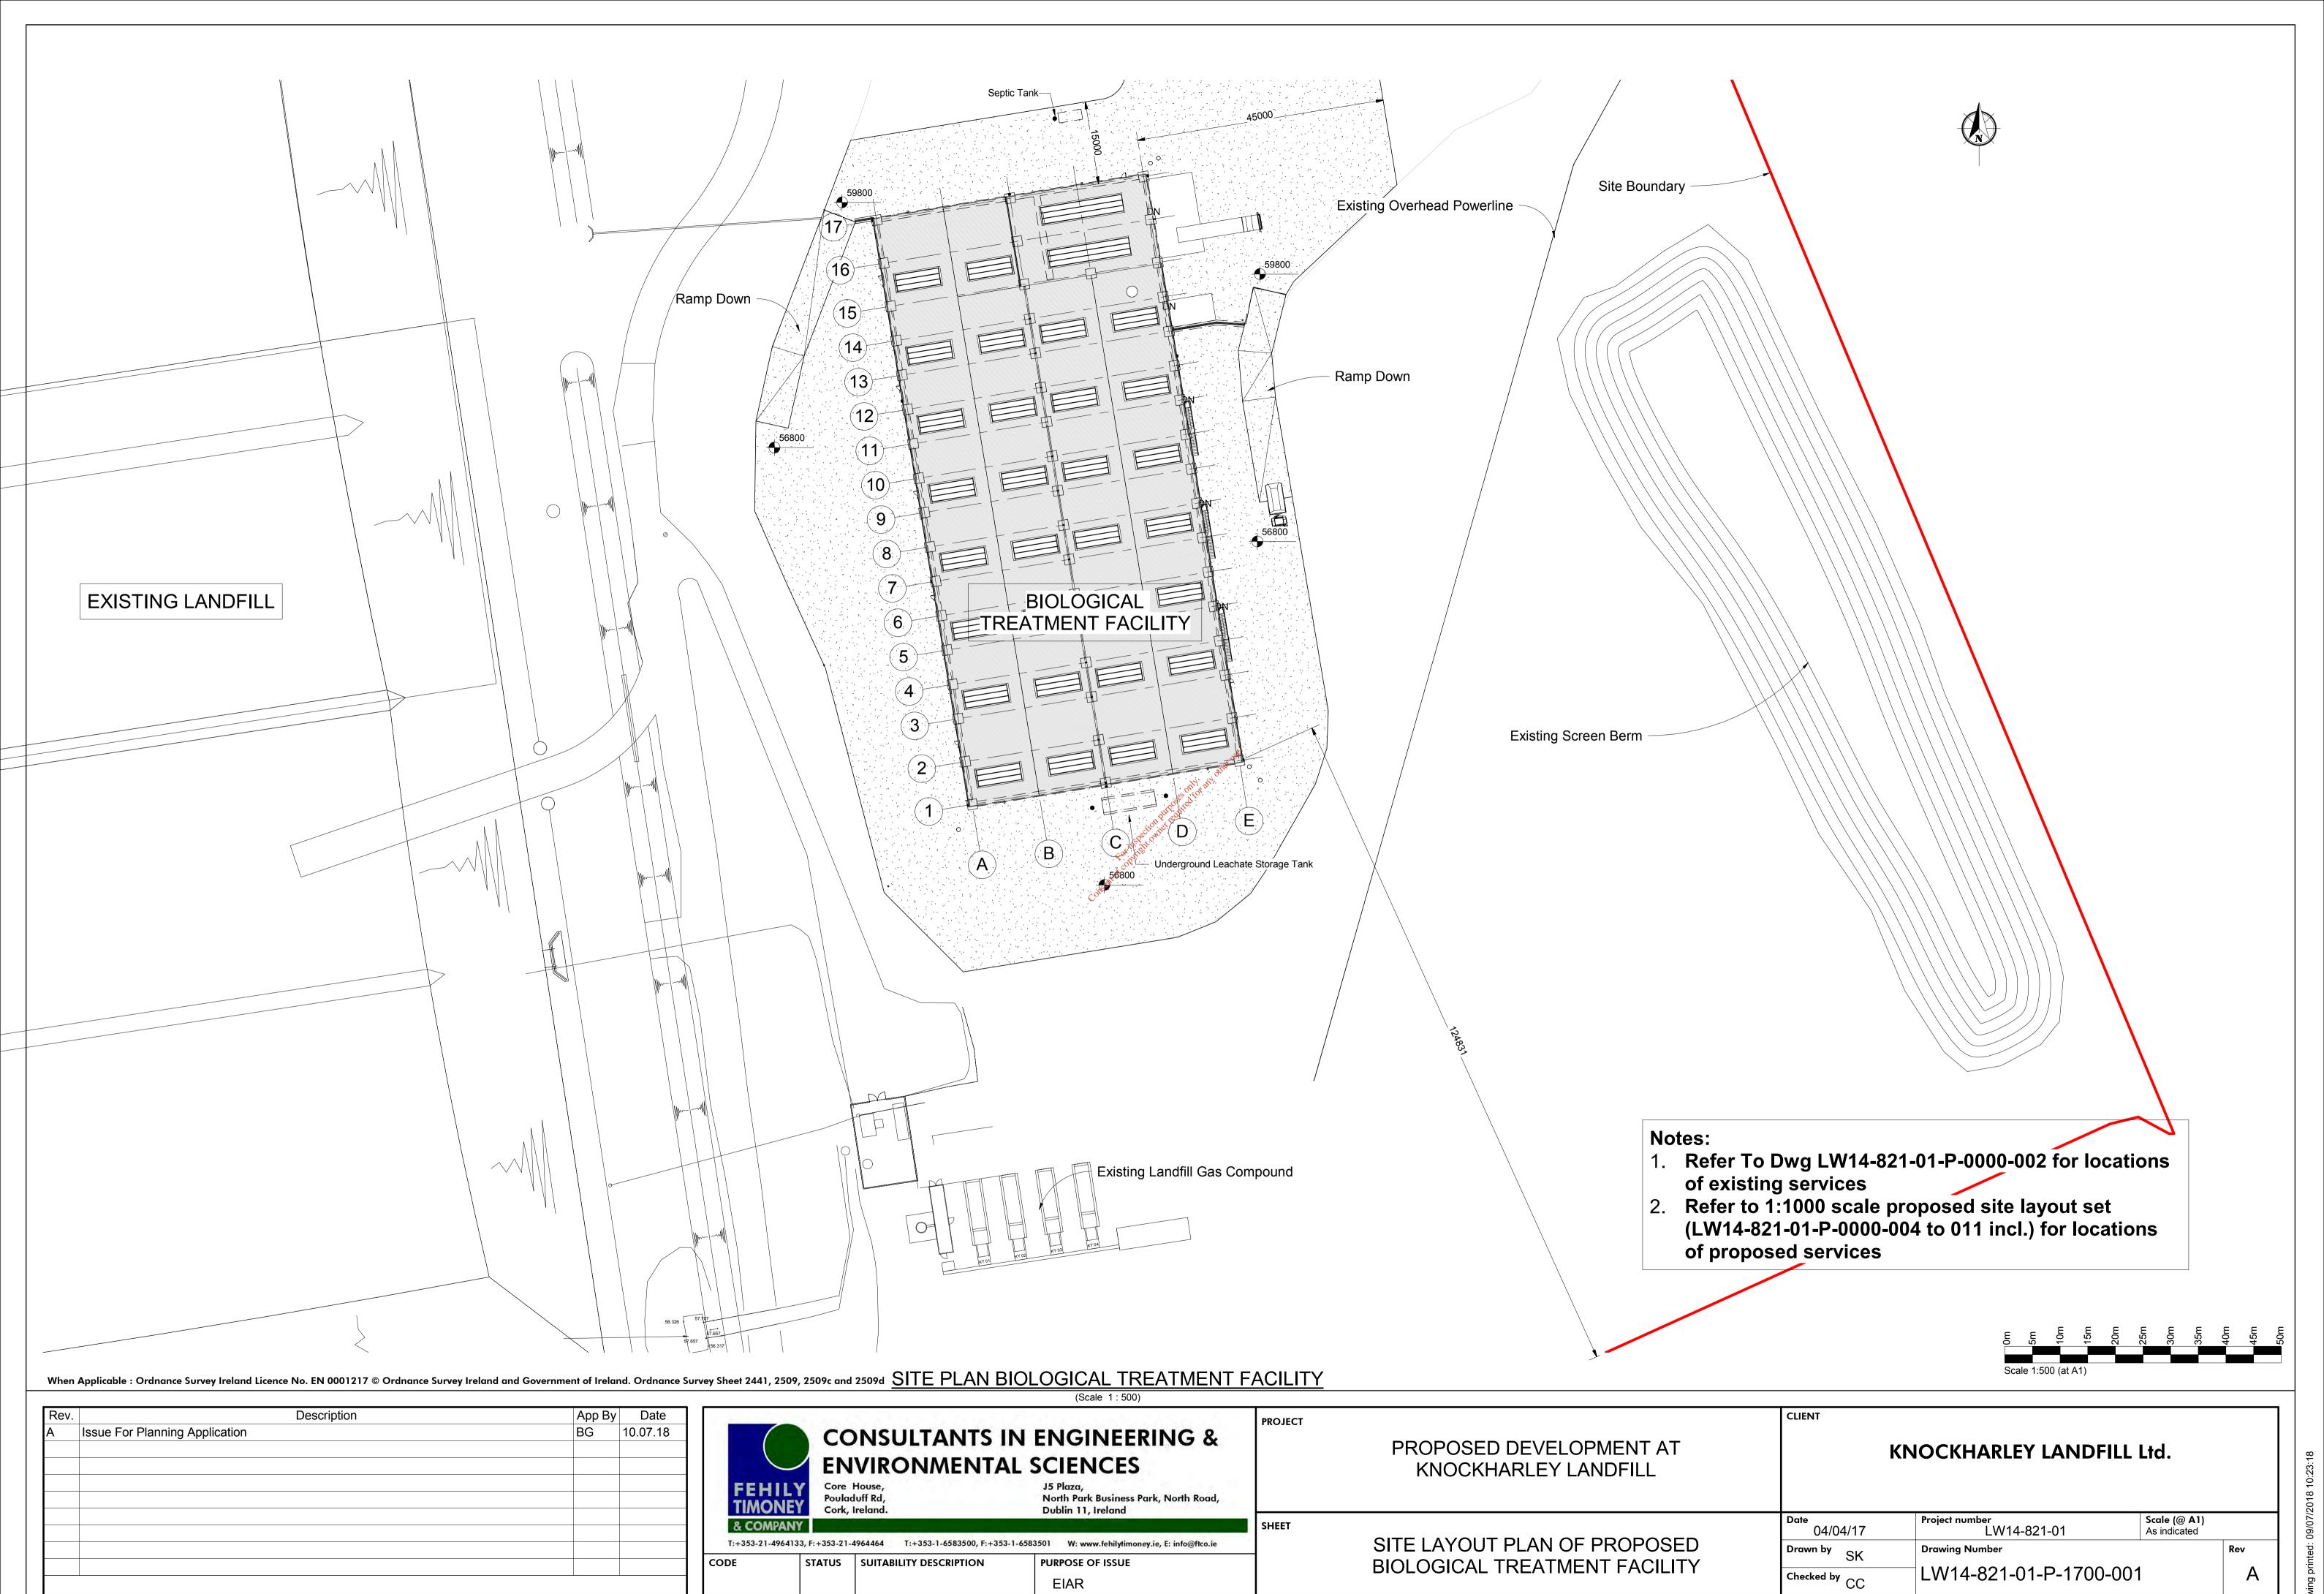
OVERVIEW OF BIOLOGICAL TREATMENT

FACILITY AND IBA FACILITY BUILDING

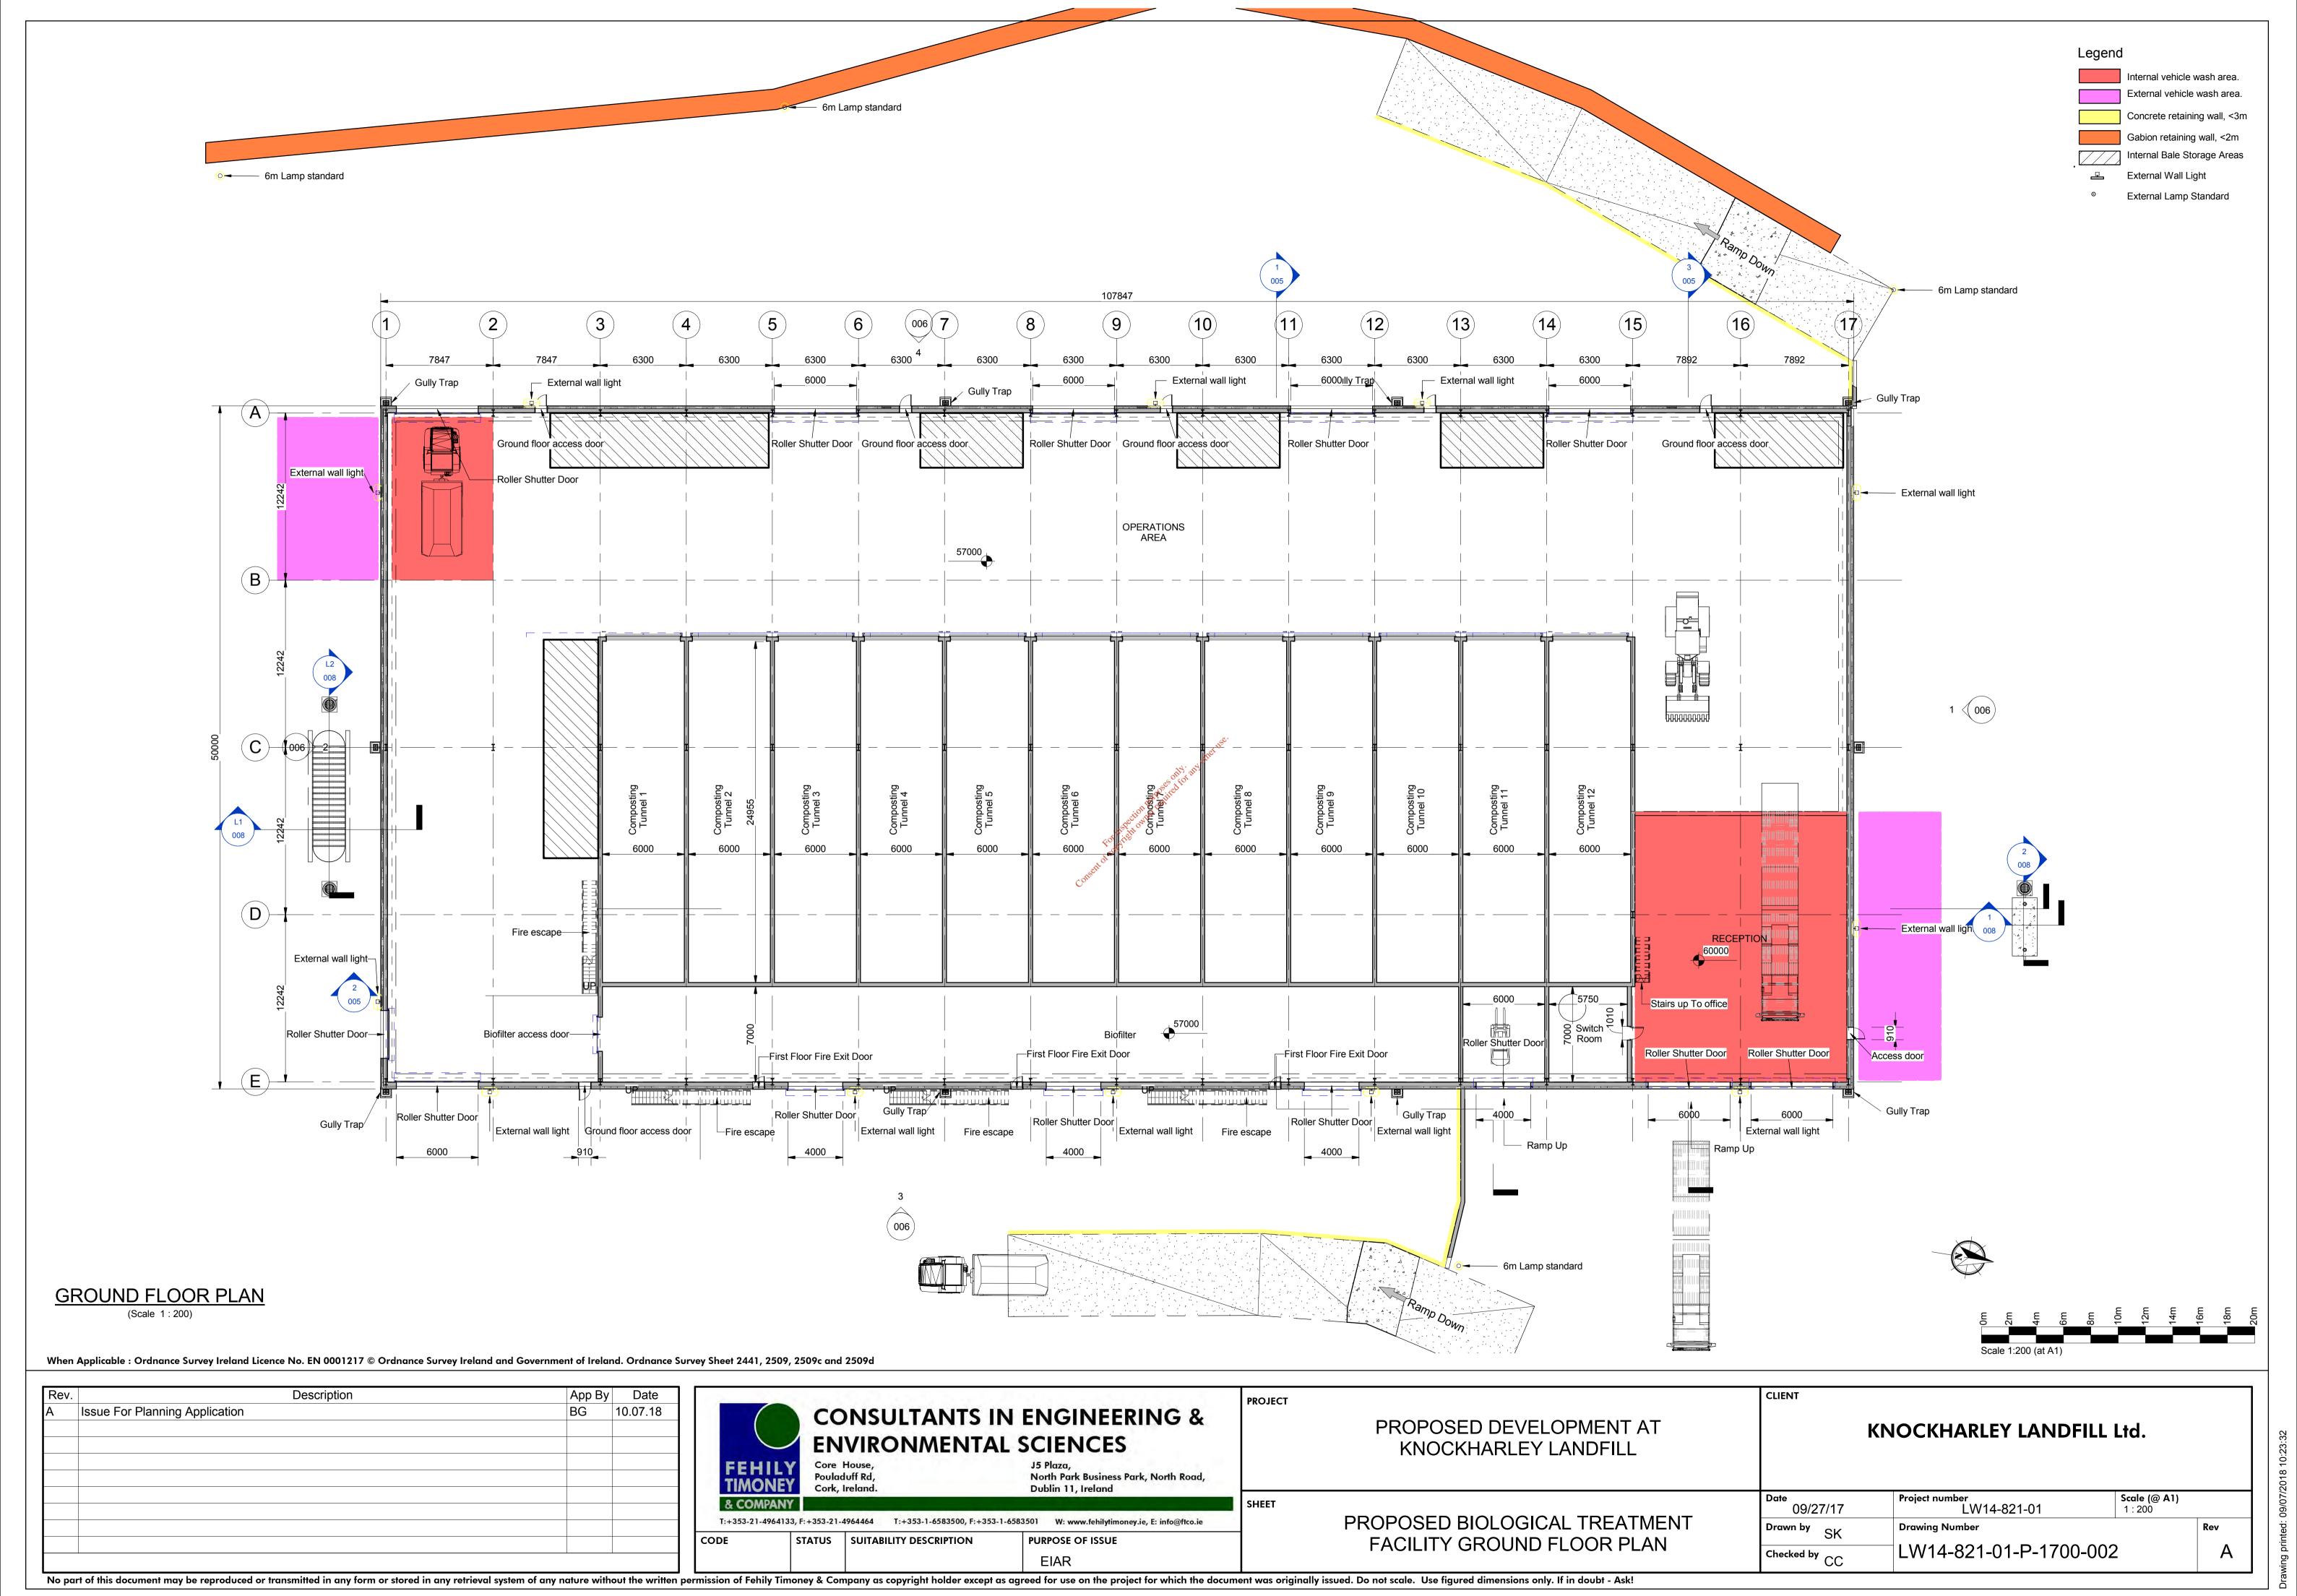
KNOCKHARLEY LANDFILL Ltd.

Date 10.07.18	Project number LW14-821-01	Scale (@ A1) N/A	
Drawn by SK	Drawing Number		Rev
Checked by CC	LW14-821-01-P-1700-000		Α

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Rev.	Description	App By	Date
A	Issue For Planning Application	BG	10.07.18

	MENTAL SCIENCES		EN
	15 Oliver		
	J5 Plaza, North Park Business Park, North Road, Dublin 11, Ireland	ore House, uladuff Rd, ork, Ireland.	Poulad
SHEET		& COMPANY	
	353-1-6583500, F:+353-1-6583501 W: www.fehilytimoney.ie, E: info@ftco.ie	-21-4964464 T:+353-1-658	

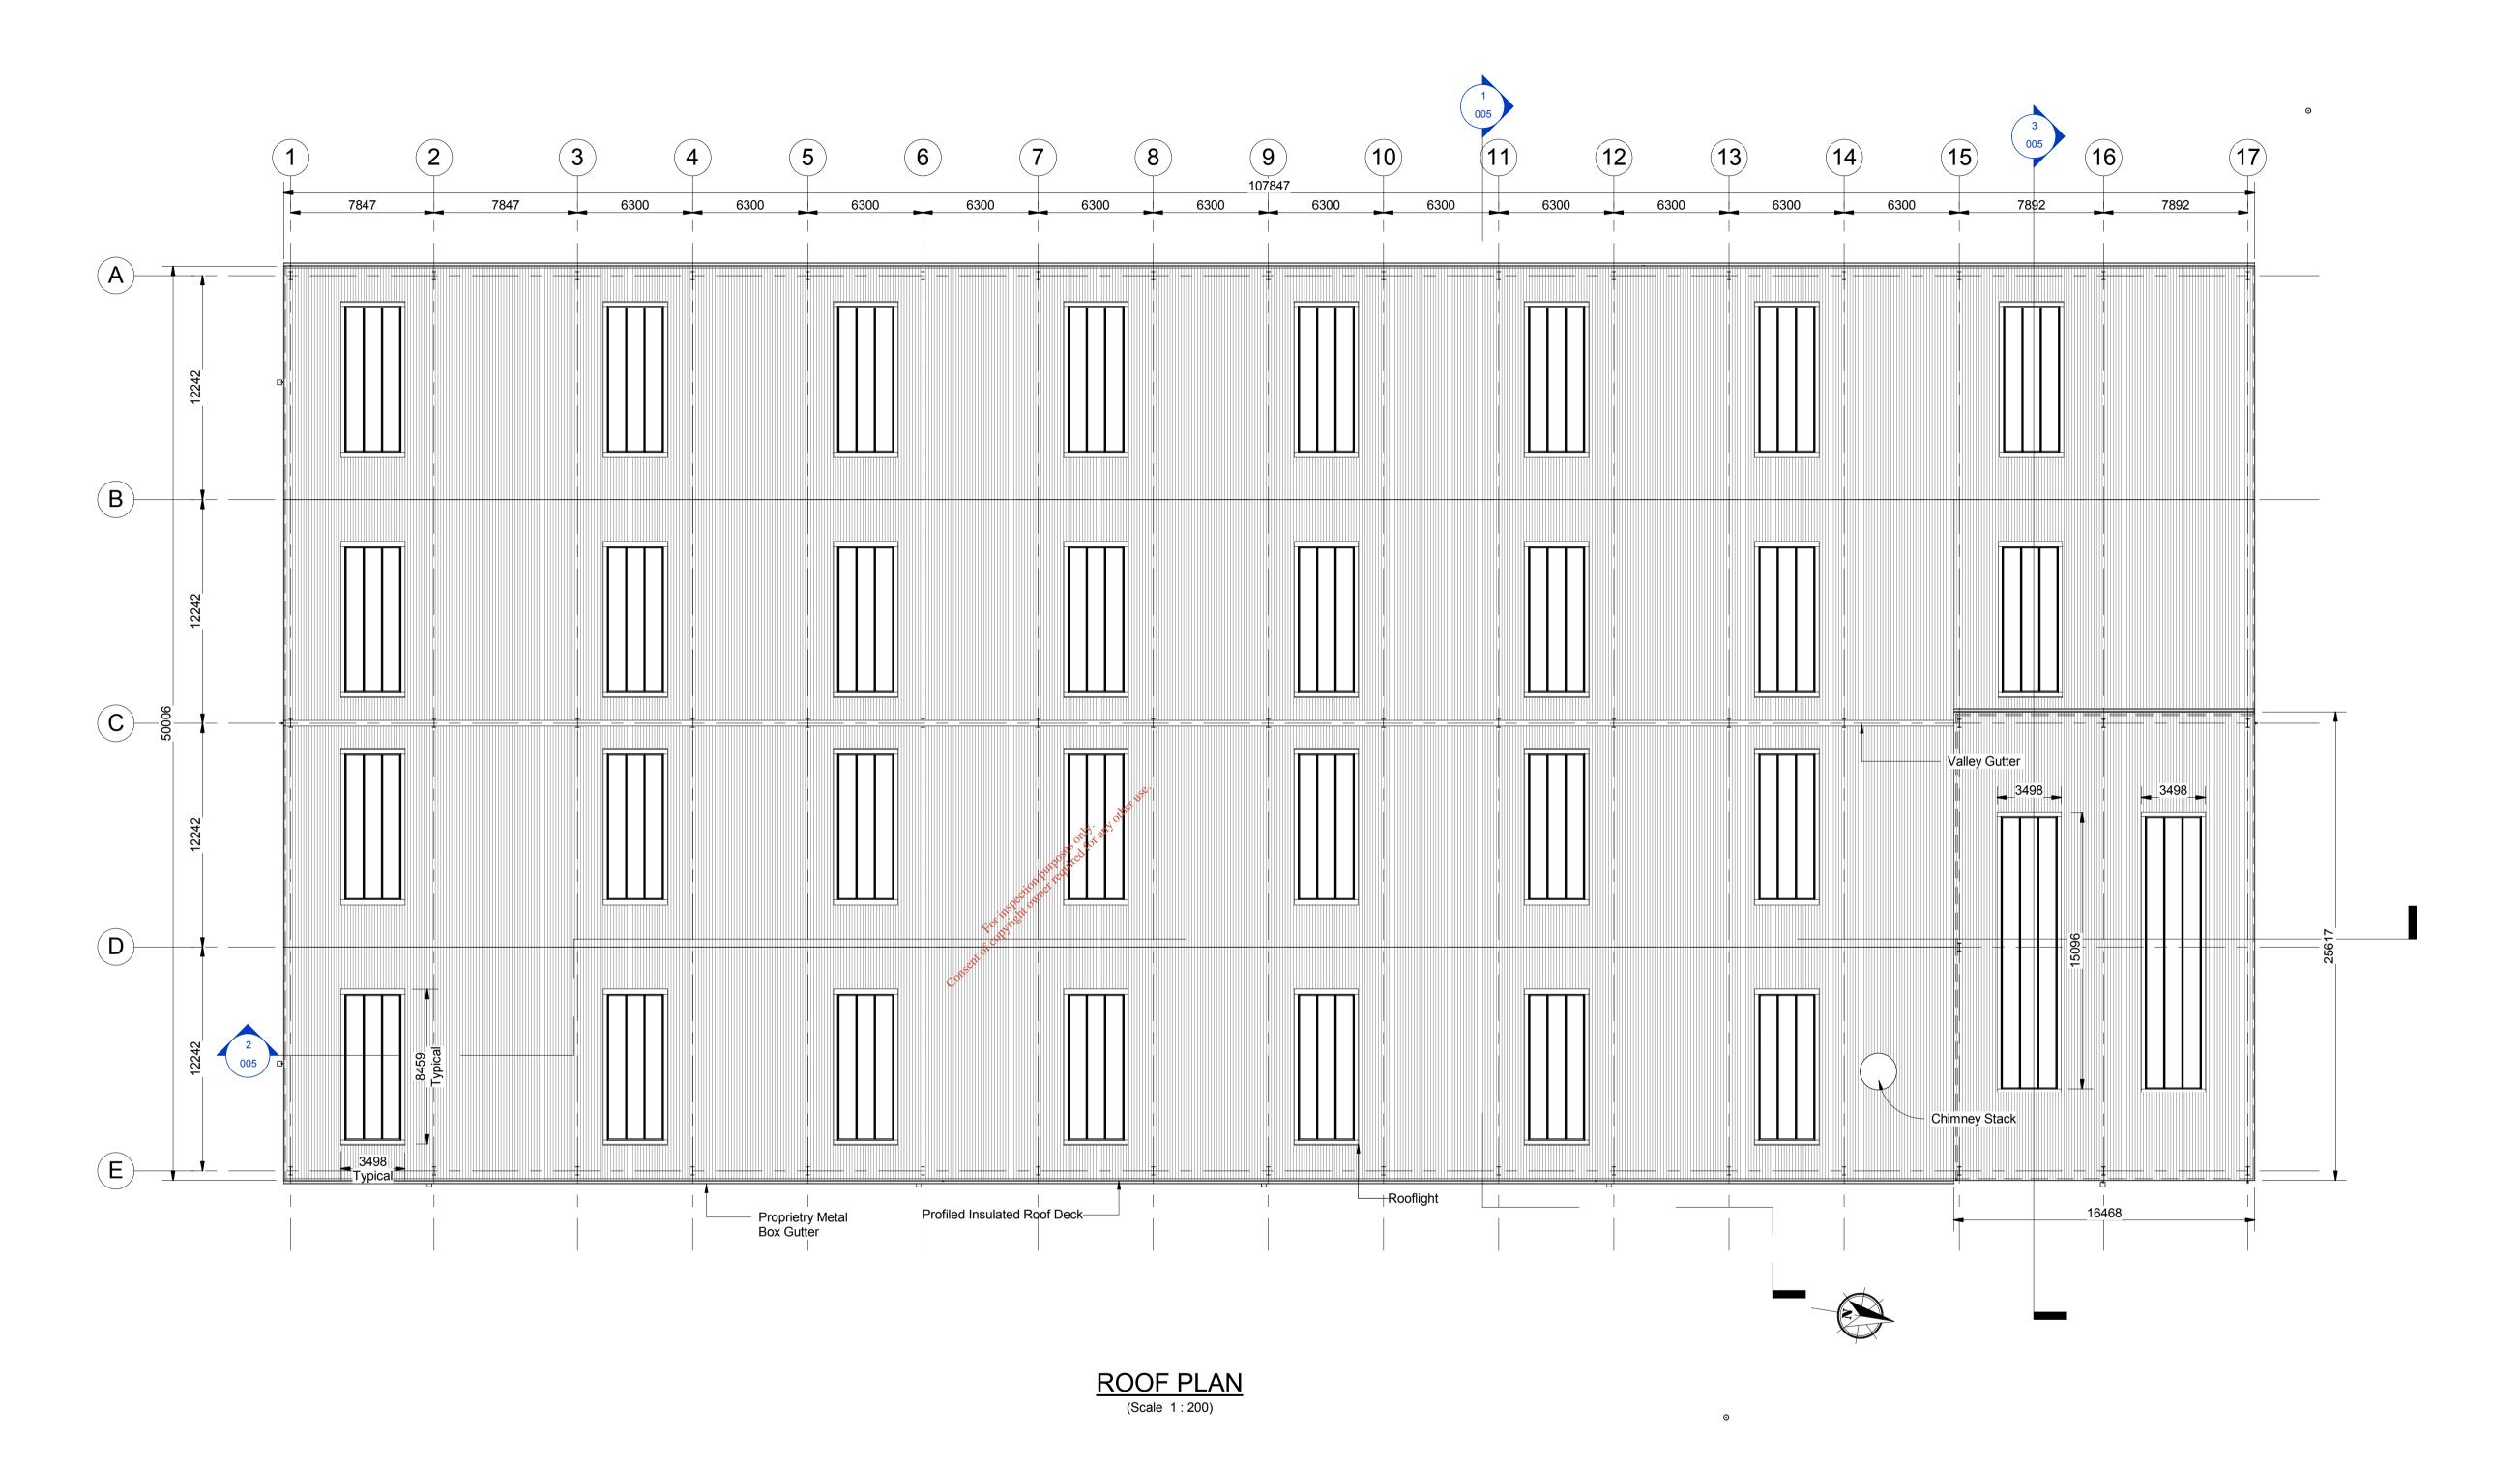
PROPOSED DEVELOPMENT AT KNOCKHARLEY LANDFILL

PROPOSED BIOLOGICAL TREATMENT FACILITY FIRST FLOOR PLAN

# KNOCKHARLEY LANDFILL Ltd.

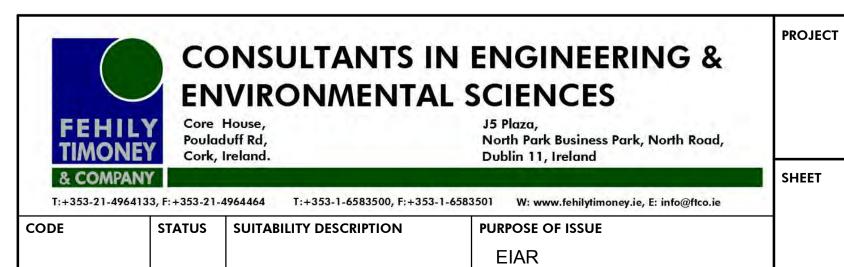
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Rev.	Description	App By	Date
A	Issue For Planning Application	BG	10.07.18

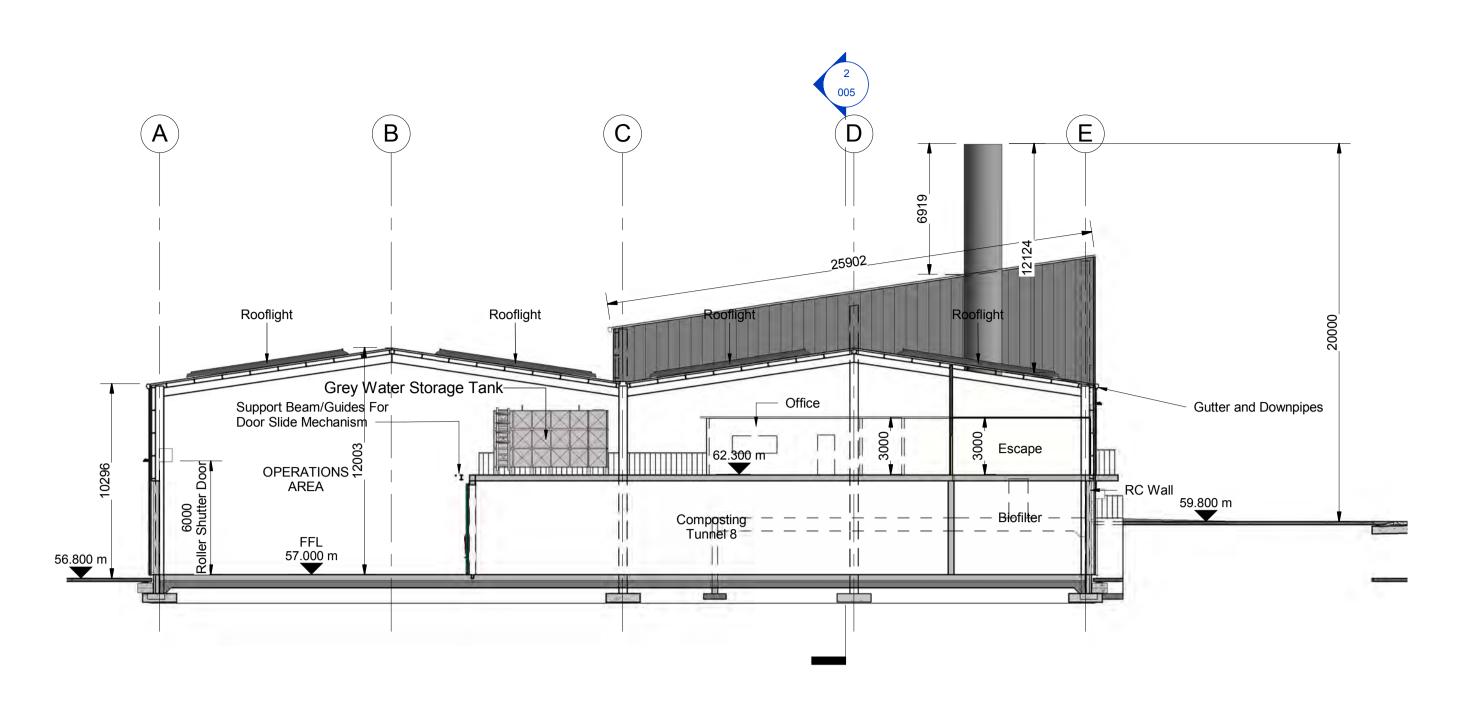


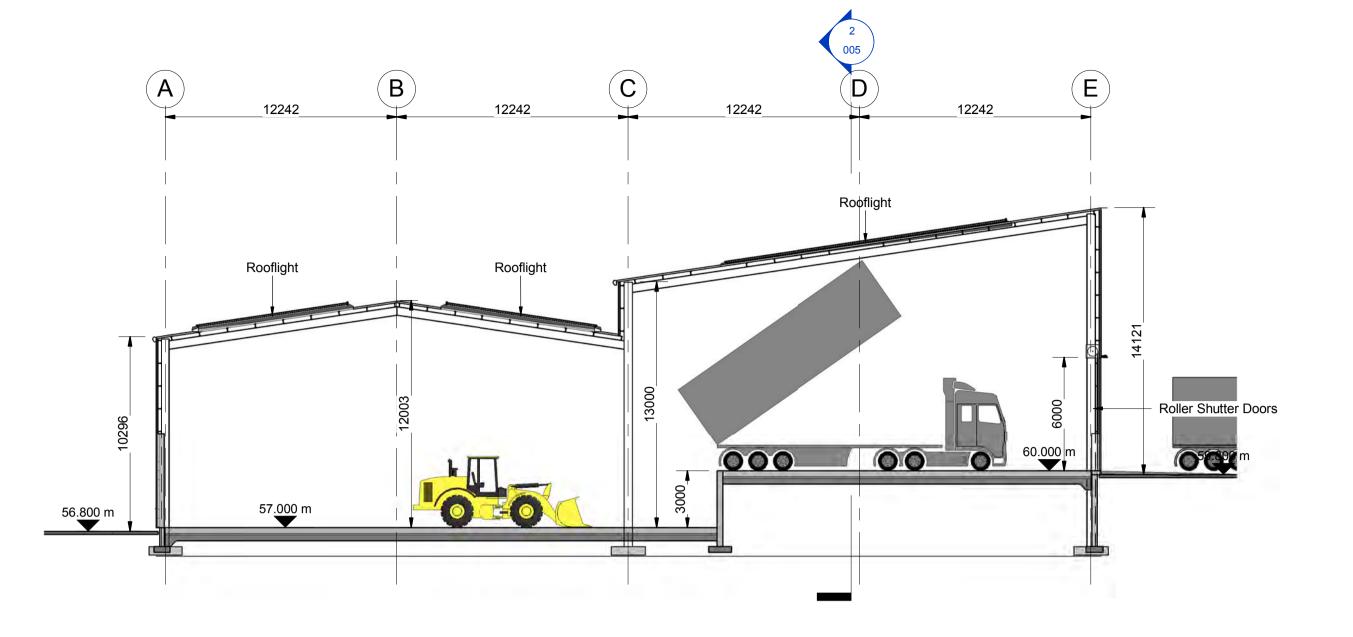
PROPOSED DEVELOPMENT AT KNOCKHARLEY LANDFILL

KNOCKHARLEY LANDFILL Ltd.

PROPOSED BIOLOGICAL TREATMENT FACILITY ROOF PLAN

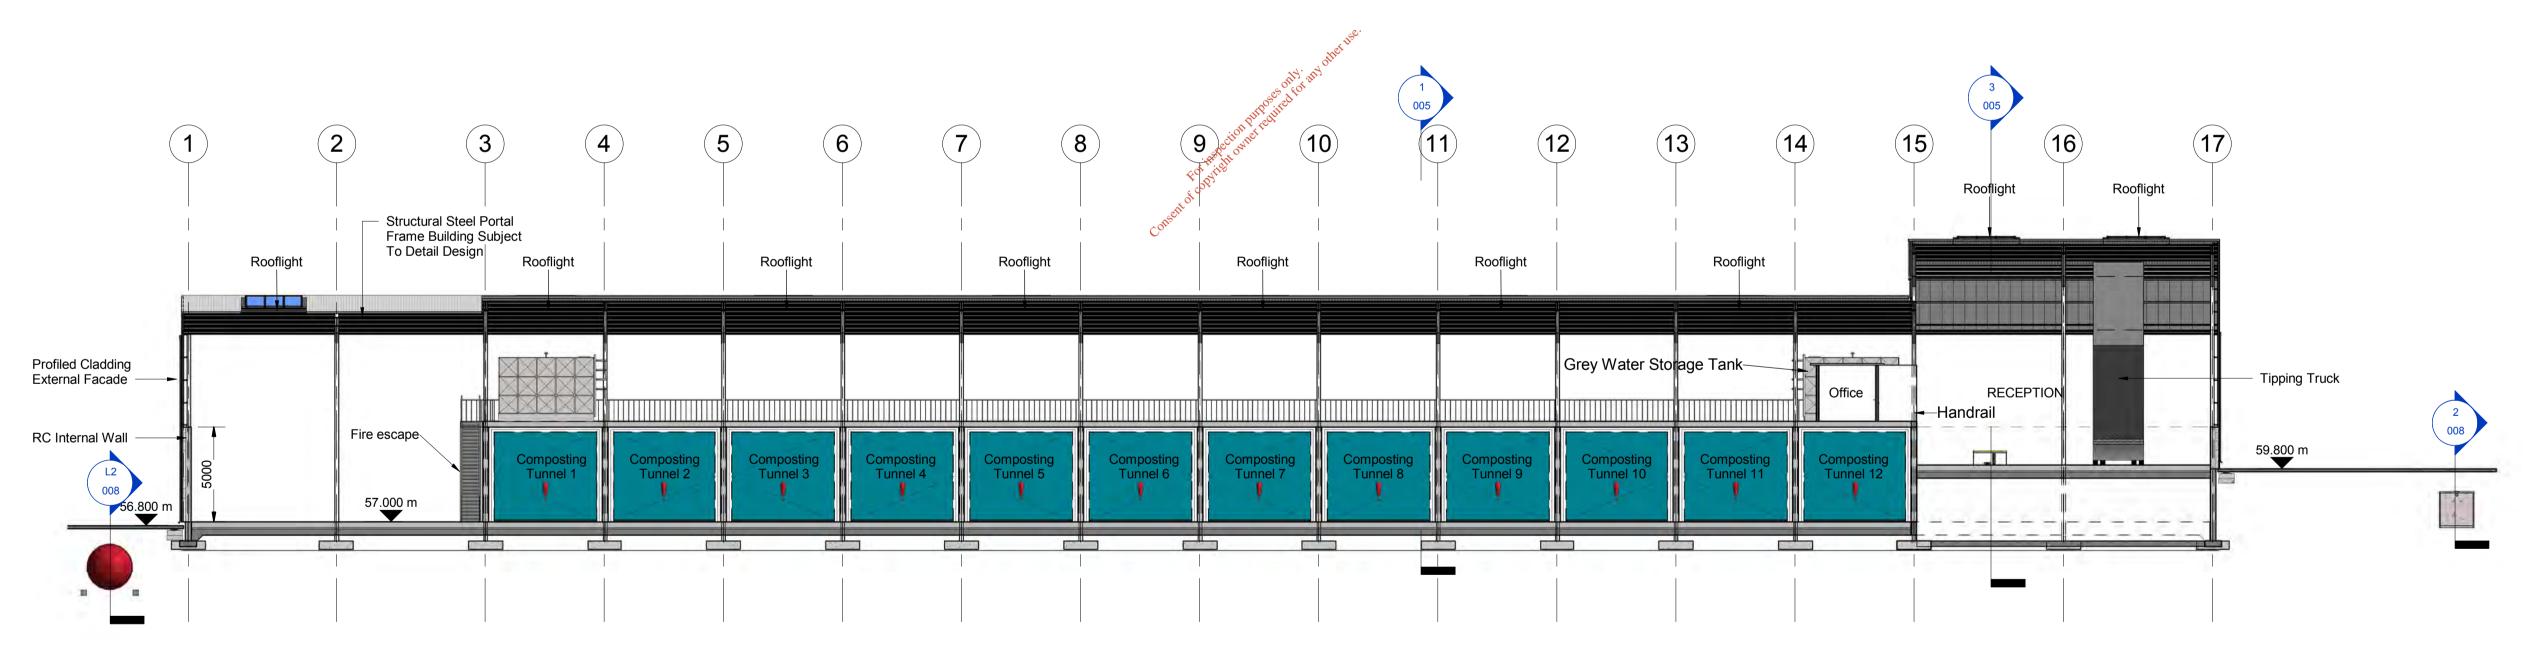
09/27/17 Drawn by SK **Drawing Number** Checked by CC LW14-821-01-P-1700-004





<u>Section 1</u> (Scale 1:200)

Section 3
(Scale 1:200)



PROJECT

SHEET

Section 2
(Scale 1:200)

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	A Property		N ENGINEERIN	
	EN	IVIRONMENTA	L SCIENCES	
FEHIL	Poula	House, duff Rd, Ireland.	J5 Plaza, North Park Business Park, N Dublin 11, Ireland	North Road,
& COMPAN	YV			
T:+353-21-4964	133, F: +353-21	.4964464 T:+353-1-6583500, F:+353	-1-6583501 W: www.fehilytimoney.ie, E	: info@ftco.ie

PROPOSED DEVELOPMENT AT
KNOCKHARLEY LANDFILL

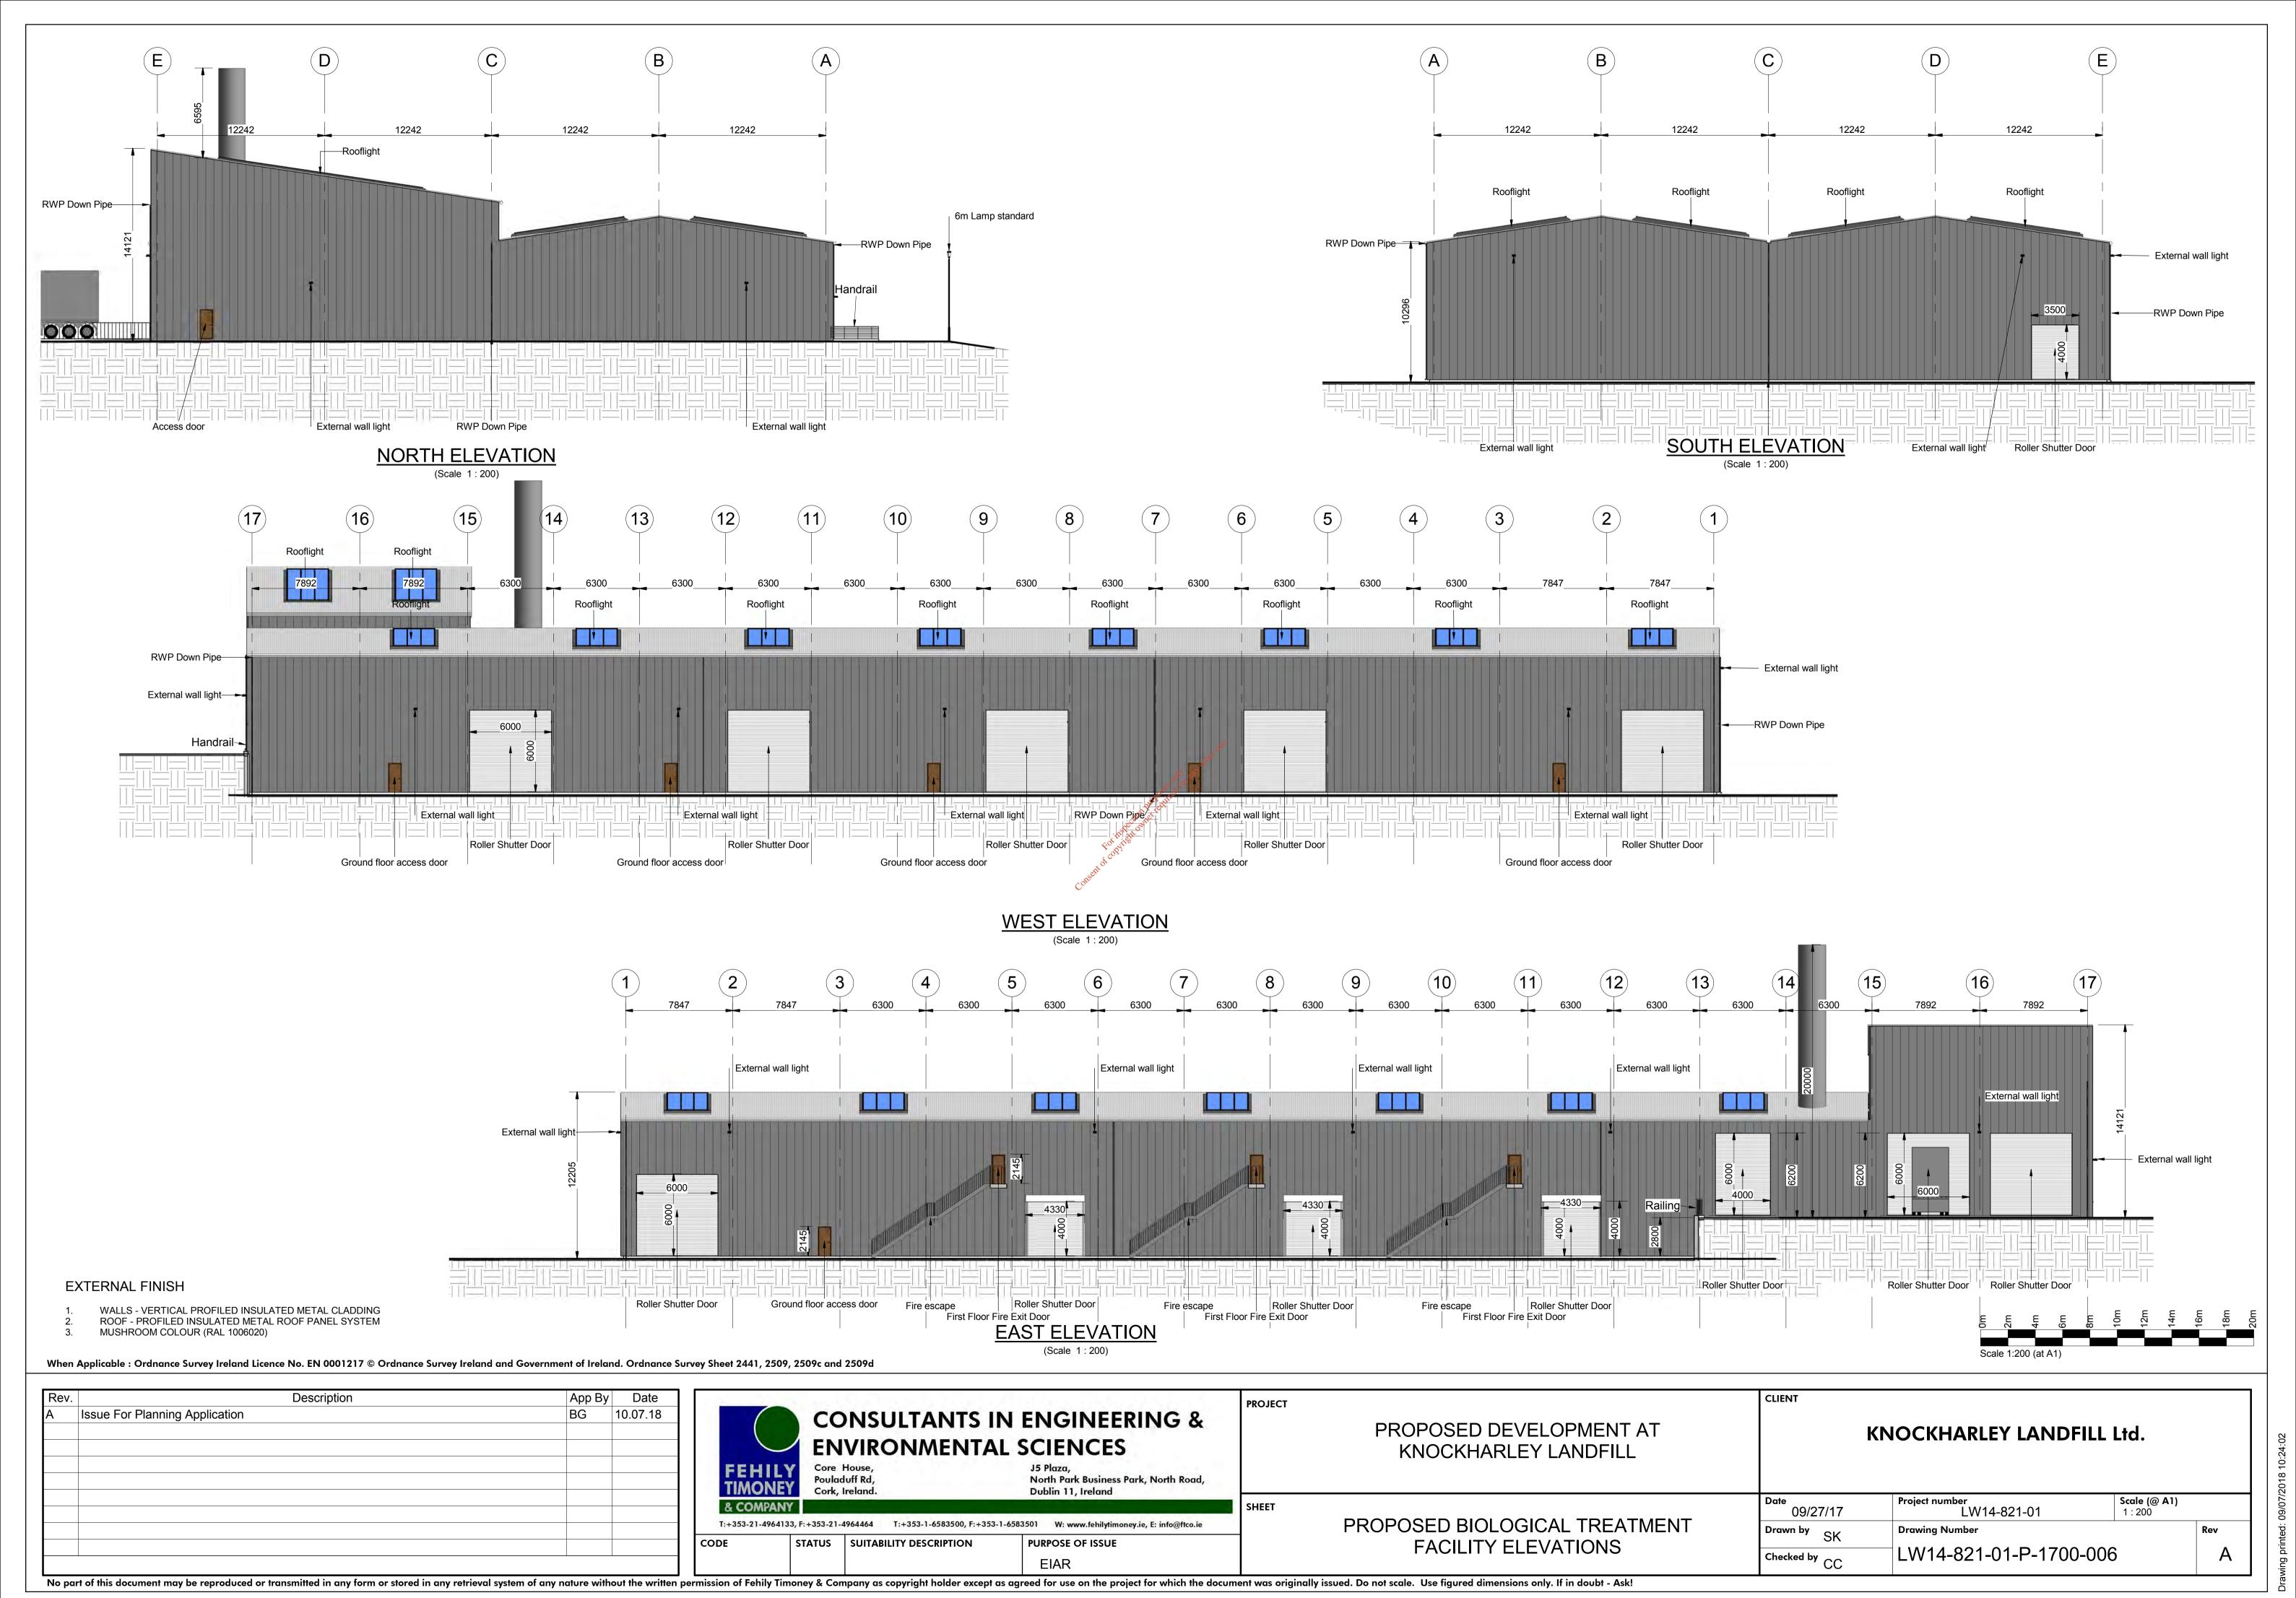
FACILITY CROSS SECTIONS

PROPOSED DEVELOPMENT AT KNOCKHARLEY LANDFILL
PROPOSED BIOLOGICAL TREATMENT

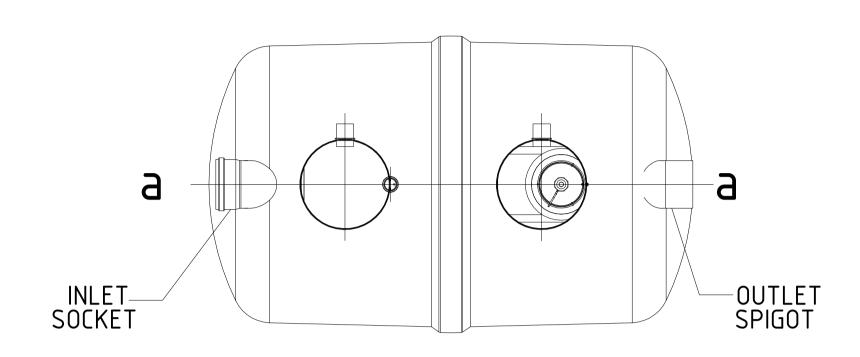
# KNOCKHARLEY LANDFILL Ltd.

Date 09/27/17	Project number LW14-821-01	<b>Scale (@ A1)</b> 1 : 200	
Drawn by SK	Drawing Number		Rev
Checked by	LW14-821-01-P-1700-005		Α

CLIENT



UNIT REF.	NOMINAL FLOW	APPROX. EMPTY	OVERALL LENGTH
UNII KLI.	RATE (L/s)	WEIGHT (kg)	<u>'</u> L'
NSFA020	20	575	3200
NSFA030	30	665	3915
NSFA040	40	740	4640
NSFA050	50	985	5425
NSFA065	65	1145	6850
INFOF	RMATION COMMON FO	R CLASS 1 & CLASS	2 UNITS



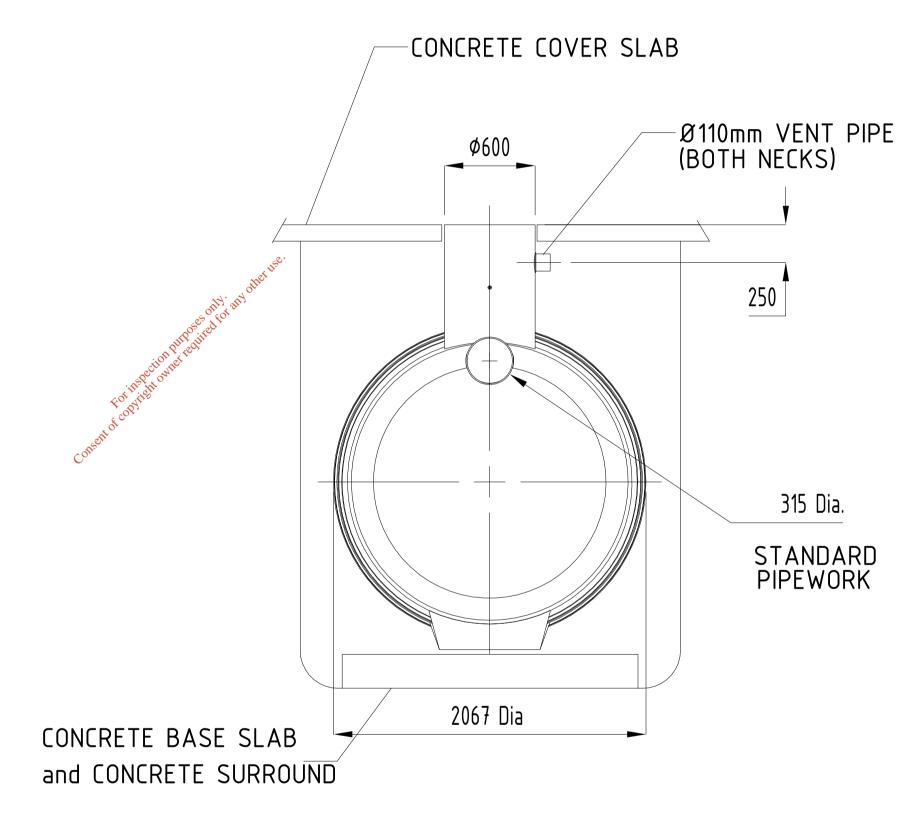
# PLAN ALARM PROBE SOCKET INVERT) INVER(TINLET INVERT) (BASE 3200

SIDE ELEVATION

### NOTES:-

- NOTES: 
   Inlet/outlet pipes are plain pipe ø315mm PVCu. The standard EN858 states minimum connection sizes, units ordered with different sized connections are not fully compliant with the standard.
   Please note. A Class 1 Separator includes filter media, Class 2 do not.
   Extension necks for deeper inverts can be provided in 0.5m increments, for on site assembly. Maximum 2.0m invert recommended.
   All units require appropriate cover and frame to suit applied loadings.

   This drawing should be used for dimensional Information only. It is essential that this drawing is read in conjunction with installation guidelines supplied with unit. (copies are available from our sales department).
   This drawing is also available on our website www.kingspanenv.com



**END ELEVATION** 

### KlargestorDetails (Scale 1:25)



Rev.	Description	App By Date		200	
A	Issue For Planning Application	BG 10.07.18		CC	NS
				EN	ONS IVIR
			FEHII	V Core	House,
			TIMON	Poula	duff Rd, Ireland.
			& COMPA	NY	
			T:+353-21-496	4133, F: +353-21	-4964464
			CODE	STATUS	SUITAB

		NSULTANTS I	N ENGINEERING &	PROJECT
FEHI	LY Core Poula	House, duff Rd, Ireland.	J5 Plaza, North Park Business Park, North Road, Dublin 11, Ireland	
& COMPANY  T:+353-21-4964133, F:+353-21-4964464  T:+353-1-6583500, F:+353-1-6583501  W: www.fehilytimoney.ie, E: info@ftco.ie			SHEET	
CODE	STATUS	SUITABILITY DESCRIPTION	PURPOSE OF ISSUE  EIAR	

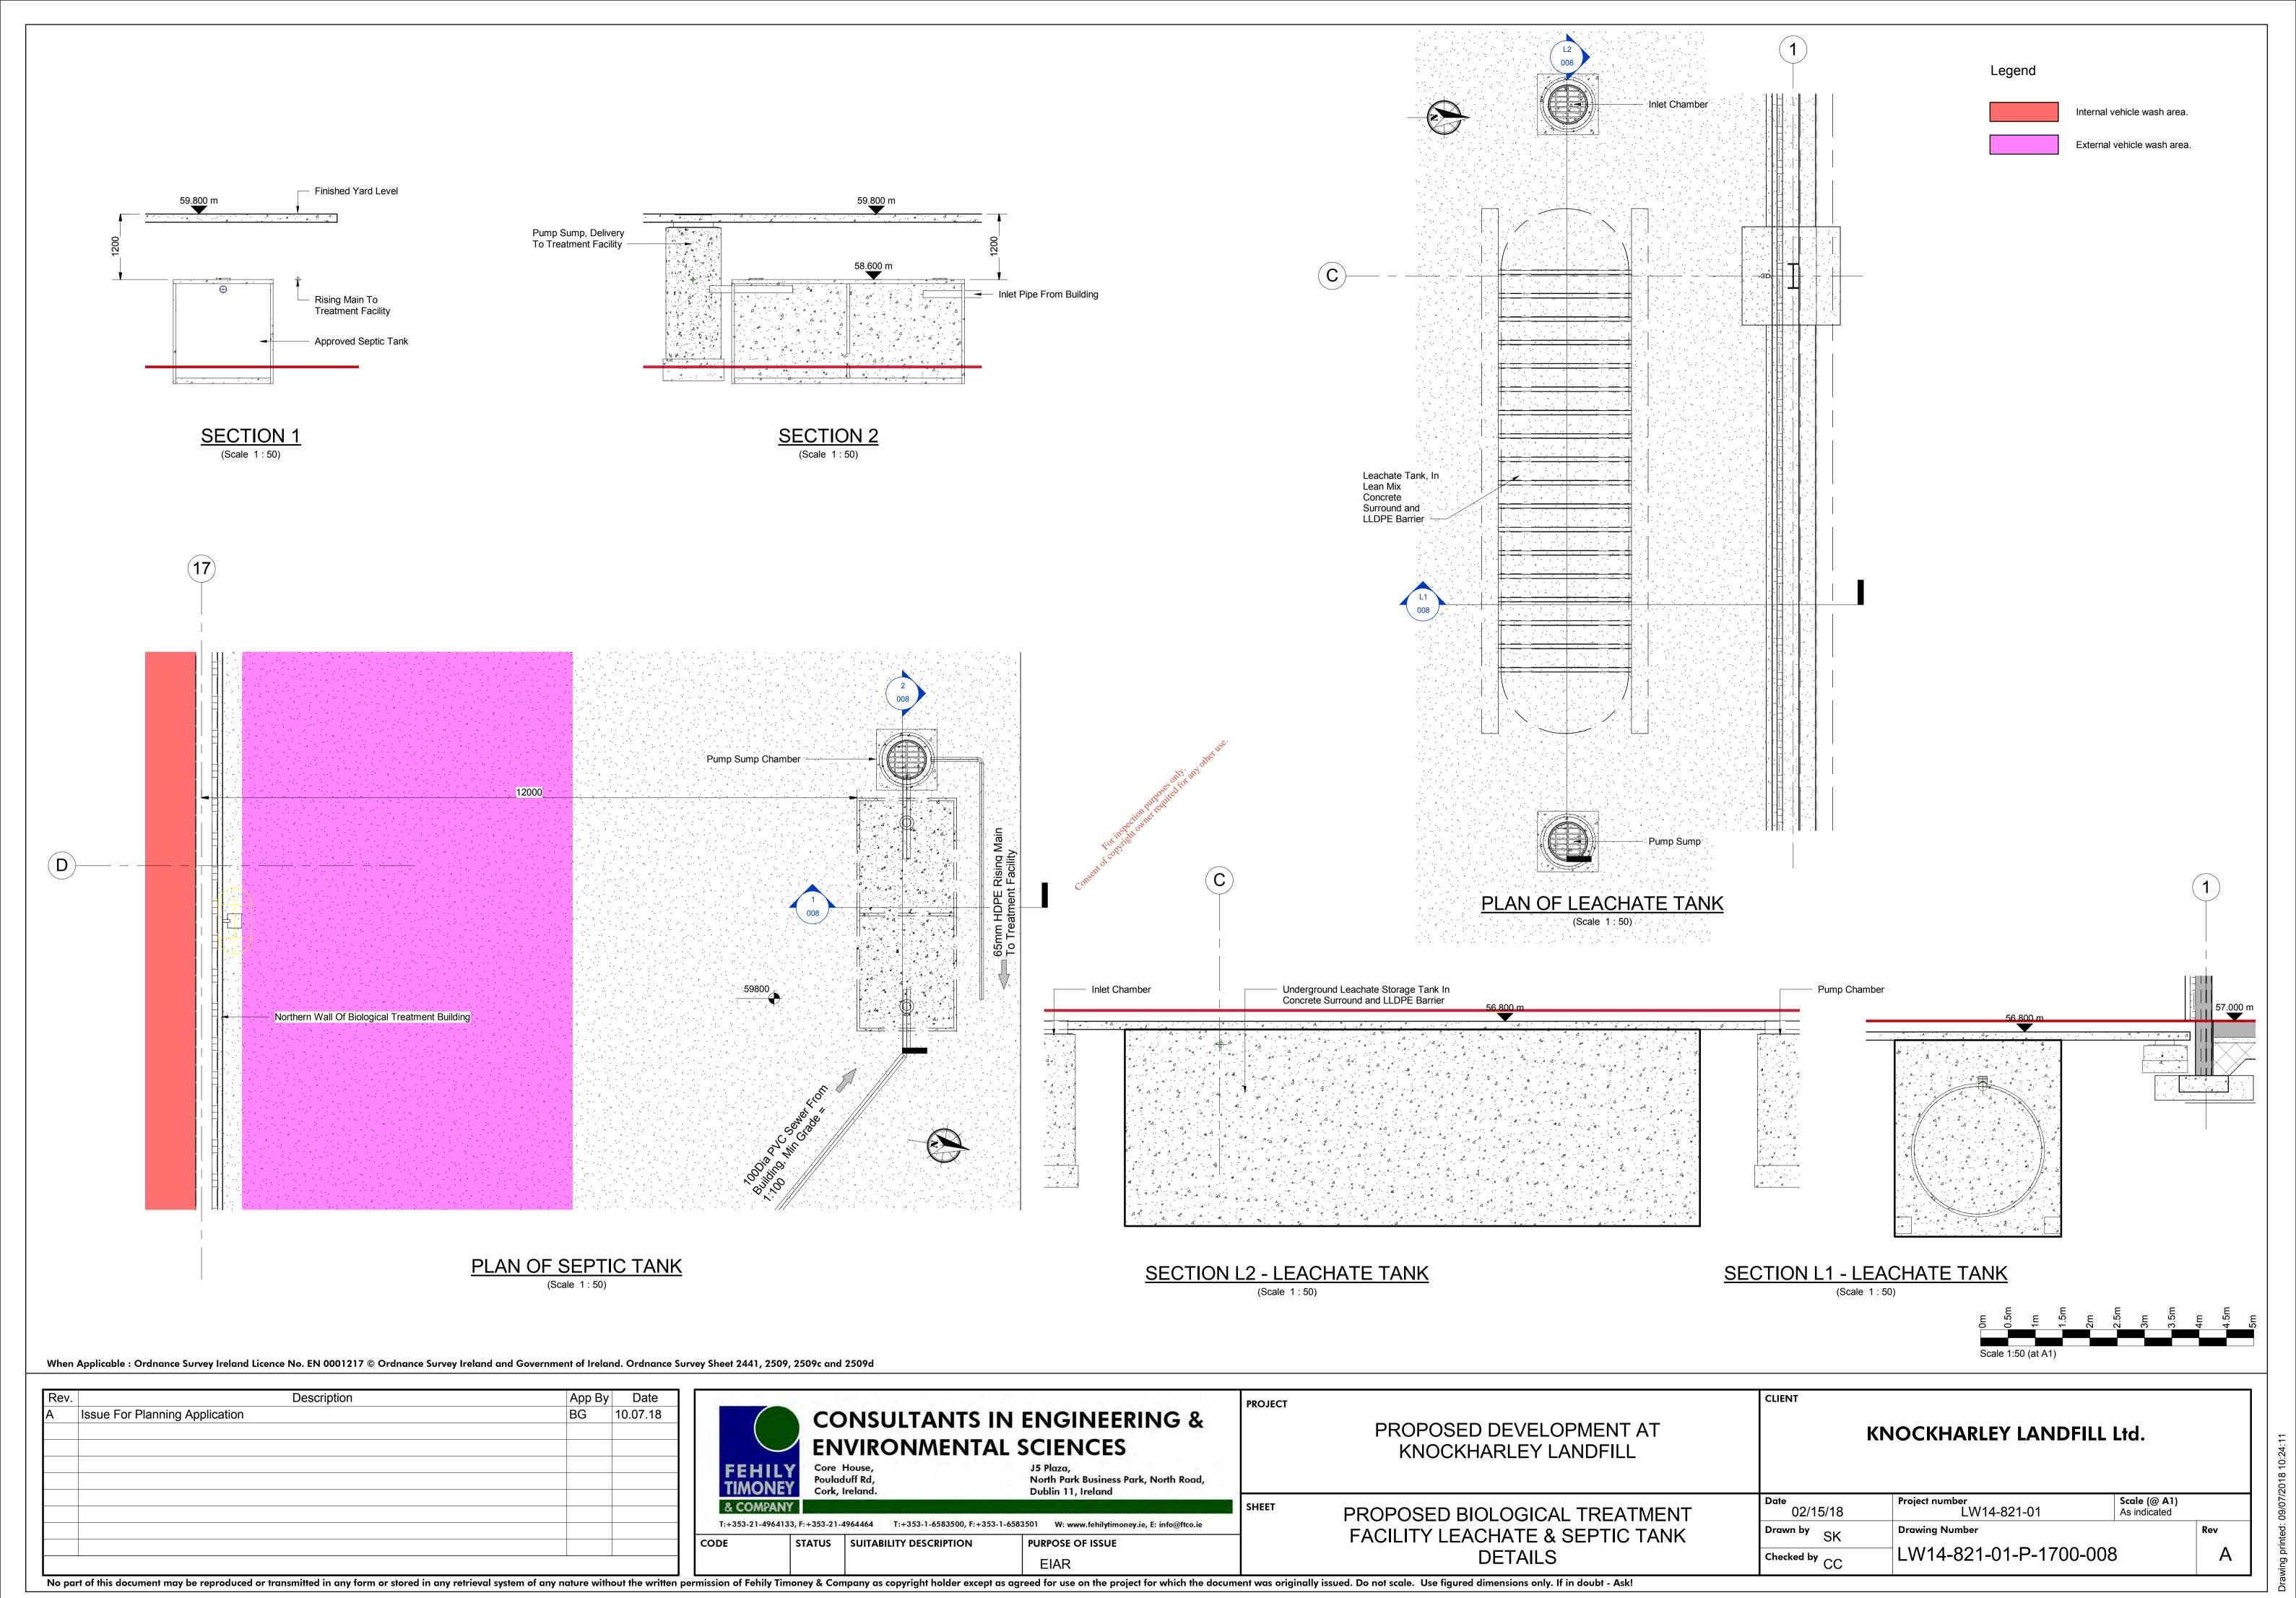
PROPOSED DEVELOPMENT AT KNOCKHARLEY LANDFILL

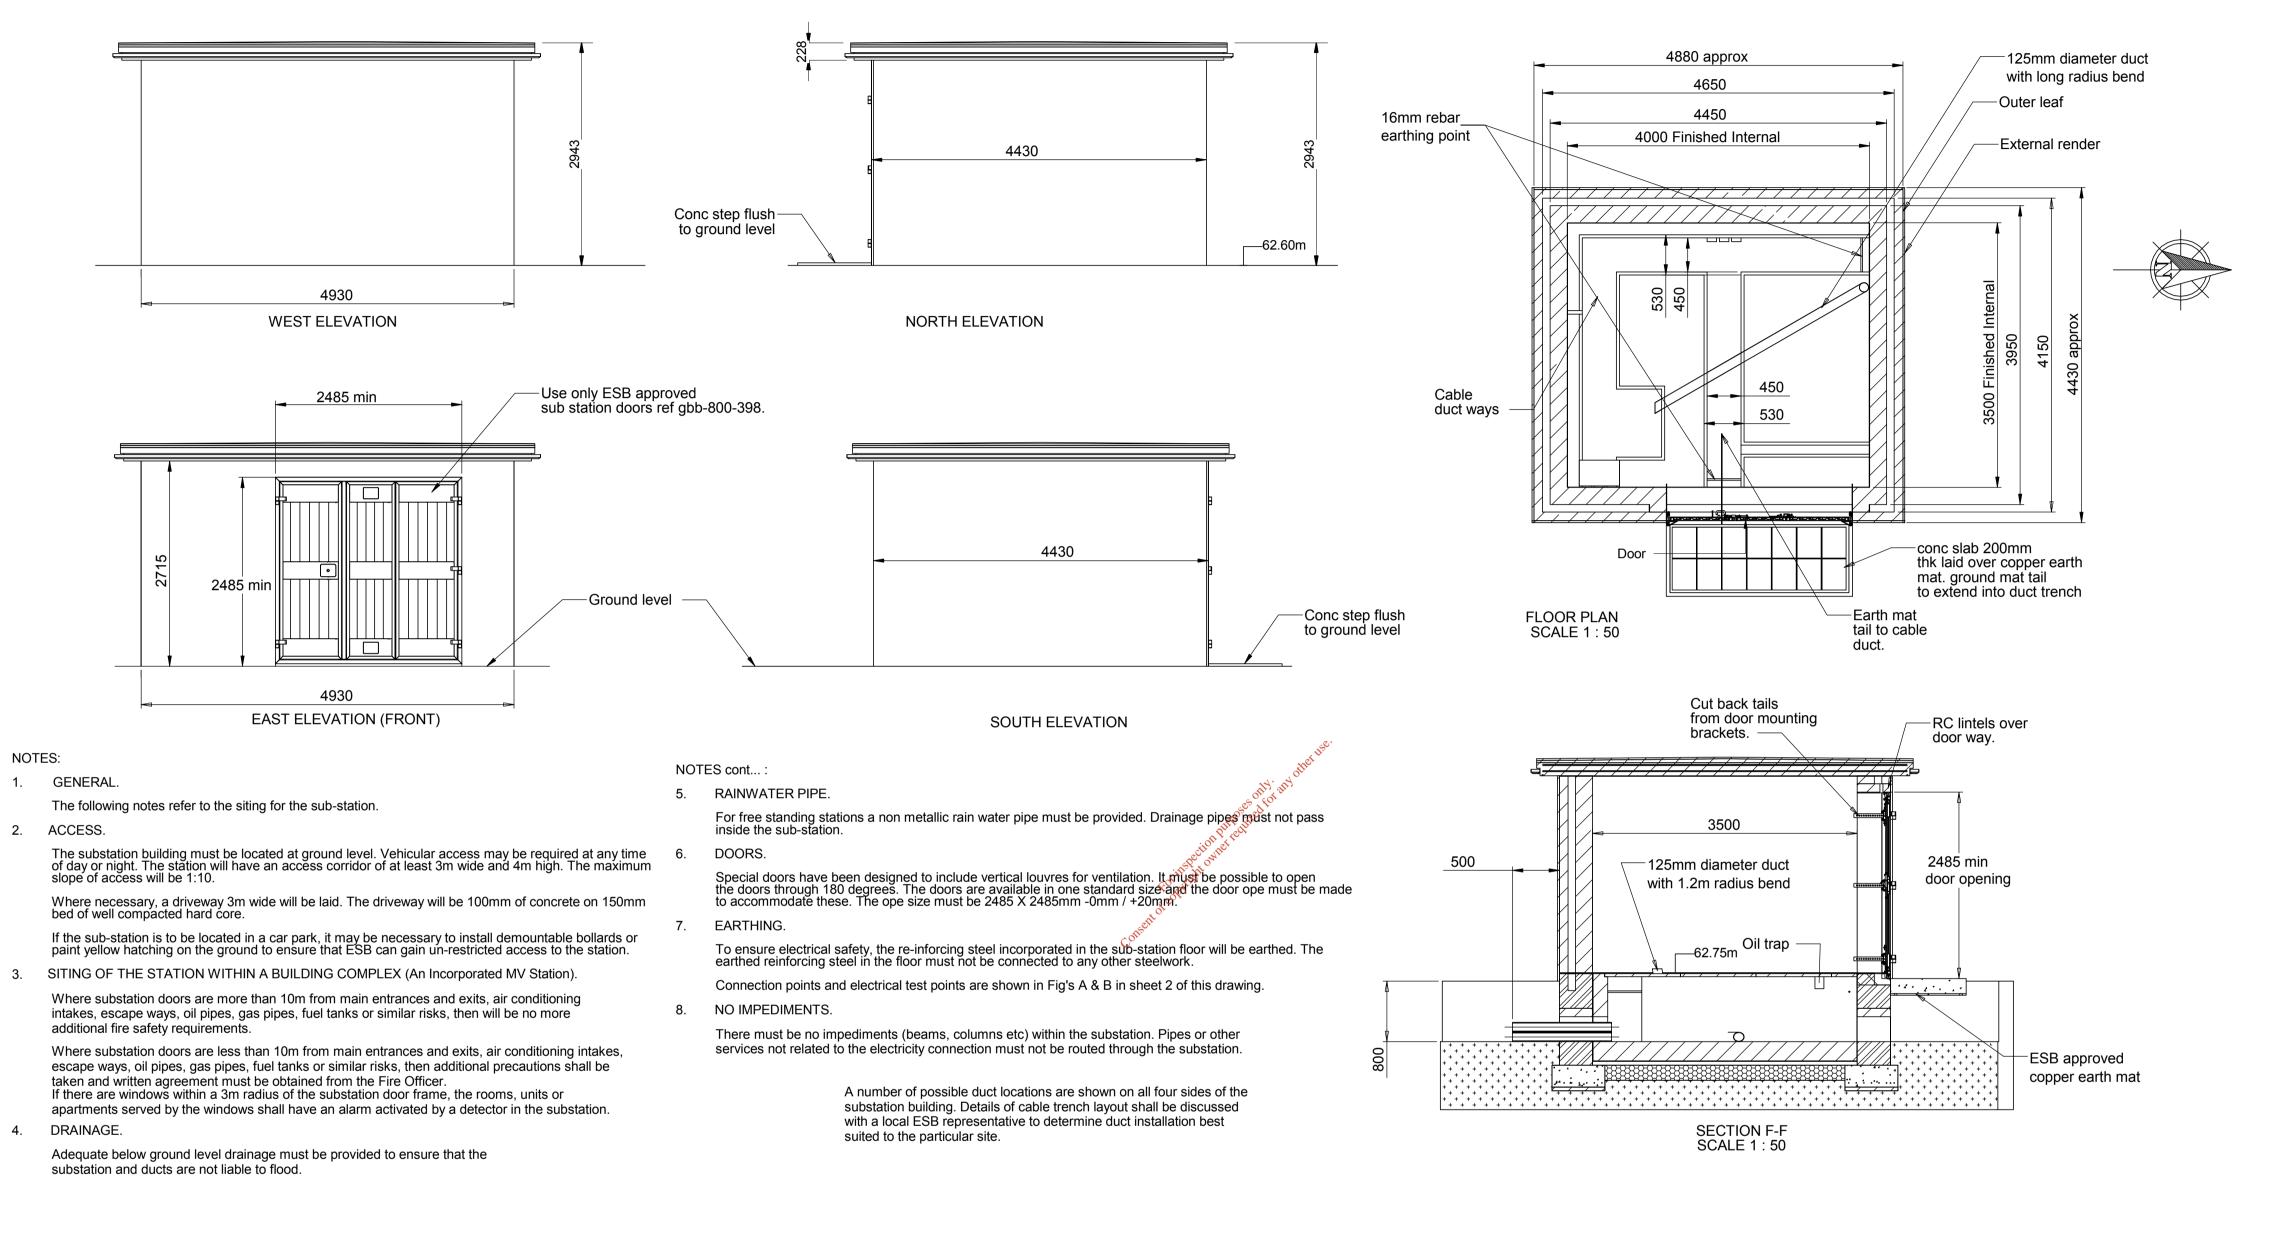
DETAILS OF FULL RETENTION OIL

**INTERCEPTOR** 

KNOCKHARLEY LANDFILL Ltd.

Date 10/04/17	Project number LW14-821-01	Scale (@ A1) 1:25				
Drawn by SK	Drawing Number					
Checked by	LW14-821-01-P-1700-007					



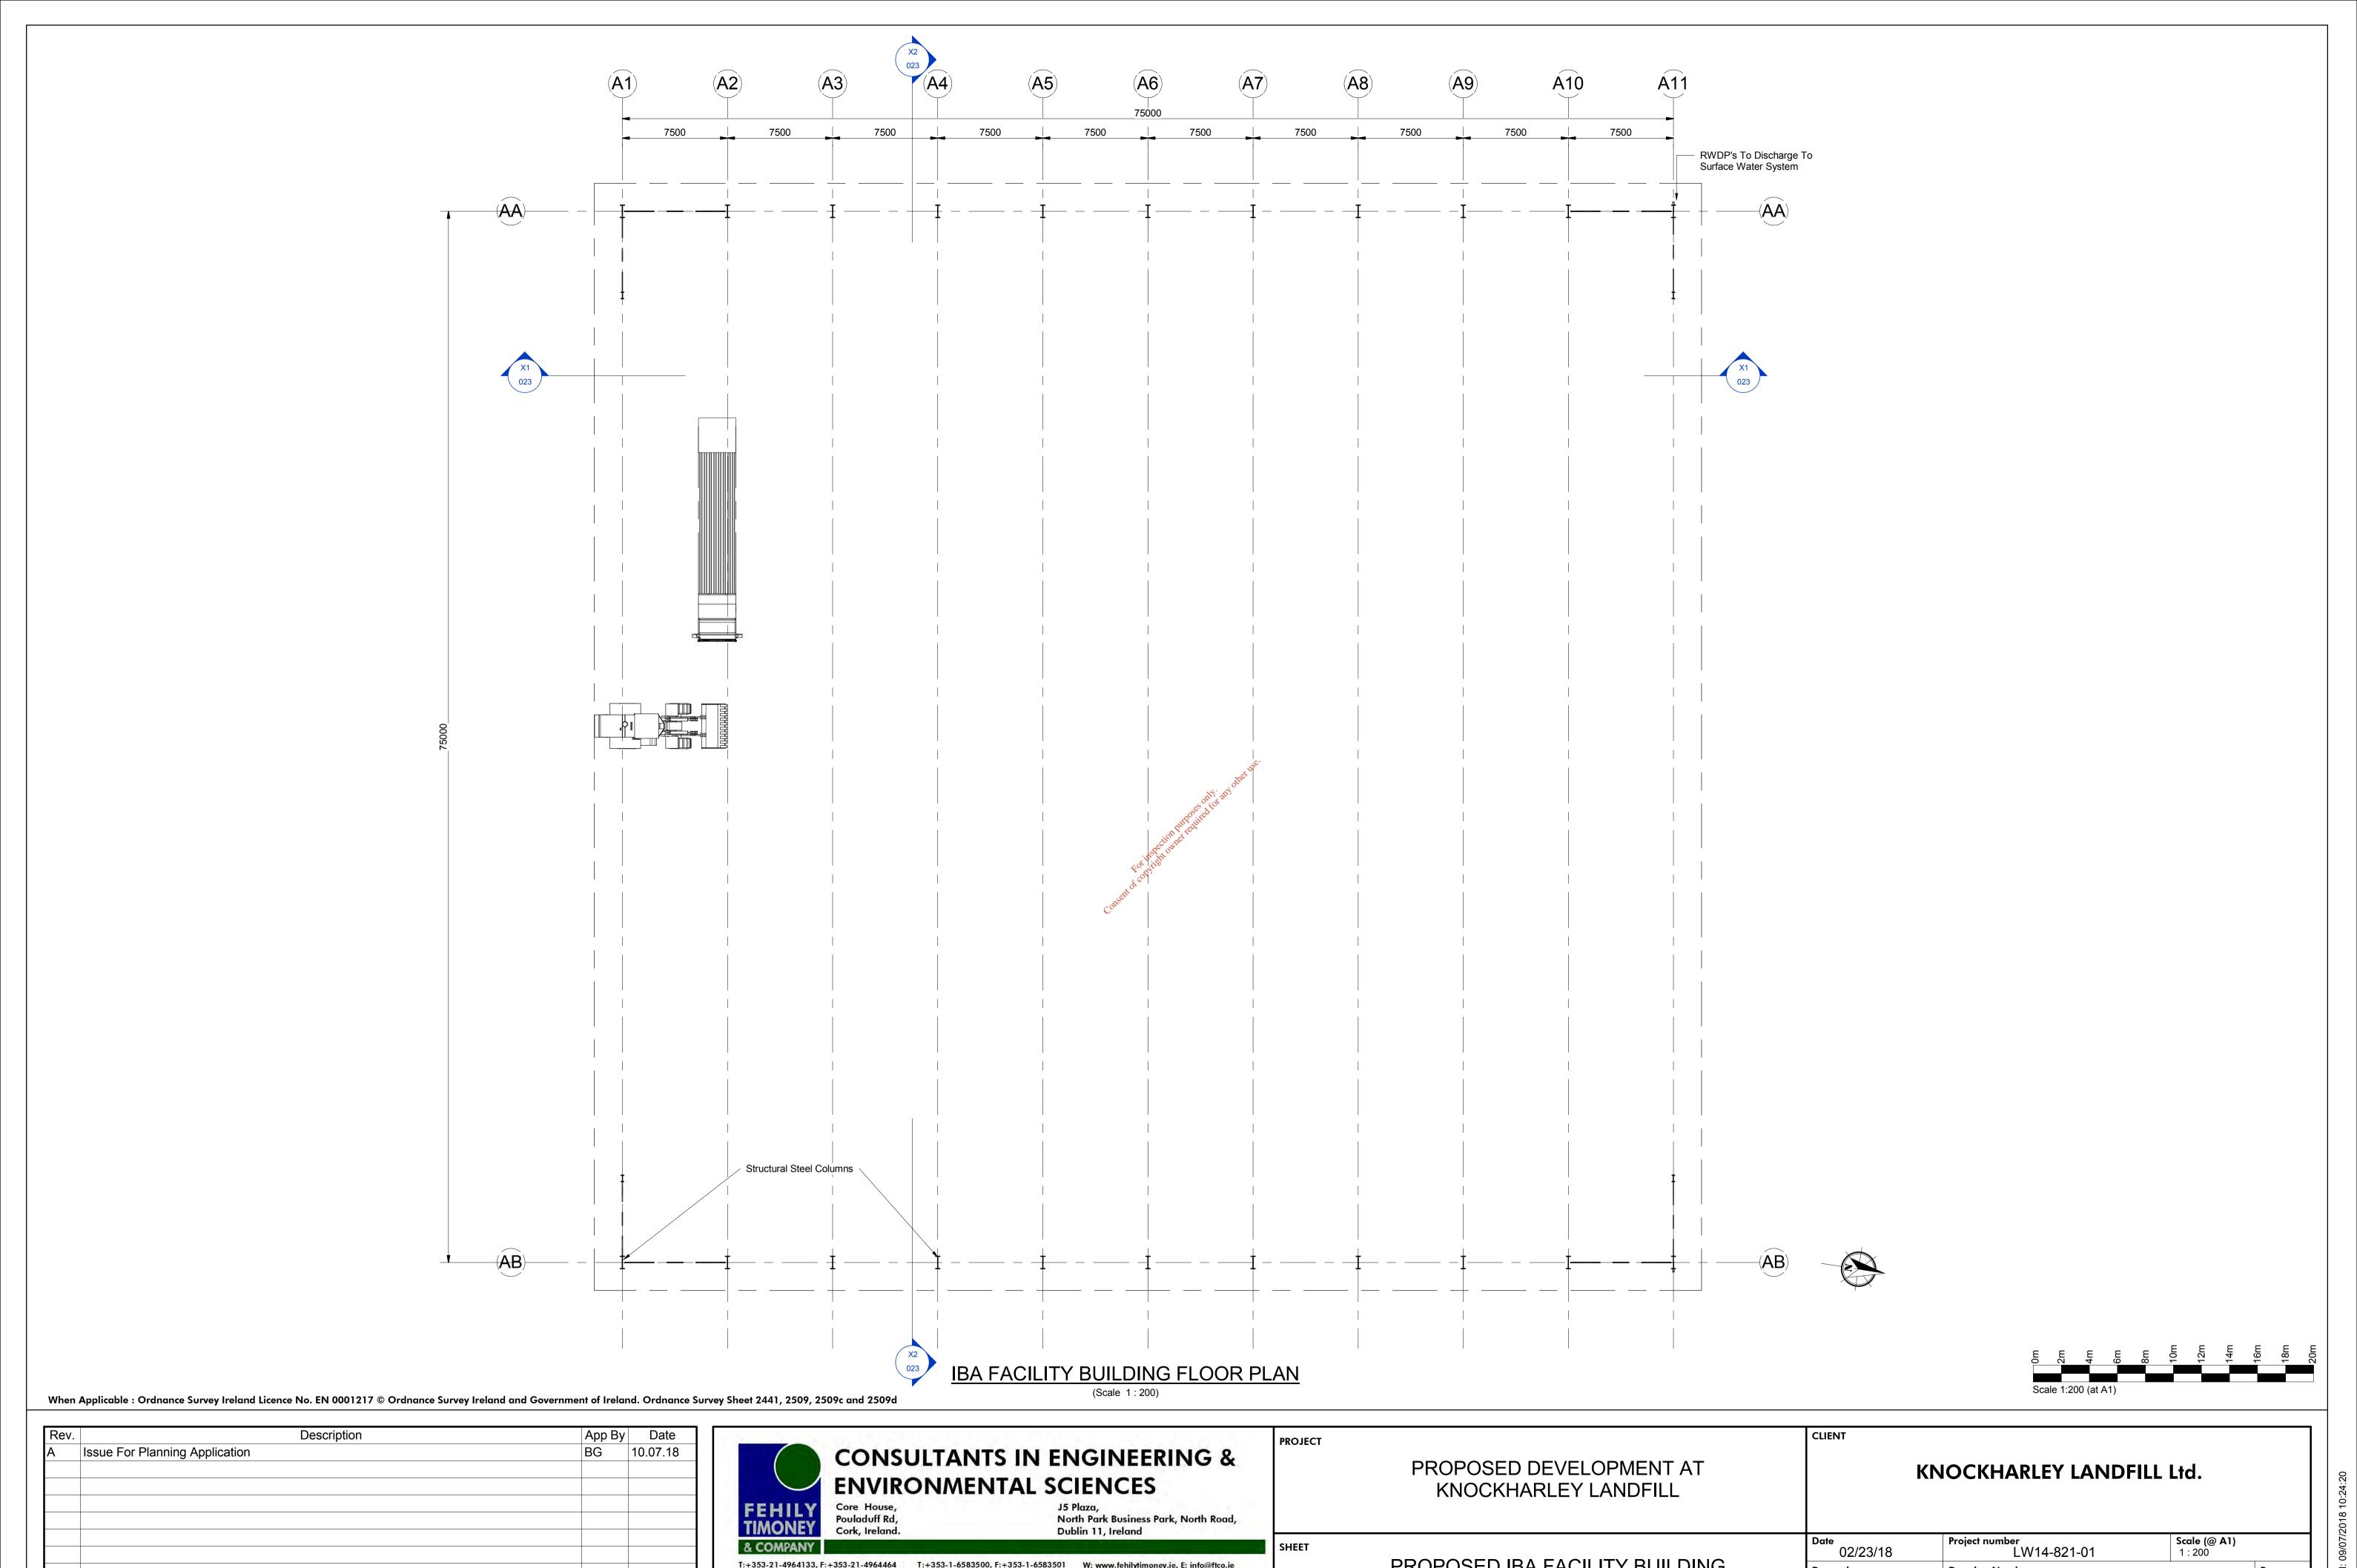


**ESB SUB STATION DETAILS** 

Scale 1:50 (at A1)

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Rev. Description  A Issue For Planning Application	App By Date BG 10.07.18	CONSULTANTS IN ENGINEERING & ENVIRONMENTAL SCIENCES  Core House, Pouladuff Rd, Cork, Ireland.  CONSULTANTS IN ENGINEERING & IN ENGINEERING & Discrete Structure of the second of the sec		PROJECT	PROPOSED DEVELOPMENT AT KNOCKHARLEY LANDFILL	MITOCKI IAKELI LANDI ILL LIG		L Ltd.	
		& COMPANY		SHEET		11/07/17	Project number LW14-821-01 Drawing Number	Scale (@ A1) 1:50	
		CODE	STATUS SUITABILITY DESCRIPTION	PURPOSE OF ISSUE EIAR		ESB MV SUBSTATION DETAILS	Checked by CC	LW14-821-01-P-1700-0	



PROPOSED IBA FACILITY BUILDING

**FLOOR PLAN** 

Drawn by SK

Checked by CC

Drawing Number

Rev LW14-821-01-P-1700-021 Α EPA Export 08-09-2021:02:46:12

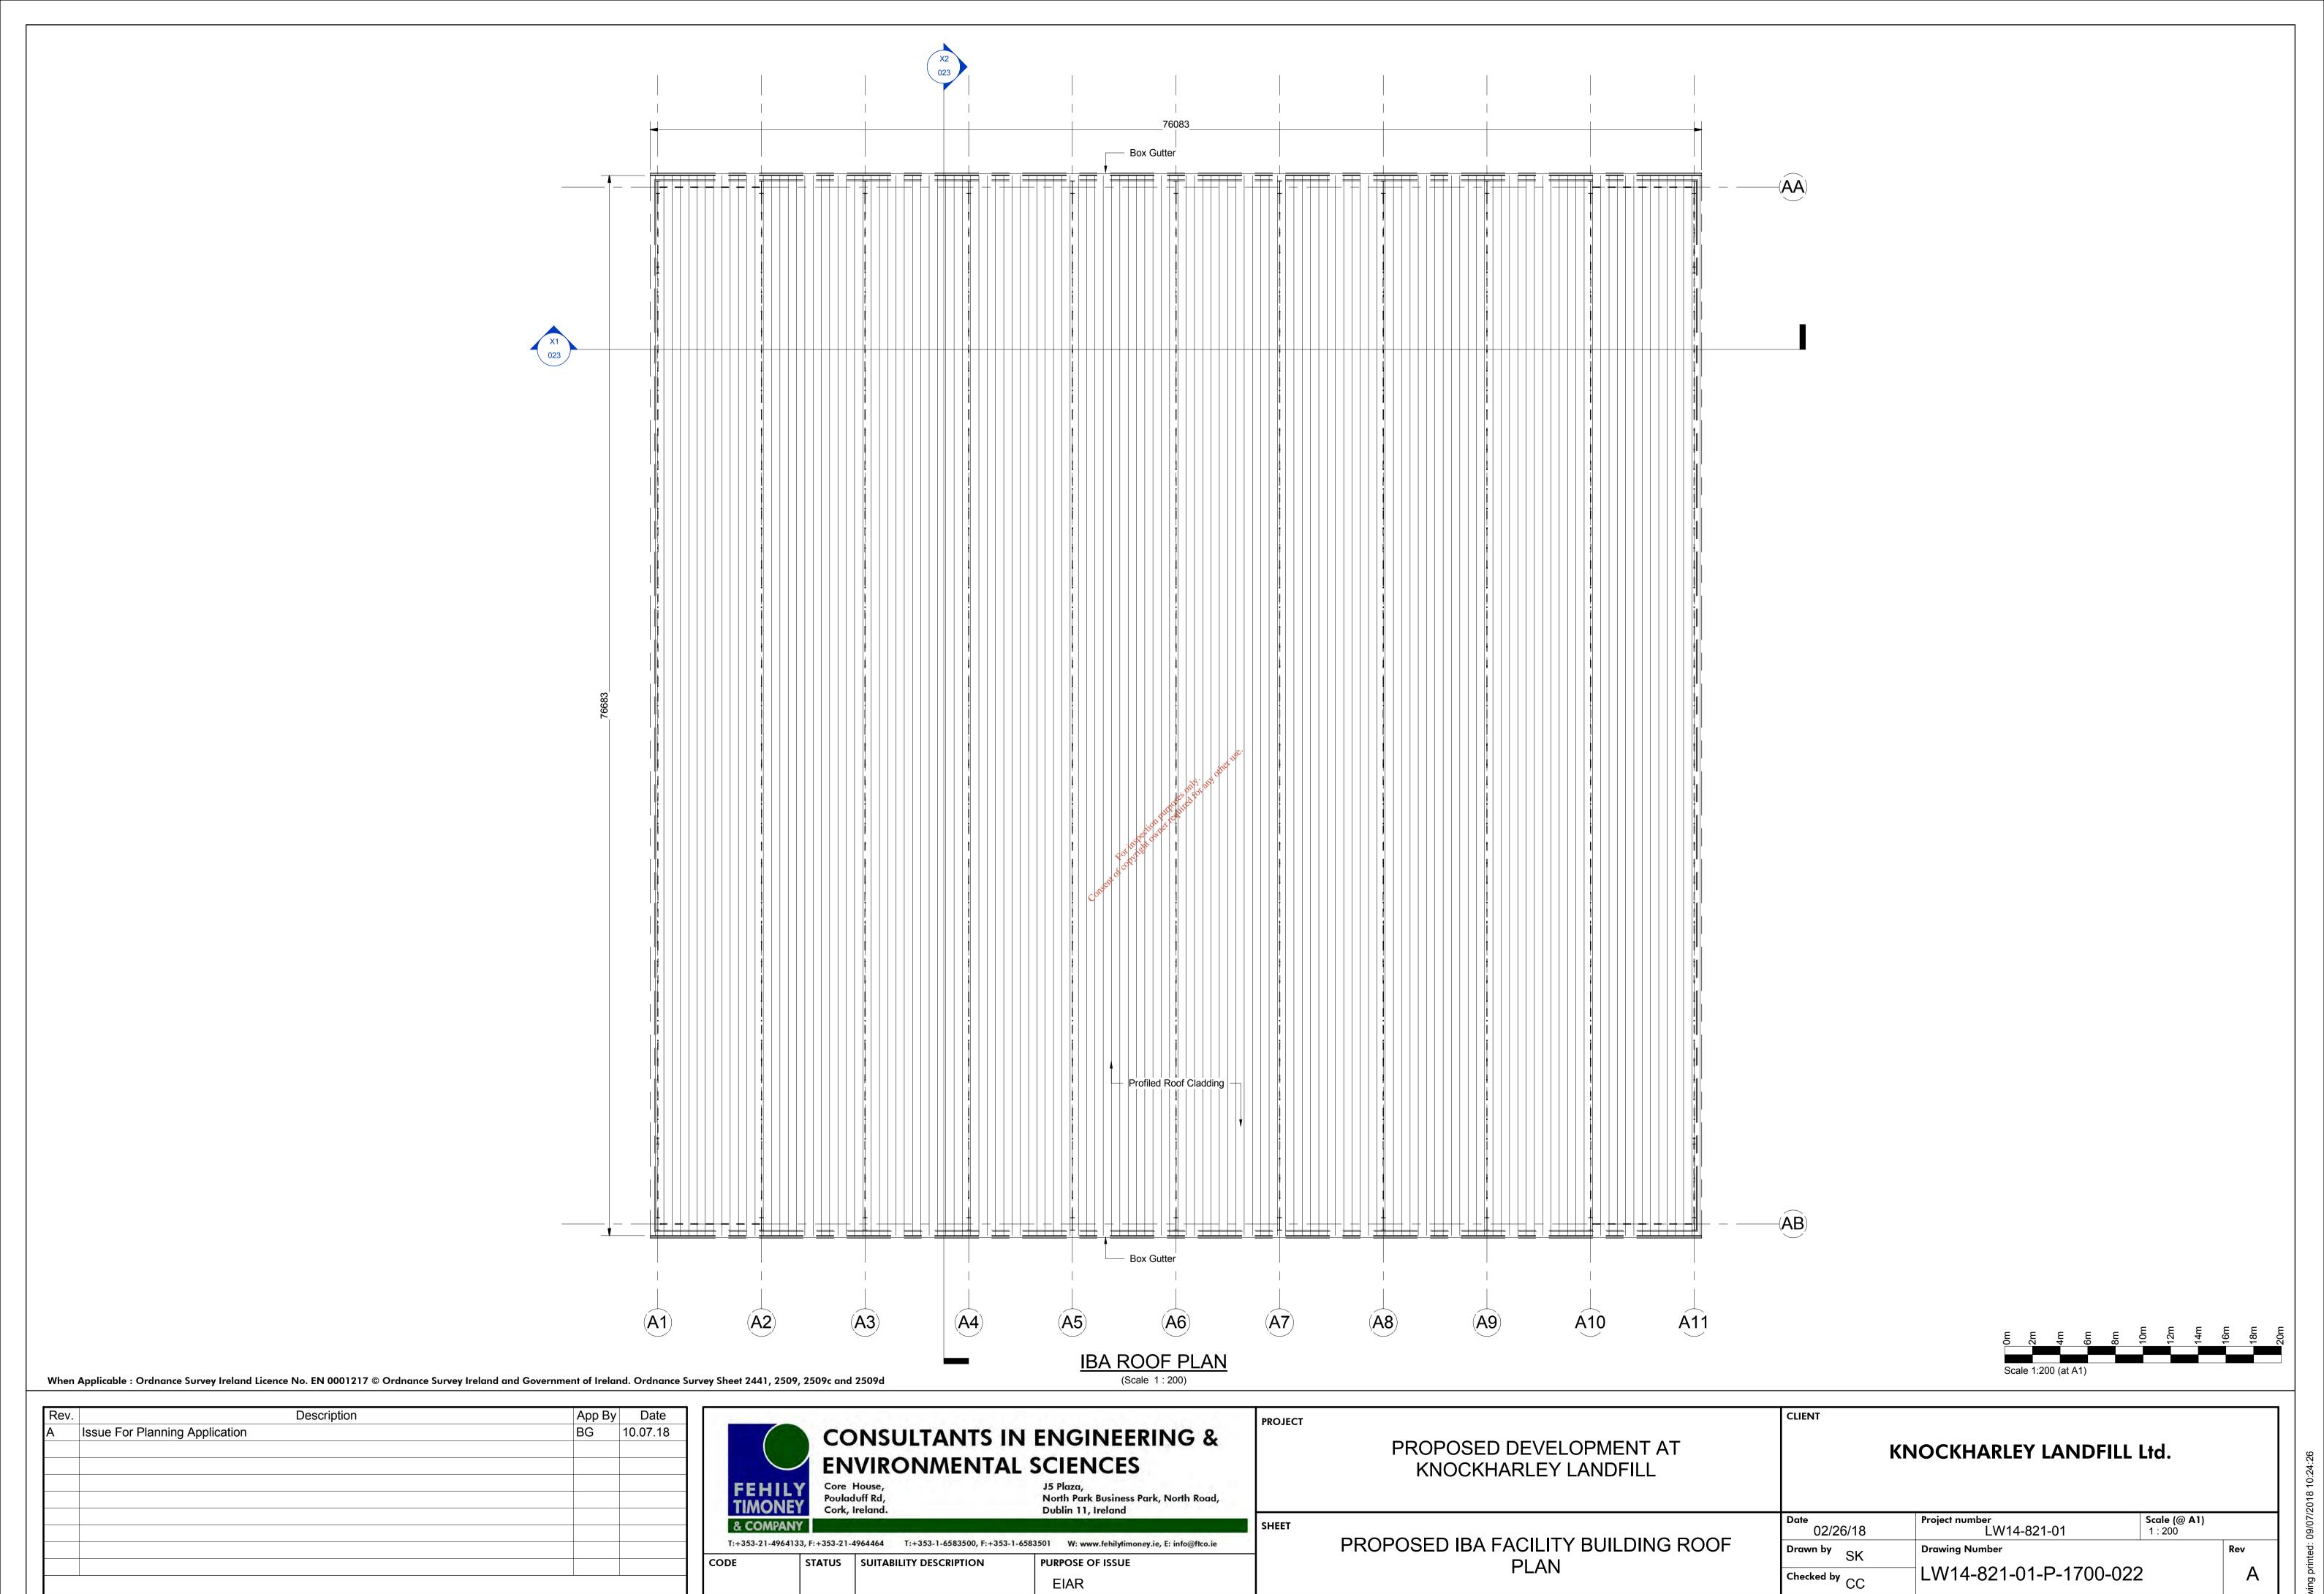
STATUS SUITABILITY DESCRIPTION

CODE

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