

SECTION 5

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APPENDIX 2.3.1

Noise Calibration Certificate and Noise Glossary

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GLOSSARY

Ambient Noise

Totally encompassing sound in a given situation at a given time usually composed of a sound from many sources near and far.

Background noise level

The A-weighted sound pressure level of the residual noise at the assessment position that is exceeded for 90% of a given time interval, T measured using time weighting F, and quoted to the nearest whole number of decibels.

Day:

0800 hrs to 2200 hrs

Night:

2200 hrs to 0800 hrs

Decibel (dB)

The unit of sound pressure level, calculated as a logarithm of the intensity of sound. 0 dB is the threshold of hearing, 140 dB is the threshold of pain. A change of 1 dB is detectable only under laboratory conditions. A change of 10 dB corresponds approximately to halving or doubling the loudness of sound.

dB(A)

Decibels measured on a sound level meter incorporating a frequency weighting (A weighting) which differentiates between sound of different frequency (pitch) in a similar way to the human ear. Measurements in dB(A) broadly agree with peoples assessment of loudness.

Hertz (Hz)

Unit of frequency (pitch) of a sound.

Impulsive Noise

A noise which is of short duration (typically less than one second), the sound pressure level of which is significantly higher than the background.

1/3 Octave band analysis

Frequency analysis of sound such that the frequency spectrum is sub divided into bands of one third of an octave each. An octave is taken to be the frequency interval, the upper limit of which is twice the lower limit (in Hertz).

L(A)_{eq}

Equivalent Continuous A-weighted Sound Level. The continuous steady noise level, which would have the same total A-weighted acoustic energy as the real fluctuating noise measured over the same period of time.

L(A)₁₀

The noise level that is equaled or exceeded for 10% of the measurement period.

L(A)₉₀

The noise level that is equaled or exceeded for 90% of the measurement period.

Noise

Unwanted sound. Any sound which has the potential to cause disturbance, discomfort or psychological stress to a subject exposed to it, or any sound which has the potential to cause actual physiological harm to a subject exposed to it or physical damage to any structure exposed to it, is known as noise.

Noise Sensitive Receptor

A noise sensitive receptor is regarded as any dwelling house, hotel or hostel, health building, educational establishment, places of worship or entertainment, or any other facility or area of high amenity which for its proper enjoyment requires the absence of noise at nuisance levels.

Rating level L_{ArTr}

The specific noise level plus any adjustment for the characteristic features of the noise.

Residual Noise

The ambient noise remaining at a given position in a given situation when the specific noise source is suppressed to a degree such that it does not contribute to the ambient noise.

Sound Power

The energy output from a source. It is measured in Watts (W).

Specific Noise source

The noise source under investigation for assessing the likelihood of complaints.

Tone

A noise with a narrow frequency composition.

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Equipment Details

Instrument Manufacturer	Cirrus Research plc
Instrument Type	Acoustic Calibrator
Model Number	CR:513A
Serial Number	032884

Calibration Procedure

The acoustic calibrator detailed above has been calibrated to the published data as described in the operating manual. The procedures and techniques used to follow the recommendations of IEC standard Electroacoustics - Sound Calibrators IEC 60942:1997 and BS EN 60942:1998. The calibrator's main output is 94.00 dB (1 Pa) and this was set within the 0.01 dB resolution of the test system, i.e. one hundredth of a decibel. Numbers in {parenthesis} refer to the paragraph in IEC 60942.

Calibration Traceability

The calibrator above was calibrated against the calibration laboratory standards held at Hunmanby UK YO14 0PH. These are traceable to UK national standards {A.0.6}. The standards are:

Microphone Type	B&K4192	Serial Number	1920791	Calibration Ref.	S 5170
Pistonphone Type	B&K4220	Serial Number	613843	Calibration Ref.	S 5169

Calibration Climatic Conditions

These climatic test conditions were all maintained within the permitted limits of IEC 60942:1997.

Temperature	{B.3.2}	Permitted band	15°C to 25°C
Humidity	{B.3.2}	Permitted band	30% to 90% RH
Static Pressure	{B.3.2}	Permitted band	85 kPa to 105 kPa
Ambient Noise Level	{B.3.3.6}	Max permitted level	64 dB(Z)

Measurement Results

The figures below are the Calibration Laboratory test limits for this model calibrator and have a smaller tolerance than those permitted in IEC 60942.

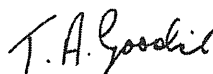
94 dB Output	93.96	dB	Permitted band	93.95 to 94.05 dB
104 dB Output	103.92	dB	Permitted band	103.80 to 104.30 dB
Frequency	1006.0	Hz	Permitted band	990 Hz to 1010 Hz

Uncertainty

With an uncertainty coefficient $k=2$, i.e. a 95% confidence level, the uncertainty of each measurement is:

94 dB Output	± 0.13 dB	104 dB Output	± 0.14 dB
Frequency	± 0.1 Hz	Level Stability	± 0.04 dB

Calibrated By



Calibration Date

30 November 2005

Calibration Certificate Number

135377

This Calibration Certificate is valid for 12 months from the date above.

Acoustic House Bridlington Road Hunmanby North Yorkshire YO14 0PH
Telephone 01723 891655 Fax 01723 891742

Equipment Details

Instrument Manufacturer	Cirrus Research plc
Instrument Type	Sound Level Meter
Model Number	CR:831A
Serial Number	B16438FF

Calibration Procedure

The instrument detailed above has been calibrated to the published test and calibration data as detailed in the instrument handbook, using the techniques recommended in the latest revisions of the International Standards IEC 61672-1:2002, IEC 60651:1979, IEC 60804:2001, IEC 61260:1995, IEC 60942:1997, IEC 61252:1993, ANSI S1.4-1983 and ANSI S1.43-1997 where applicable.

Sound Level Meters: All Calibration procedures were carried out by substituting the microphone capsule with a suitable electrical signal, apart from the final acoustic calibration.


Calibration Traceability

The equipment detailed above was calibrated against the calibration laboratory standards held by Cirrus Research plc. which are traceable to the appropriate National Standards.

The Cirrus Research plc calibration laboratory standards are:

Microphone Type	B&K4192	Serial Number	1920791	Calibration Ref.	S 5170
Pistonphone Type	B&K4220	Serial Number	613843	Calibration Ref.	S 5169

Calibrated By



Calibration Date

30 November 2005

Calibration Certificate Number

135376

This Calibration Certificate is valid for 12 months from the date above.

APPENDIX 2.3.2

Noise Graphs

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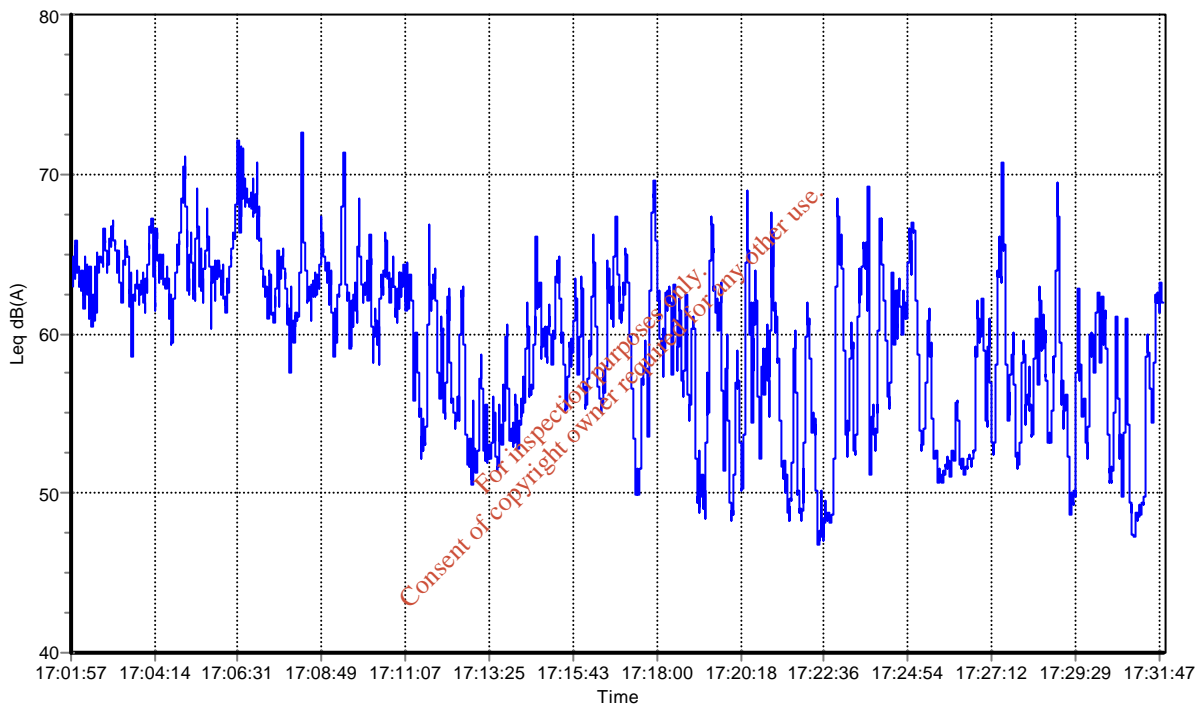
Noise Measurement Report

Date: 14/07/05 Time: 17:01:57

Run Time: 00:30:00
Range: 40-100 dB

Leq 62.1 dBA
Lepd 50.1 dBA
LAE 94.5 dBA
LAFmax 77.6 dBA
Peak 101.2 dBC

L1.0	L10.0	L50.0	L90.0	L95.0	L99.0
69.8 dBA	65.5 dBA	60.2 dBA	51.5 dBA	49.7 dBA	47.8 dBA



Notes: Location N1 - Broadband Measurement


Printed: 11/01/06 14:53:14

Noise Measurement Report

Date: 14/07/05 Time: 17:36:02

Run Time: 00:04:48
 Range: 40-100 dB
 Spectrum 'A' weighted

Measurement	25 Hz	31 Hz	40 Hz	50 Hz	63 Hz	80 Hz	100 Hz	125 Hz	160 Hz	200 Hz	250 Hz
Level (dB)	6.8	12.4	18.0	18.2	38.6	35.6	41.5	42.4	42.8	44.0	60.2
Duration (s)	9	9	9	9	9	9	9	9	9	9	9
Measurement	315 Hz	400 Hz	500 Hz	630 Hz	800 Hz	1 kHz	1.25 kHz	1.6 kHz	2 kHz	2.5 kHz	3.15 kHz
Level (dB)	48.8	36.1	55.3	52.2	54.2	59.9	60.5	54.5	49.7	55.4	47.3
Duration (s)	9	9	9	9	9	9	9	9	9	9	9
Measurement	4 kHz	5 kHz	6.3 kHz	8 kHz	10 kHz	12.5 kHz	16 kHz	LAeq	LCEq	LZeq	
Level (dB)	46.6	30.7	37.5	35.6	24.2	22.3	18.5	68.5	71.8	65.3	
Duration (s)	9	9	9	9	9	9	9	9	9	9	

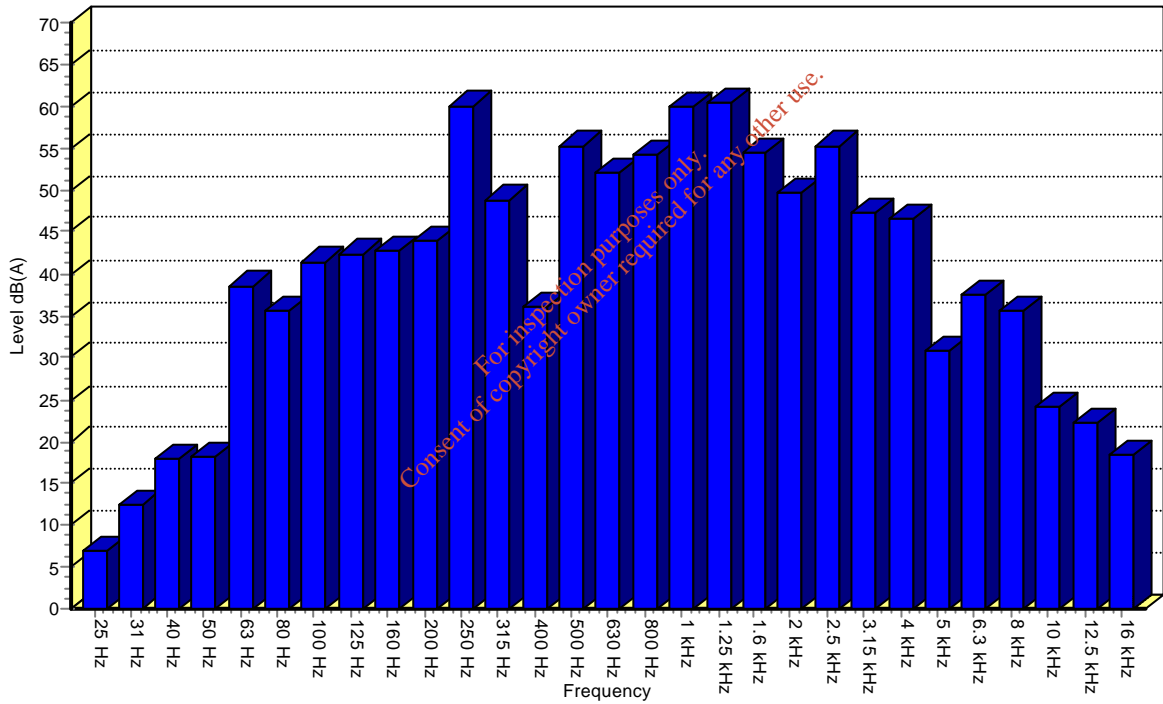

Notes: Locatgion N1 - 1/3 Octave Frequency Analysis

Printed: 11/01/06 14:54:08


Noise Measurement Report

Date: 14/07/05 Time: 15:32:40

Run Time: 00:30:00
Range: 40-100 dB

Leq 54.0 dBA
Lepd 41.9 dBA
LAE 86.3 dBA
LAFmax 77.3 dBA
Peak 102.0 dBC

L1.0	L10.0	L50.0	L90.0	L95.0	L99.0
59.3 dBA	56.0 dBA	53.1 dBA	49.9 dBA	49.2 dBA	48.2 dBA

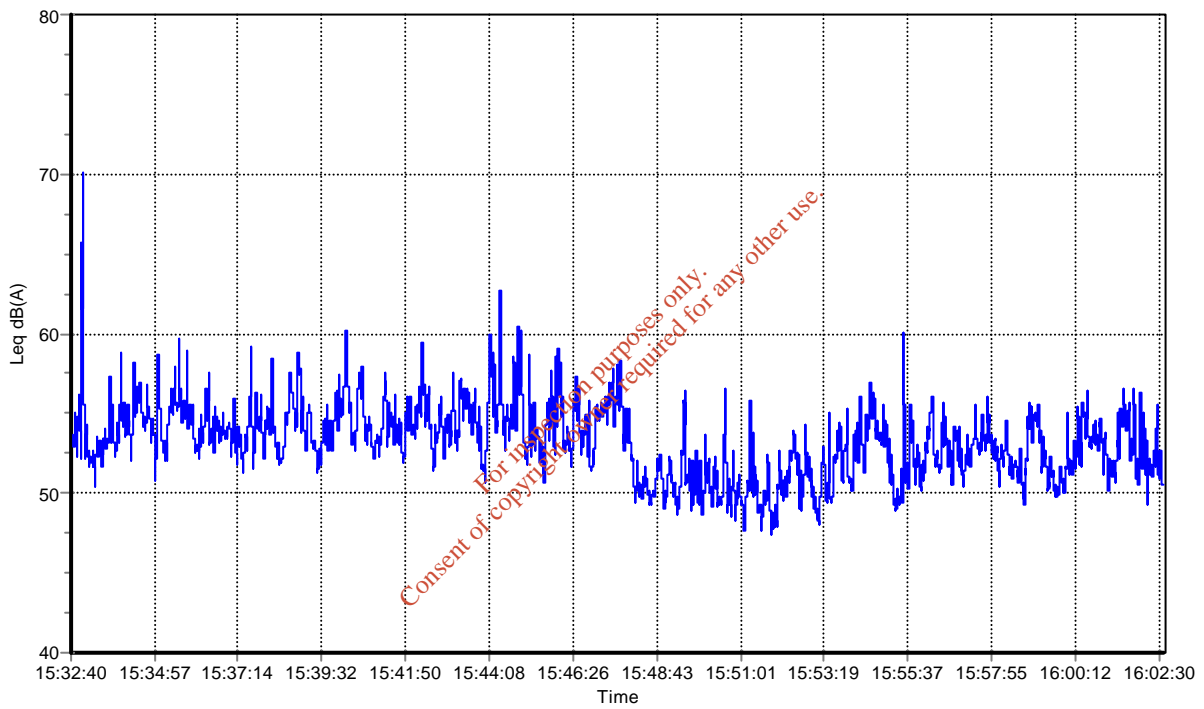

Notes: Location N2 - Broadband Measurement

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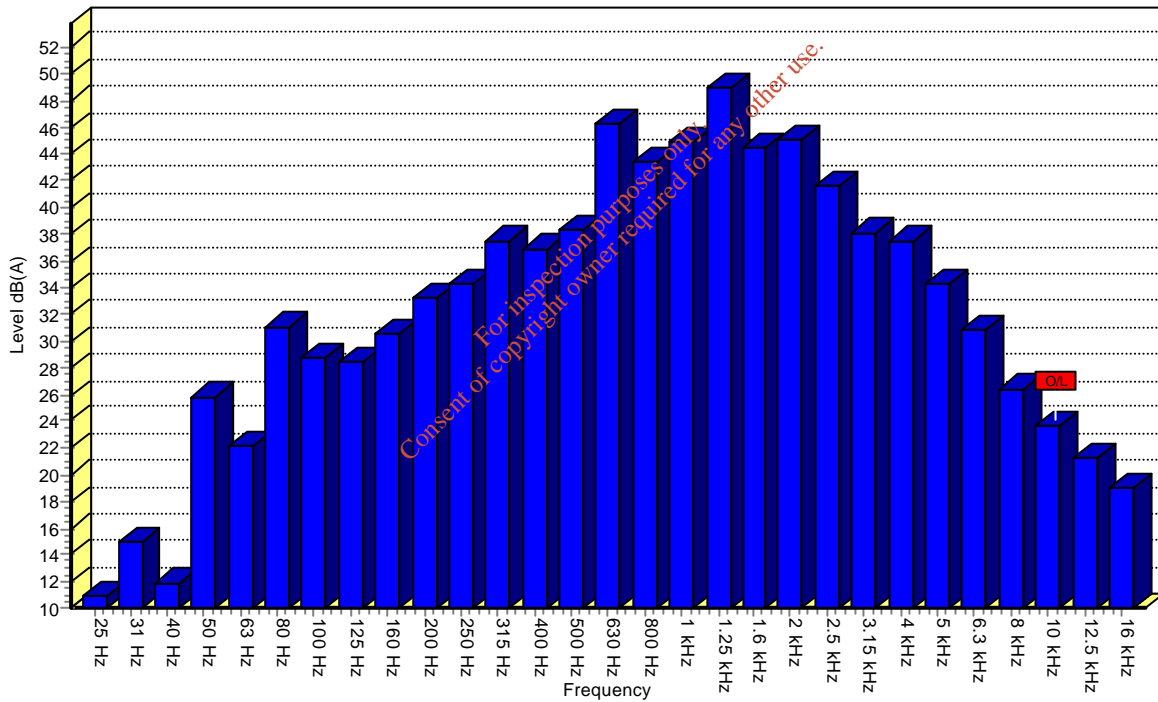
Noise Measurement Report

Date: 14/07/05 Time: 16:04:07

Run Time: 00:04:48
 Range: 40-100 dB
 Spectrum 'A' weighted

Measurement	25 Hz	31 Hz	40 Hz	50 Hz	63 Hz	80 Hz	100 Hz	125 Hz	160 Hz	200 Hz	250 Hz
Level (dB)	10.9	14.9	12.0	25.8	22.2	31.1	28.8	28.4	30.6	33.2	34.2
Duration (s)	9	9	9	9	9	9	9	9	9	9	9
Measurement	315 Hz	400 Hz	500 Hz	630 Hz	800 Hz	1 kHz	1.25 kHz	1.6 kHz	2 kHz	2.5 kHz	3.15 kHz
Level (dB)	37.5	36.9	38.3	46.3	43.4	44.9	49.0	44.4	45.0	41.7	38.2
Duration (s)	9	9	9	9	9	9	9	9	9	9	9
Measurement	4 kHz	5 kHz	6.3 kHz	8 kHz	10 kHz	12.5 kHz	16 kHz	LAeq	LCeq	LZeq	
Level (dB)	37.5	34.3	30.8	26.5	23.7 [^]	21.3	19.0	50.8	63.7	77.0	
Duration (s)	9	9	9	9	9	9	9	9	9	9	

[^] indicates overload



Notes: Location N2 - 1/3 Octave Frequency Analysis

Printed: 11/01/06 15:23:23


Noise Measurement Report

Date: 14/07/05 Time: 18:59:05

Run Time: 00:30:00
Range: 40-100 dB

Leq 53.1 dBA
Lepd 41.1 dBA
LAE 85.5 dBA
LAFmax 72.5 dBA
Peak 84.8 dBC

L1.0	L10.0	L50.0	L90.0	L95.0	L99.0
150.0 dBA	58.0 dBA	50.6 dBA	46.5 dBA	45.4 dBA	43.7 dBA

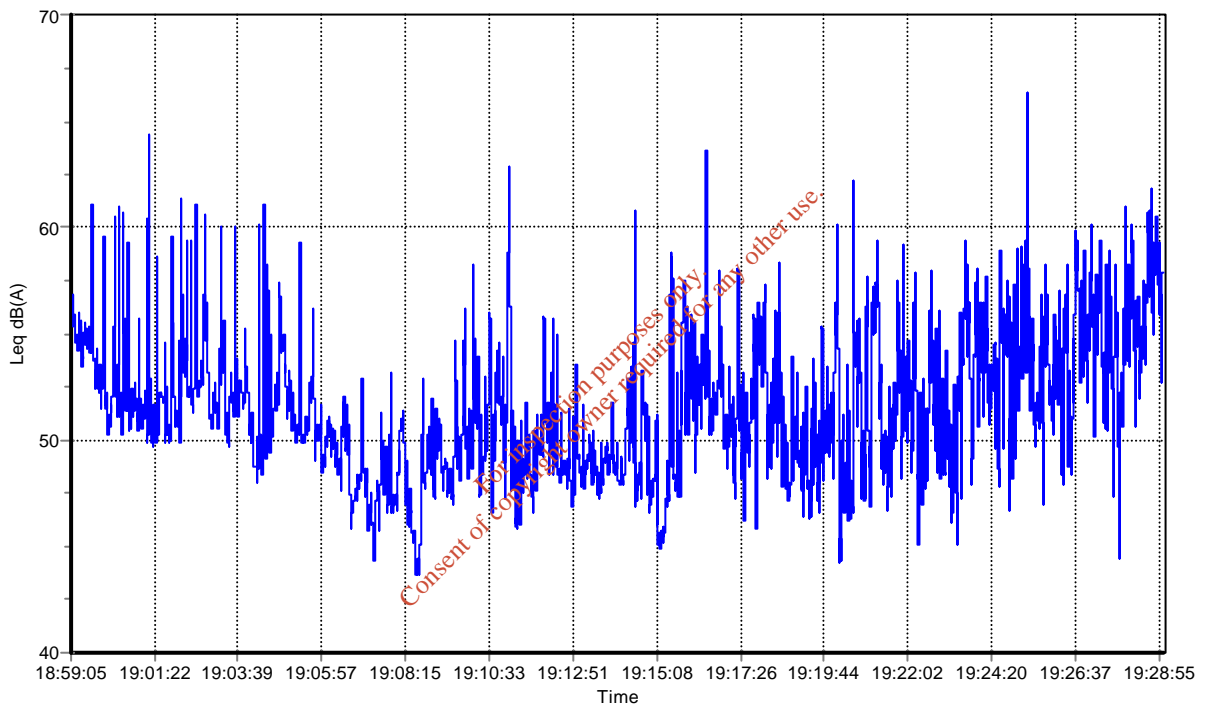

Notes: Location N3 - Broadband Measurement


Printed: 11/01/06 15:10:45

Noise Measurement Report

Date: 14/07/05 Time: 19:37:28

Run Time: 00:04:48
 Range: 40-100 dB
 Spectrum 'A' weighted

Measurement	25 Hz	31 Hz	40 Hz	50 Hz	63 Hz	80 Hz	100 Hz	125 Hz	160 Hz	200 Hz	250 Hz
Level (dB)	11.7	17.7	18.1	24.3	31.4	36.1	40.0	38.9	44.3	47.9	52.9
Duration (s)	9	9	9	9	9	9	9	9	9	9	9
Measurement	315 Hz	400 Hz	500 Hz	630 Hz	800 Hz	1 kHz	1.25 kHz	1.6 kHz	2 kHz	2.5 kHz	3.15 kHz
Level (dB)	49.4	54.9	58.4	56.7	64.0	61.9	56.8	54.5	52.5	50.2	44.0
Duration (s)	9	9	9	9	9	9	9	9	9	9	9
Measurement	4 kHz	5 kHz	6.3 kHz	8 kHz	10 kHz	12.5 kHz	16 kHz	LAeq	LCeq	LZeq	
Level (dB)	41.6	38.8	33.8	31.1	26.6	21.6	19.6	67.7	71.0	76.8	
Duration (s)	9	9	9	9	9	9	9	9	9	9	

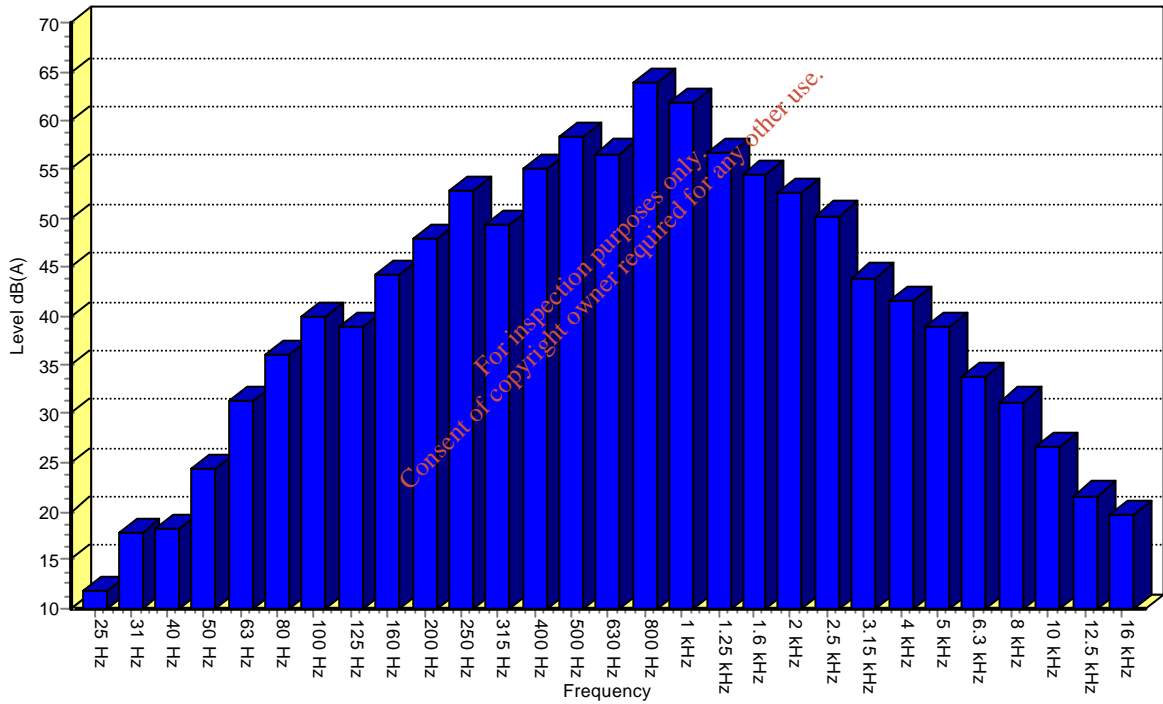

Notes: Location N3 - 1/3 Octave Frequency Analysis

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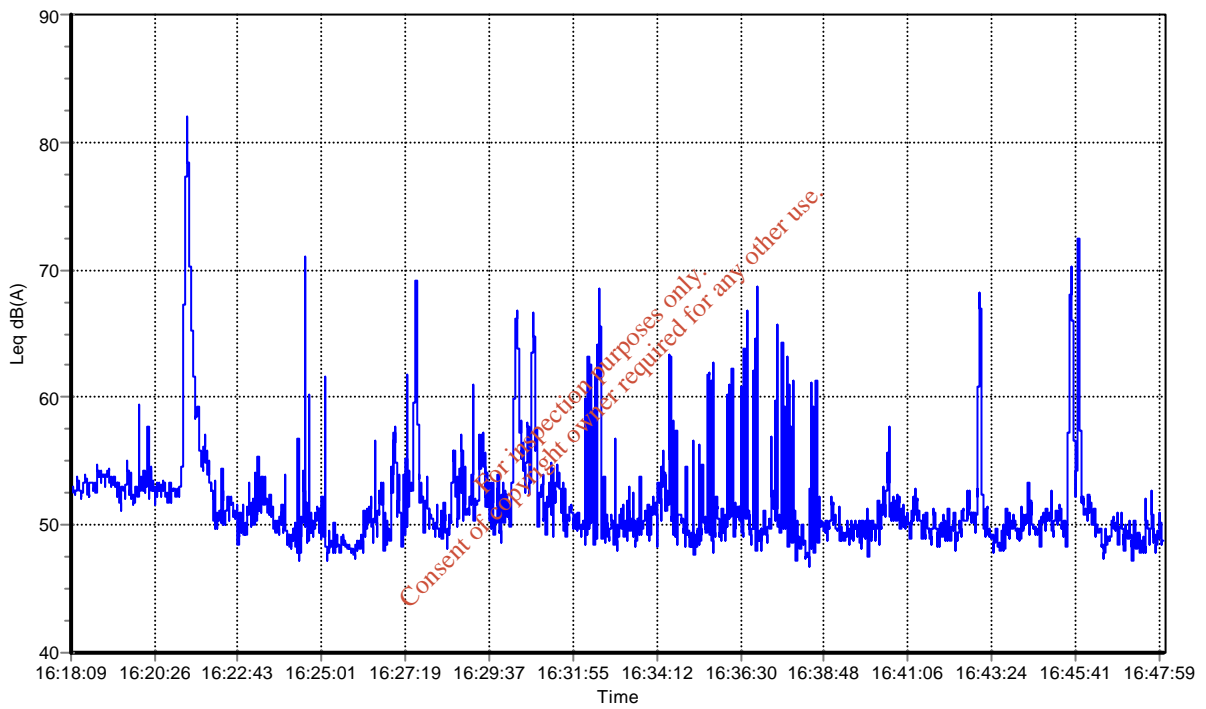
Noise Measurement Report

Date: 14/07/05 Time: 16:18:09

Run Time: 00:30:00
Range: 40-100 dB

Leq 58.1 dBA
Lepd 46.1 dBA
LAE 90.5 dBA
LAFmax 82.8 dBA
Peak 97.1 dBC

L1.0 L10.0 L50.0 L90.0 L95.0 L99.0
150.0 dBA 150.0 dBA 50.9 dBA 48.5 dBA 47.9 dBA 47.0 dBA



Notes: Location N4 - Broadband Measurement

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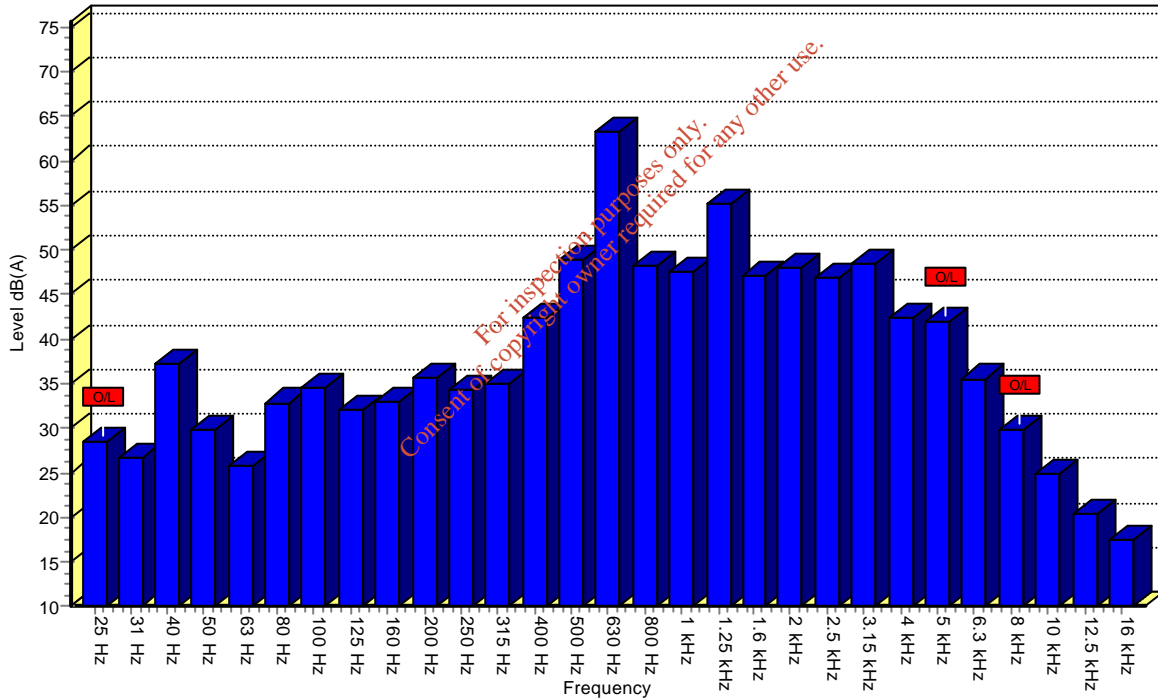
Noise Measurement Report

Date: 14/07/05 Time: 16:56:47

Run Time: 00:04:48
 Range: 40-100 dB
 Spectrum 'A' weighted

Measurement	25 Hz	31 Hz	40 Hz	50 Hz	63 Hz	80 Hz	100 Hz	125 Hz	160 Hz	200 Hz	250 Hz
Level (dB)	28.4^	26.6	37.1	29.8	25.8	32.9	34.5	32.1	33.1	35.7	34.3
Duration (s)	9	9	9	9	9	9	9	9	9	9	9
Measurement	315 Hz	400 Hz	500 Hz	630 Hz	800 Hz	1 kHz	1.25 kHz	1.6 kHz	2 kHz	2.5 kHz	3.15 kHz
Level (dB)	35.0	42.3	48.9	63.1	48.2	47.5	55.2	47.2	48.1	47.0	48.4
Duration (s)	9	9	9	9	9	9	9	9	9	9	9
Measurement	4 kHz	5 kHz	6.3 kHz	8 kHz	10 kHz	12.5 kHz	16 kHz	LAeq	LCeq	LZeq	
Level (dB)	42.3	42.1^	35.5	29.9^	24.8	20.4	17.6	67.1	72.3	80.8	
Duration (s)	9	9	9	9	9	9	9	9	9	9	

^ indicates overload



Notes: Location N4 - 1/3 Octave Frequency Analysis

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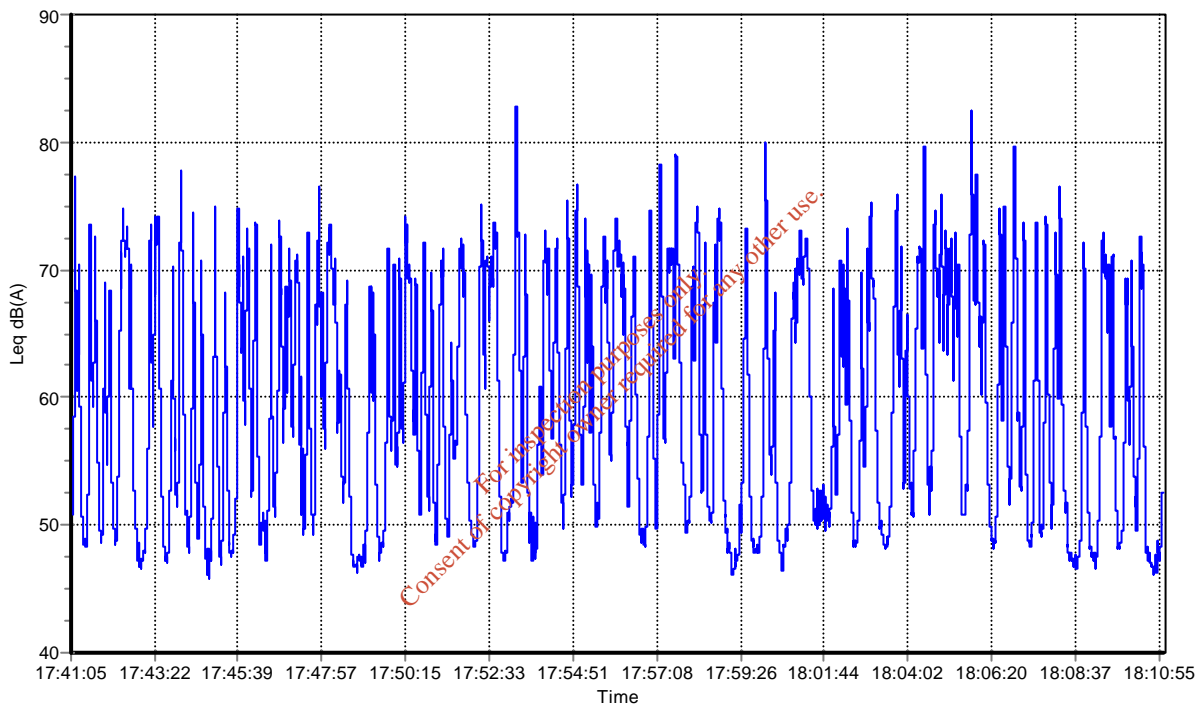
Noise Measurement Report

Date: 14/07/05 Time: 17:41:05

Run Time: 00:30:00
Range: 40-100 dB

Leq 67.0 dBA
Lepd 55.0 dBA
LAE 99.3 dBA
LAFmax 85.9 dBA
Peak 106.1 dBC

L1.0	L10.0	L50.0	L90.0	L95.0	L99.0
150.0 dBA	72.8 dBA	57.7 dBA	48.0 dBA	47.1 dBA	46.0 dBA



Notes: NSL 1 - Daytime Broadband Measurement


Printed: 31/08/05 14:00:01

Noise Measurement Report

Date: 14/07/05 Time: 18:15:47

Run Time: 00:04:48
 Range: 40-100 dB
 Spectrum 'A' weighted

Measurement	25 Hz	31 Hz	40 Hz	50 Hz	63 Hz	80 Hz	100 Hz	125 Hz	160 Hz	200 Hz	250 Hz
Level (dB)	8.8	24.6	25.5	22.7	25.2	26.9	38.1	31.7	29.8	29.9	29.5
Duration (s)	9	9	9	9	9	9	9	9	9	9	9
Measurement	315 Hz	400 Hz	500 Hz	630 Hz	800 Hz	1 kHz	1.25 kHz	1.6 kHz	2 kHz	2.5 kHz	3.15 kHz
Level (dB)	29.6	29.7	30.9	46.9	38.0	39.5	40.2	35.9	32.5	29.2	30.1
Duration (s)	9	9	9	9	9	9	9	9	9	9	9
Measurement	4 kHz	5 kHz	6.3 kHz	8 kHz	10 kHz	12.5 kHz	16 kHz	LAeq	LCEq	LZeq	
Level (dB)	35.2	25.5	23.9	22.9	20.2	19.7	17.6	47.5	63.3	76.3	
Duration (s)	9	9	9	9	9	9	9	9	9	9	

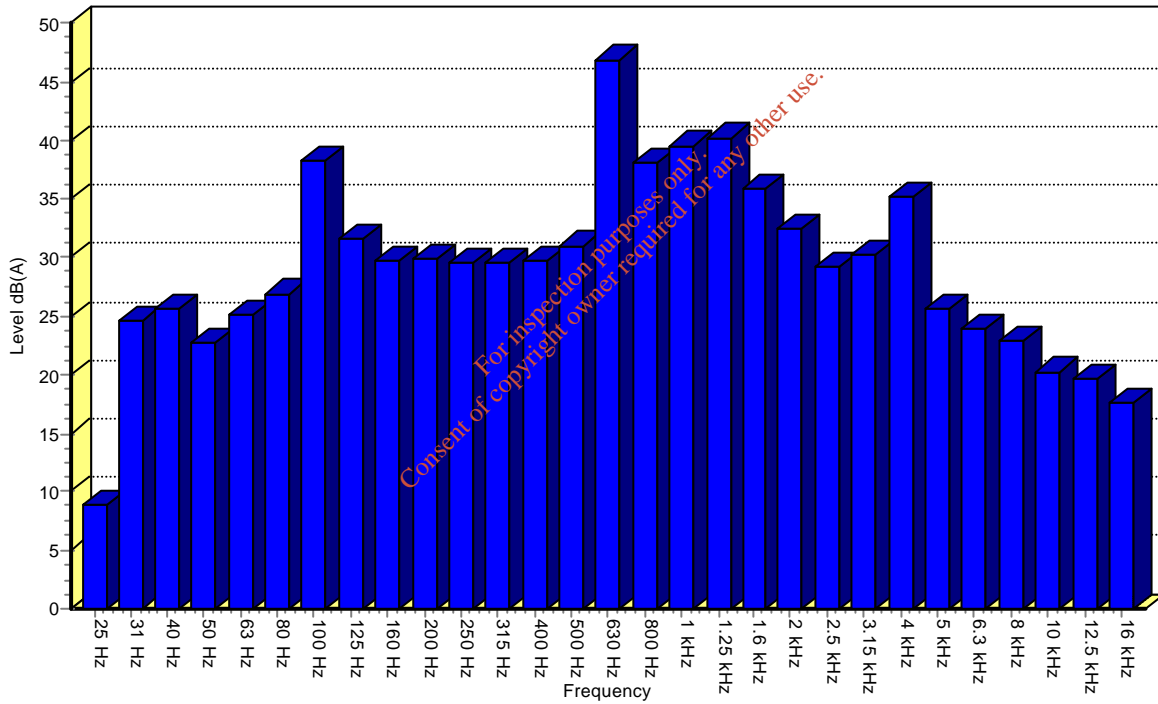

Notes: NSL 1 - Daytime 1/3 Octave Frequency Analysis Measurement

Printed: 31/08/05 14:01:18


Noise Measurement Report

Date: 15/07/05 Time: 07:05:36

Run Time: 00:15:00
Range: 40-100 dB

Leq 64.3 dBA
Lepd 49.2 dBA
LAE 93.6 dBA
LAFmax 80.7 dBA
Peak 99.7 dBC

L1.0	L10.0	L50.0	L90.0	L95.0	L99.0
150.0 dBA	70.3 dBA	56.0 dBA	47.3 dBA	46.1 dBA	45.1 dBA

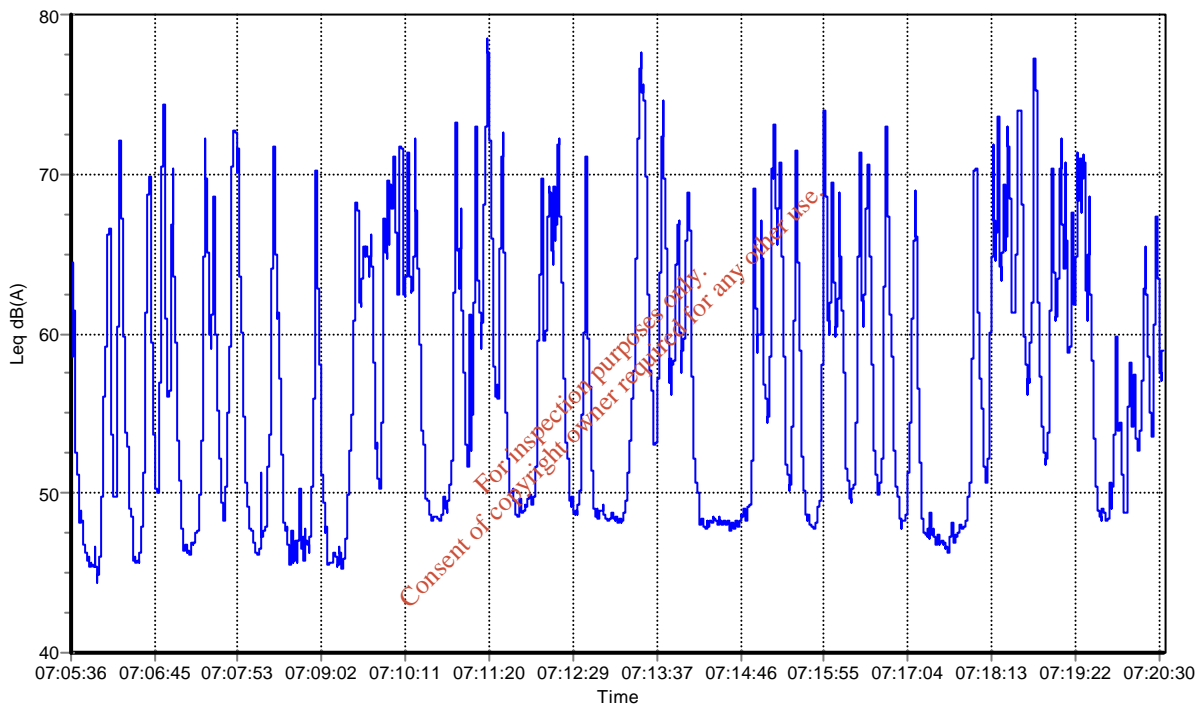

Notes: Location N1 - Night time Broadband Measurement


Printed: 11/01/06 16:57:47

Noise Measurement Report

Date: 15/07/05 Time: 07:20:52

Run Time: 00:02:40
 Range: 40-100 dB
 Spectrum 'A' weighted

Measurement	25 Hz	31 Hz	40 Hz	50 Hz	63 Hz	80 Hz	100 Hz	125 Hz	160 Hz	200 Hz	250 Hz
Level (dB)	11.4	15.2	21.5	29.4	55.1	45.2	37.4	30.4	44.6	33.3	33.7
Duration (s)	5	5	5	5	5	5	5	5	5	5	5
Measurement	315 Hz	400 Hz	500 Hz	630 Hz	800 Hz	1 kHz	1.25 kHz	1.6 kHz	2 kHz	2.5 kHz	3.15 kHz
Level (dB)	44.7	33.0	48.3	54.1	62.9	62.6	62.5	56.2	43.2	31.8	28.3
Duration (s)	5	5	5	5	5	5	5	5	5	5	5
Measurement	4 kHz	5 kHz	6.3 kHz	8 kHz	10 kHz	12.5 kHz	16 kHz	LAeq	LCeq	LZeq	
Level (dB)	42.1	32.3	31.8	30.6	18.3	21.2	18.9	46.1	63.0	64.7	
Duration (s)	5	5	5	5	5	5	5	5	5	5	

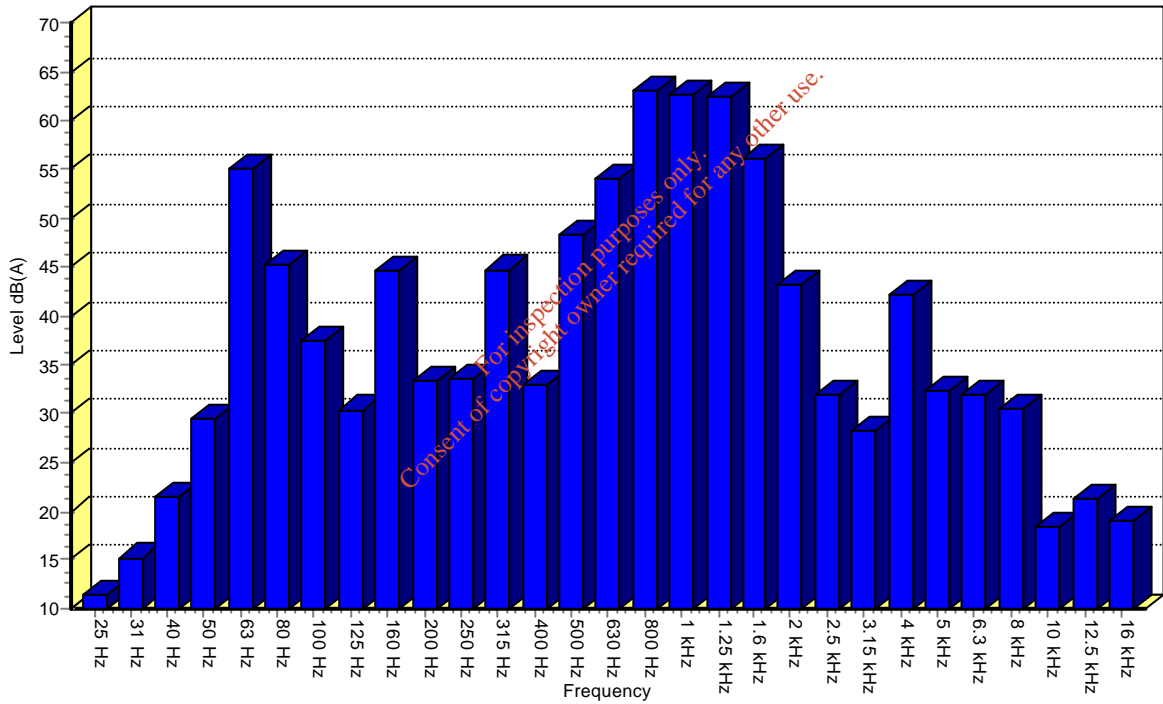

Notes: Location N1 - Night time 1/3 Octave Frequency Analysis

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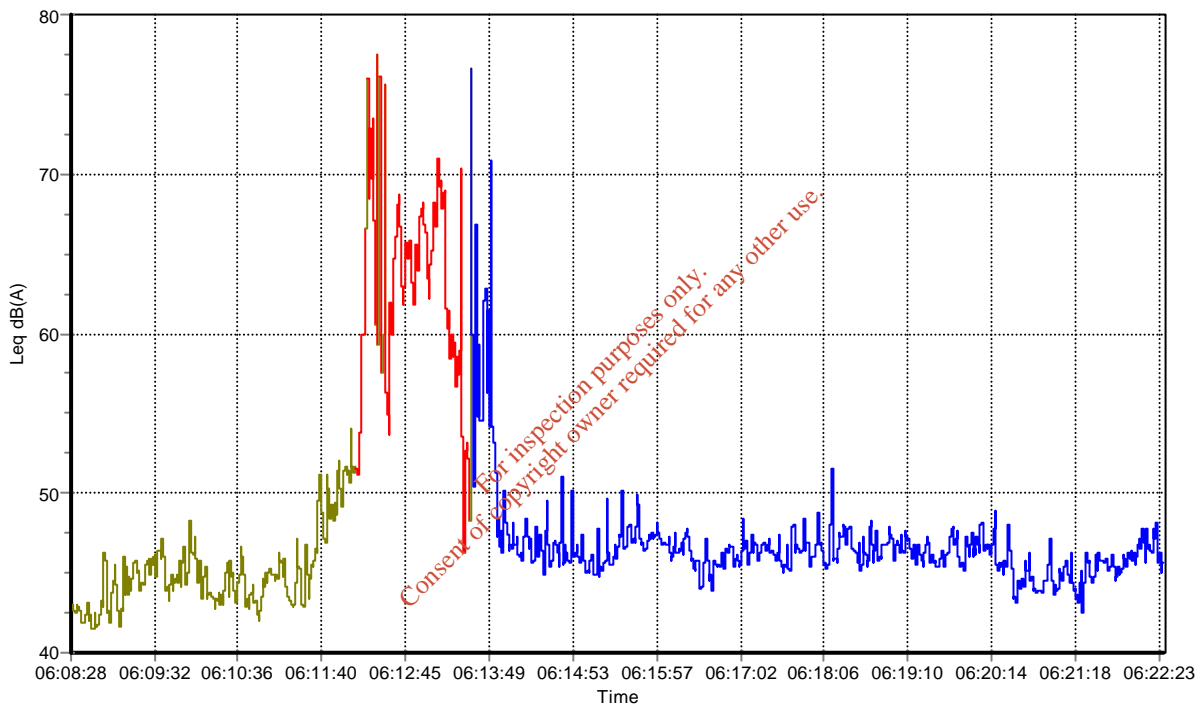
Noise Measurement Report

Date: 15/07/05 Time: 06:08:28

Run Time: 00:12:02
Range: 40-100 dB

Leq 46.3 dBA
Lepd 30.3 dBA
LAE 74.7 dBA
LAFmax 58.6 dBA
Peak 84.8 dBC

L1.0	L10.0	L50.0	L90.0	L95.0	L99.0
150.0 dBA	150.0 dBA	45.8 dBA	43.1 dBA	42.4 dBA	41.4 dBA



Notes: Location N2 - Night time Broadband Measurement


Printed: 11/01/06 15:58:54

Noise Measurement Report

Date: 15/07/05 Time: 06:23:14

Run Time: 00:02:40
 Range: 40-100 dB
 Spectrum 'A' weighted

Measurement	25 Hz	31 Hz	40 Hz	50 Hz	63 Hz	80 Hz	100 Hz	125 Hz	160 Hz	200 Hz	250 Hz
Level (dB)	8.7	11.1	17.6	22.2	22.0	27.0	34.7	28.5	36.1	27.6	31.3
Duration (s)	5	5	5	5	5	5	5	5	5	5	5
Measurement	315 Hz	400 Hz	500 Hz	630 Hz	800 Hz	1 kHz	1.25 kHz	1.6 kHz	2 kHz	2.5 kHz	3.15 kHz
Level (dB)	46.2	43.7	38.6	44.3	47.9	55.1	43.9	50.9	40.2	37.8	51.1
Duration (s)	5	5	5	5	5	5	5	5	5	5	5
Measurement	4 kHz	5 kHz	6.3 kHz	8 kHz	10 kHz	12.5 kHz	16 kHz	LAeq	LCeq	LZeq	
Level (dB)	33.4	26.3	23.0	23.9	21.0	19.3	18.0	53.8	70.8	70.9	
Duration (s)	5	5	5	5	5	5	5	5	5	5	

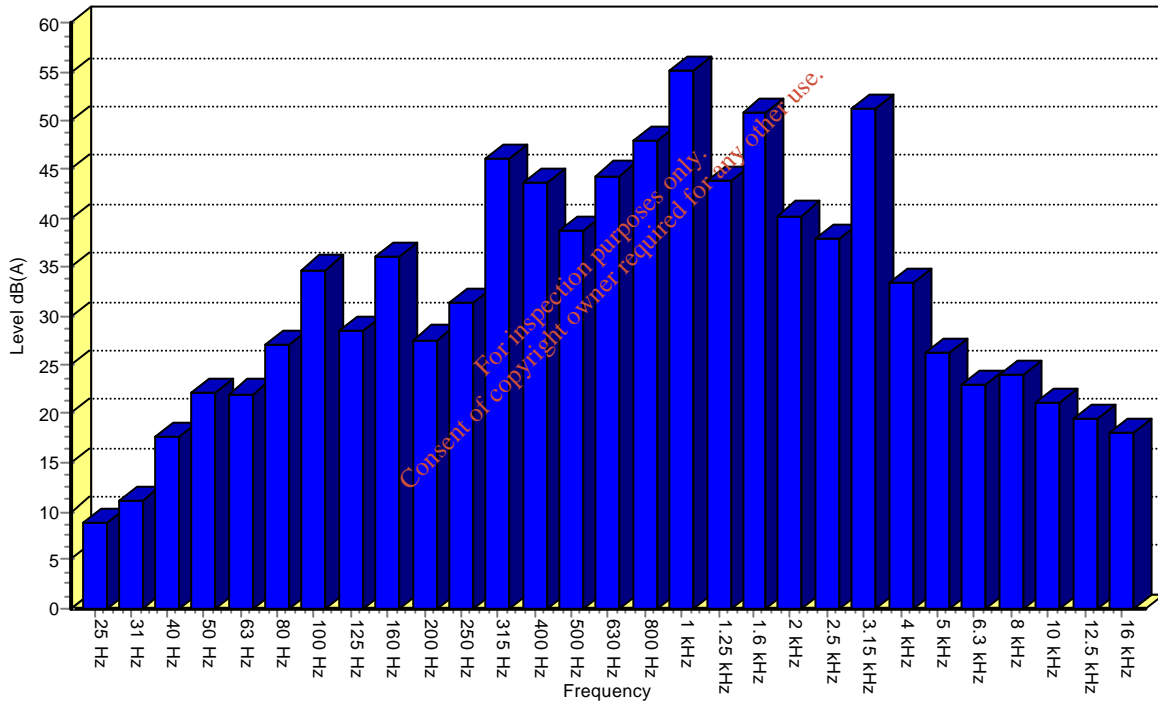

Notes: Location N2 - 1/3 Octave Frequency Analysis

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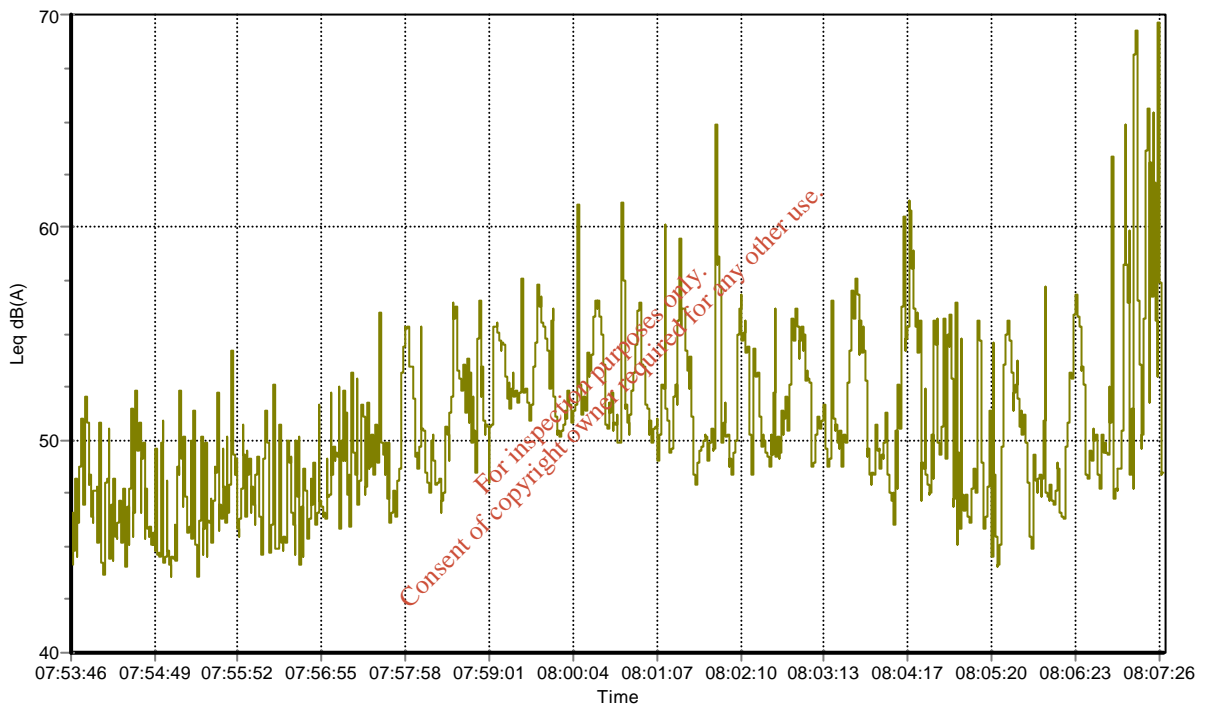
Noise Measurement Report

Date: 15/07/05 Time: 07:53:46

Run Time: 00:13:11
Range: 40-100 dB

Leq 52.0 dBA
Lepd 36.4 dBA
LAE 80.8 dBA
LAFmax 70.0 dBA
Peak 85.7 dBC

L1.0	L10.0	L50.0	L90.0	L95.0	L99.0
150.0 dBA	73.8 dBA	50.1 dBA	45.1 dBA	44.2 dBA	43.1 dBA



Notes: Location N3 - Night time BVroadband Measurement


Printed: 11/01/06 16:45:05

Noise Measurement Report

Date: 15/07/05 Time: 07:26:22

Run Time: 00:02:40
 Range: 40-100 dB
 Spectrum 'A' weighted

Measurement	25 Hz	31 Hz	40 Hz	50 Hz	63 Hz	80 Hz	100 Hz	125 Hz	160 Hz	200 Hz	250 Hz
Level (dB)	26.1	24.2	21.8	23.5	25.6	28.8	36.3	31.3	31.0	29.9	30.0
Duration (s)	5	5	5	5	5	5	5	5	5	5	5
Measurement	315 Hz	400 Hz	500 Hz	630 Hz	800 Hz	1 kHz	1.25 kHz	1.6 kHz	2 kHz	2.5 kHz	3.15 kHz
Level (dB)	31.1	36.5	31.7	33.3	33.5	38.5	37.9	36.3	33.5	30.0	31.7
Duration (s)	5	5	5	5	5	5	5	5	5	5	5
Measurement	4 kHz	5 kHz	6.3 kHz	8 kHz	10 kHz	12.5 kHz	16 kHz	LAeq	LCeq	LZeq	
Level (dB)	38.0	23.6	22.3	20.9	18.3	20.1	18.0	45.6	66.3	67.0	
Duration (s)	5	5	5	5	5	5	5	5	5	5	

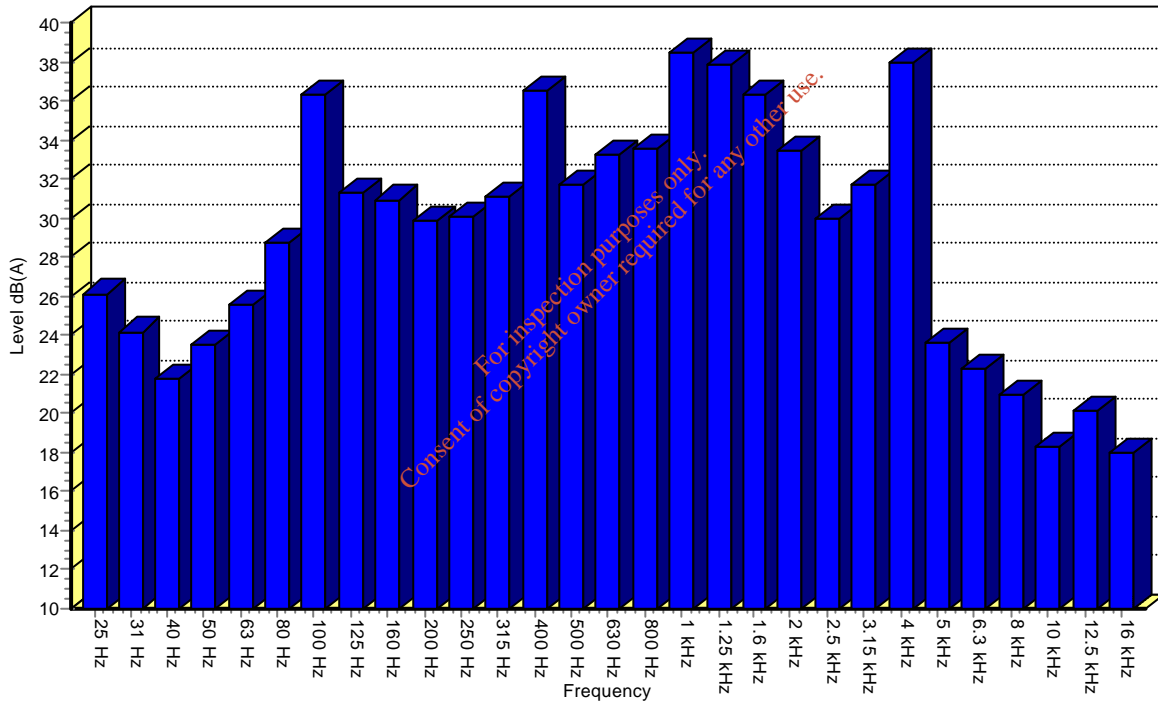

Notes: Location N3 - Night time 1/3 Octave Frequency Analysis

Printed: 11/01/06 16:47:29


Noise Measurement Report

Date: 15/07/05 Time: 06:23:20

Run Time: 00:13:11
Range: 40-100 dB

Leq 48.3 dBA
Lepd 32.7 dBA
LAE 77.1 dBA
LAFmax 68.4 dBA
Peak 87.1 dBC

L1.0	L10.0	L50.0	L90.0	L95.0	L99.0
55.3 dBA	47.8 dBA	46.1 dBA	43.4 dBA	43.1 dBA	42.6 dBA

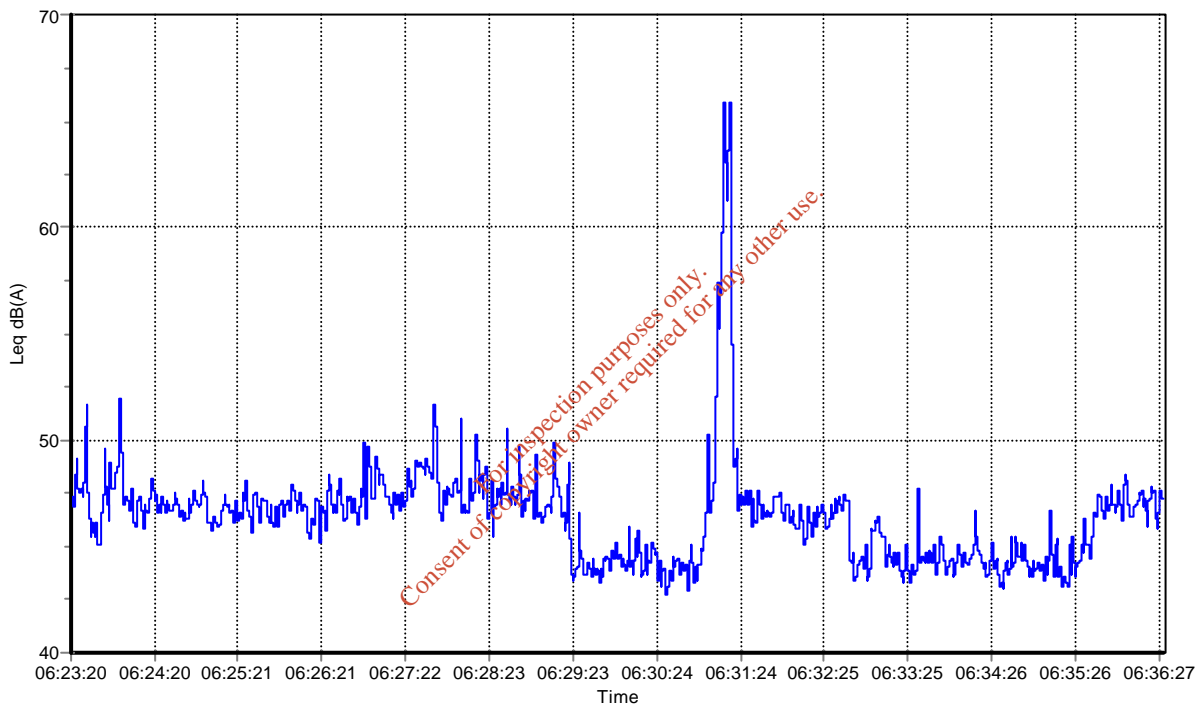

Notes: Location N4 - Night time Broadband Measurement


Printed: 11/01/06 16:02:04

Noise Measurement Report

Date: 15/07/05 Time: 06:05:16

Run Time: 00:02:40
 Range: 40-100 dB
 Spectrum 'A' weighted

Measurement	25 Hz	31 Hz	40 Hz	50 Hz	63 Hz	80 Hz	100 Hz	125 Hz	160 Hz	200 Hz	250 Hz
Level (dB)	10.9	9.4	6.7	14.0	18.7	23.0	25.5	25.0	23.4	27.3	26.0
Duration (s)	5	5	5	5	5	5	5	5	5	5	5
Measurement	315 Hz	400 Hz	500 Hz	630 Hz	800 Hz	1 kHz	1.25 kHz	1.6 kHz	2 kHz	2.5 kHz	3.15 kHz
Level (dB)	26.0	28.1	31.1	35.3	33.8	37.0	34.5	36.2	38.0	30.2	27.6
Duration (s)	5	5	5	5	5	5	5	5	5	5	5
Measurement	4 kHz	5 kHz	6.3 kHz	8 kHz	10 kHz	12.5 kHz	16 kHz	LAeq	LCeq	LZeq	
Level (dB)	26.8	25.8	22.3	22.1	19.4	20.6	18.5	44.4	62.7	73.9	
Duration (s)	5	5	5	5	5	5	5	5	5	5	

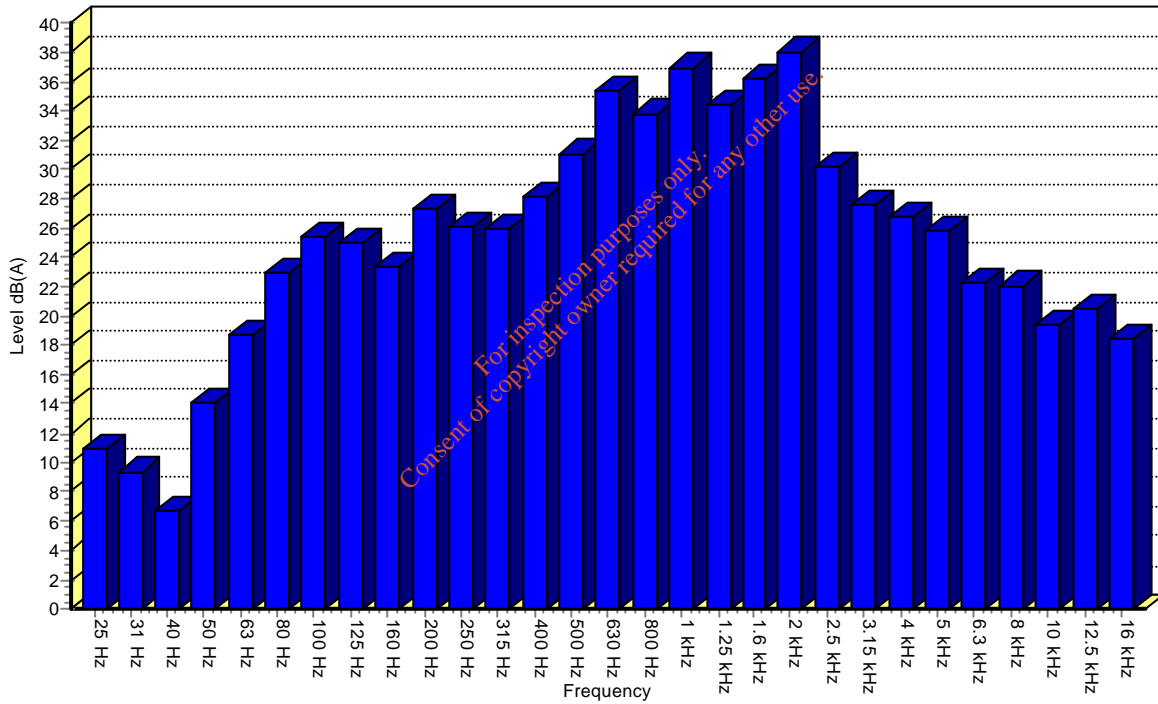

Notes: Location N4 - Night time 1/3 Octave Frequency Analysis

Printed: 11/01/06 17:05:29


Noise Measurement Report

Date: 15/07/05 Time: 06:26:15

Run Time: 00:15:00
Range: 40-100 dB

Leq 57.3 dBA
Lepd 42.2 dBA
LAE 86.7 dBA
LAFmax 75.5 dBA
Peak 98.0 dBC

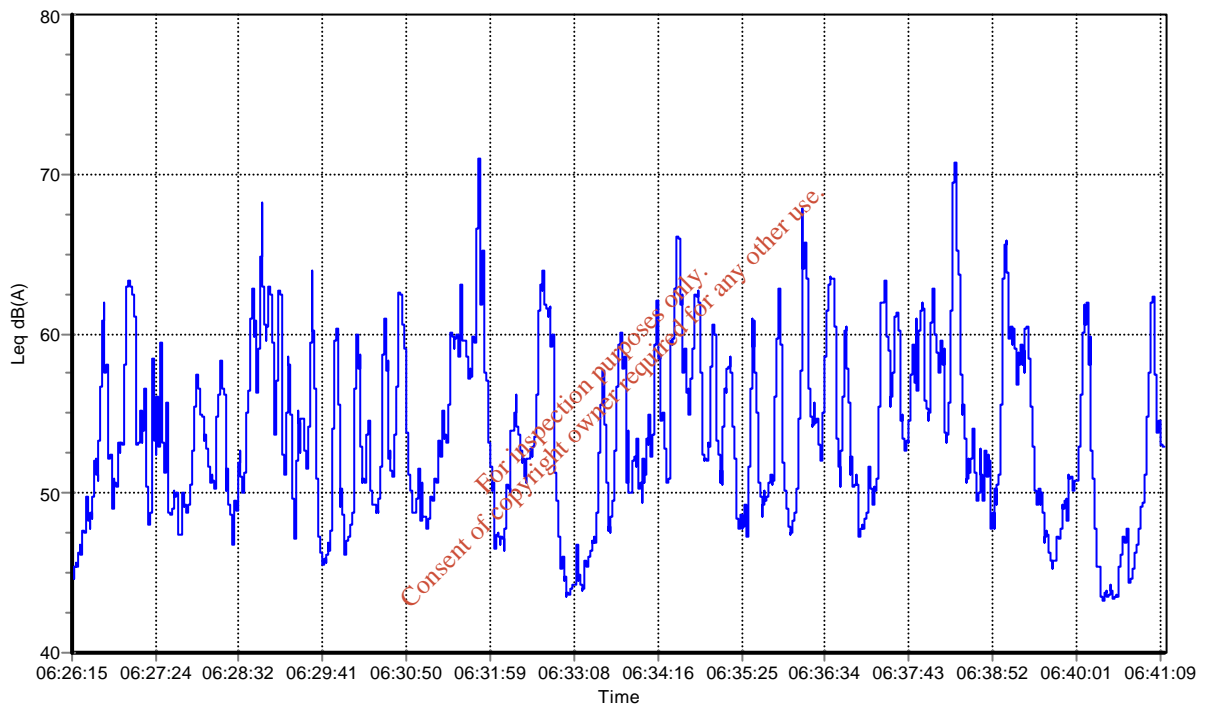L1.0 L10.0 L50.0 L90.0 L95.0 L99.0
150.0 dBA 150.0 dBA 53.5 dBA 46.2 dBA 44.7 dBA 42.9 dBA



Notes: NSL 1 - Night time Broadband Measurement


Printed: 31/08/05 14:02:07

Noise Measurement Report

Date: 15/07/05 Time: 06:37:03

Run Time: 00:02:40
 Range: 40-100 dB
 Spectrum 'A' weighted

Measurement	25 Hz	31 Hz	40 Hz	50 Hz	63 Hz	80 Hz	100 Hz	125 Hz	160 Hz	200 Hz	250 Hz
Level (dB)	9.8	16.8	15.5	24.9	26.7	23.5	27.5	29.0	28.4	28.5	31.6
Duration (s)	5	5	5	5	5	5	5	5	5	5	5
Measurement	315 Hz	400 Hz	500 Hz	630 Hz	800 Hz	1 kHz	1.25 kHz	1.6 kHz	2 kHz	2.5 kHz	3.15 kHz
Level (dB)	33.8	36.9	38.1	38.8	35.6	35.3	37.6	38.4	32.4	31.9	33.7
Duration (s)	5	5	5	5	5	5	5	5	5	5	5
Measurement	4 kHz	5 kHz	6.3 kHz	8 kHz	10 kHz	12.5 kHz	16 kHz	LAeq	LCeq	LZeq	
Level (dB)	30.9	29.8	28.0	20.4	17.6	20.8	17.8	47.7	63.3	65.3	
Duration (s)	5	5	5	5	5	5	5	5	5	5	

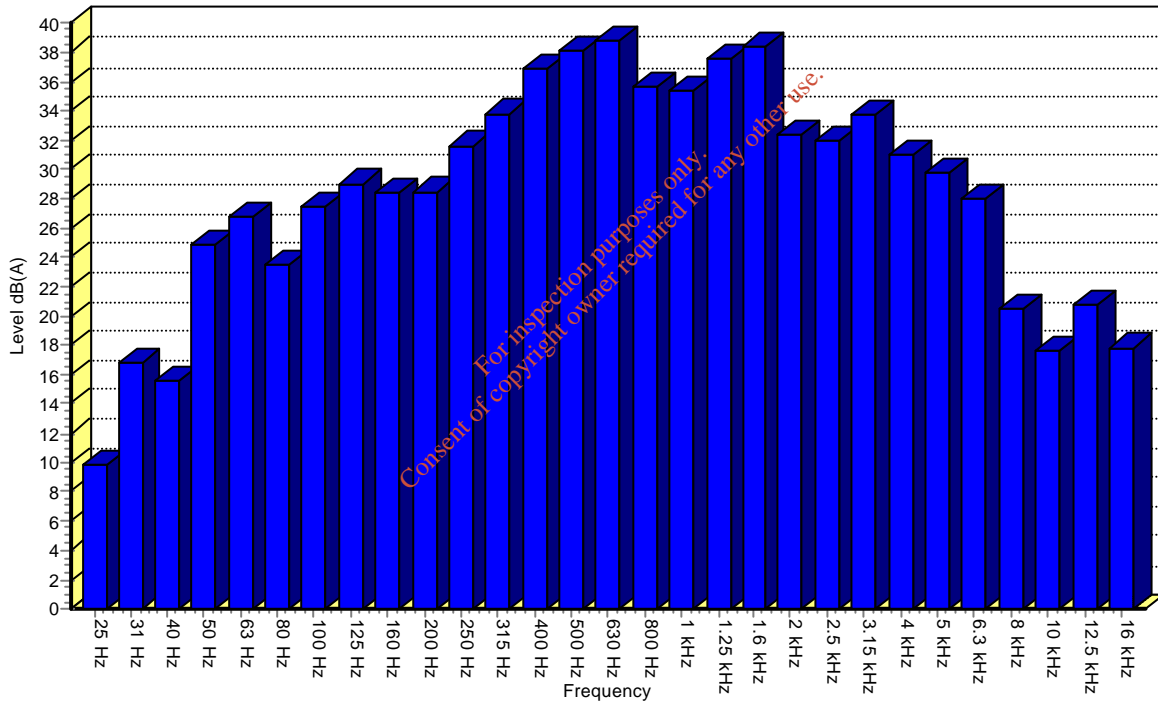

Notes: NSL 1 - Night time 1/3 Octave Frequency Analysis Measurement

Printed: 31/08/05 14:02:43

APPENDIX 2.6.1
Surface Water Results

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Waste Licence

Register Number: 124-1
Licensee: Carbury Mushrooms Limited
Location of Facility: Carbury, County Kildare

D.4 Emissions to Water

Location: (SW1) As discharge from the piped stream to the Cushaling River (SW1)

(SW1) Discharge point to the Cushaling River

<u>Parameter</u> (mg/l except for pH, temp)	<u>Emission Limit</u> Value	<u>Monitoring</u> Frequency	<u>Date</u> 10/01/06	<u>Date</u> 10/10/05
PH	6 - 9	Quarterly	7.28	7.82
Biochemical oxygen demand (BOD)	20	Quarterly	14	8.8
Suspended Solids (SS)	30	Quarterly	21	14
Total N	15	Quarterly	36	18.6
Orthophosphate (as P)	1	Quarterly	1	1.54
Temperature	23°C	Quarterly	11.4	15.4

(RW1) 30metres downstream of the discharge point (SW1) to Cushaling River

<u>Parameter</u> (mg/l except for pH, temp)	<u>Emission Limit</u> Value	<u>Monitoring</u> Frequency	<u>Date</u> 10/01/06	<u>Date</u> 10/10/05	<u>Date</u> 10/08/05	<u>Date</u> 13/04/05	<u>Date</u> 12/01/05
PH	6 - 9	Quarterly	7.48	7.79	8.3	8.2	7.5
Biochemical oxygen demand (BOD)	20	Quarterly	3.8	3.4	2	<2	<2
Suspended Solids (SS)	30	Quarterly	9.5	2.4	<5	5	27
Total N	15	Quarterly	0.32	2.2	0.35	2.8	4.5
Orthophosphate (as P)	1	Quarterly	0.13	0.07	0.1	<0.16	0.02
Temperature	23°C	Quarterly	10.2	14.2			

(RW2) 30metres upstream of the discharge point (SW1) to Cushaling River

Parameter (mg/l except for pH, temp)	Emission Limit Value	Monitoring Frequency	Date 10/01/06	Date 10/10/05	Date 10/08/05	Date 13/04/05	Date 12/01/05
PH	6 - 9	Quarterly	7.52	7.76	8.6	7.8	7.6
Biochemical oxygen demand (BOD)	20	Quarterly	3.5	2.8	2	<2	<2
Suspended Solids (SS)	30	Quarterly	10.2	2.6	5	17	15
Total N	15	Quarterly	0.22	2	0.32	2.71	4.5
Orthophosphate (as P)	1	Quarterly	0.11	0.42	0.09	<0.16	0.02
Temperature	23°C	Quarterly	10.3	14.1			

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Waste Licence

Register Number: 124-1
Licensee: Carbury Mushrooms Limited
Location of Facility: Carbury, County Kildare

D.5 Emissions to Water (Effluent treatment plant)

Location: (ETP-1) Discharge from Puraflo effluent treatment plant

Parameter (mg/l except for pH, temp)	Emission Limit Value	Monitoring Frequency	Date	10/10/05		11/07/05		04/10/04	
				Date	Value	Date	Value	Date	Value
PH	6 - 9	Bi-Annual	10/01/06	7.02				6.8	
Biochemical oxygen demand (BOD)	20	Bi-Annual	10/01/06	6.4		< 2		4	
Suspended Solids (SS)	30	Bi-Annual	10/01/06	9.6		< 5		45	
Total Ammonia (as N)	5	Bi-Annual	10/01/06	47				3.31	
Orthophosphate (as P)	1	Bi-Annual	10/01/06	4.73		0.17		4.82	
Total Phosphorus (as P)	2	Bi-Annual	10/01/06			0.35		4.3	
Oils,Fats,Grease	10	Bi-Annual	10/01/06					7	

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APPENDIX 2.9.1

Traffic Information

Appendix 2.9.1

TRAFFICWISE LTD. SURVEYS

CARBURY MUSHROOMS, DERRINTURN, CO. KILDARE
MANUAL CLASSIFIED JUNCTION COUNT

DATE: 29.04.2006

LOCATION: R403 adjacent to site DAY: Wednesday


TIME	Movement													
	1	2	3	4	5	6	7	8	9	10	11	12	13	14
16:00	CAR 35	HGV 7	CAR 38	HGV 6	CAR 1	HGV 1	CAR 1	HGV 1	CAR 1	HGV 1	CAR 2	HGV 2	CAR 1	HGV 1
16:15	CAR 27	HGV 9	CAR 47	HGV 5	CAR 1	HGV 1	CAR 1	HGV 1	CAR 1	HGV 1	CAR 1	HGV 1	CAR 1	HGV 1
16:30	CAR 22	HGV 9	CAR 56	HGV 4	CAR 1	HGV 1	CAR 2	HGV 2	CAR 2	HGV 2	CAR 1	HGV 1	CAR 1	HGV 1
16:45	CAR 40	HGV 10	CAR 63	HGV 5	CAR 1	HGV 1	CAR 1	HGV 1	CAR 1	HGV 1	CAR 2	HGV 2	CAR 1	HGV 1
17:00	CAR 39	HGV 9	CAR 66	HGV 4	CAR 1	HGV 1	CAR 1	HGV 1	CAR 1	HGV 1	CAR 1	HGV 1	CAR 1	HGV 1
17:15	CAR 49	HGV 9	CAR 65	HGV 9	CAR 2	HGV 2	CAR 1	HGV 1	CAR 1	HGV 1	CAR 1	HGV 1	CAR 1	HGV 1
17:30	CAR 31	HGV 10	CAR 71	HGV 2	CAR 2	HGV 2	CAR 1	HGV 1	CAR 1	HGV 1	CAR 2	HGV 2	CAR 1	HGV 1
17:45	CAR 47	HGV 3	CAR 81	HGV 2	CAR 2	HGV 2	CAR 1	HGV 1	CAR 1	HGV 1	CAR 3	HGV 3	CAR 1	HGV 1
18:00	CAR 30	HGV 1	CAR 62	HGV 3	CAR 1	HGV 1	CAR 1	HGV 1	CAR 1	HGV 1	CAR 2	HGV 2	CAR 1	HGV 1
18:15	CAR 34	HGV 2	CAR 58	HGV 3	CAR 1	HGV 1	CAR 1	HGV 1	CAR 1	HGV 1	CAR 2	HGV 2	CAR 1	HGV 1
18:30	CAR 24	HGV 0	CAR 72	HGV 2	CAR 1	HGV 1	CAR 1	HGV 1	CAR 1	HGV 1	CAR 2	HGV 2	CAR 1	HGV 1
18:45	CAR 28	HGV 2	CAR 49	HGV 4	CAR 1	HGV 1	CAR 1	HGV 1	CAR 1	HGV 1	CAR 1	HGV 1	CAR 1	HGV 1

- Movement 1 - Carbury to Allenwood (R403)
- Movement 2 - Allenwood to Carbury (R403)
- Movement 3 - Access 1 to Carbury
- Movement 4 - Access 1 to Allenwood
- Movement 5 - Allenwood to Access 1
- Movement 6 - Carbury to Access 1
- Movement 7 - Access 3 to Carbury
- Movement 8 - Access 3 to Allenwood
- Movement 9 - Allenwood to Access 3
- Movement 10 - Carbury to Access 3
- Movement 11 - Access 4 to Carbury
- Movement 12 - Access 4 to Allenwood
- Movement 13 - Allenwood to Access 4
- Movement 14 - Carbury to Access 4

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To Derrinturn



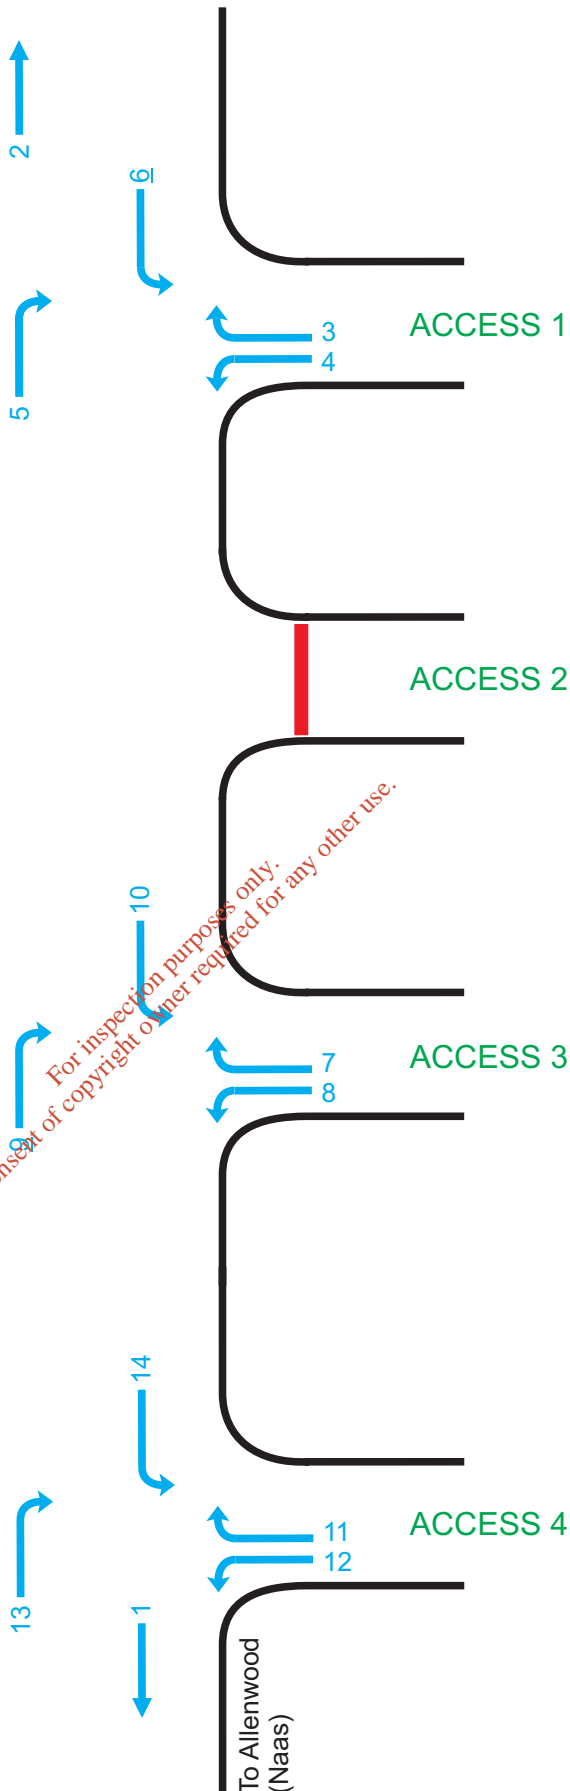Bracetown Business Park,
Clonee,
Dublin.
Telephone: +353 (0)1 8014009
Fax: +353 (0)1 8014035
Website: www.trafficwise.ie
E-mail: info@trafficwise.ie

Project/Job Title **Carbury Mushrooms, Co Kildare**

Drawing Title **Surveyed Traffic Movements
March 2006**

Drawn by:
David Ashe

Date:
May 2006

Scale: N.T.S

Checked by:
Barry May

Date:
May 2006

JOB No: 02724

Approved by:
Julian Keenan

Date:
May 2006

Figure
1

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Rev	Description	Drawn	Checked	Approved	Date
	Amendment				


trafficwise
 traffic & transportation solutions
 Brackdown Business Park,
 Clonera, Co. Dublin.
 Tel: +353 (0)1 801 4039
 Fax: +353 (0)1 801 4035
 Email: info@trafficwise.ie
 Website: www.trafficwise.ie

Carbury Mushrooms
White Young Green


Existing Carbury Mushrooms
Proposed Site Development Works
 Improvement to Existing Access Geometry
 Including Visibility Sightline Assessment

1 of 1


DRAWN	CHECKED	APPROVED
DASHE	JIKEENAN	JIKEENAN
DATE	DATE	DATE
MAY 2006	MAY 2006	MAY 2006
SCALE	JOB NO.	REV
AS SHOWN	02724	*
DWG No.: 02724/010/PL01		

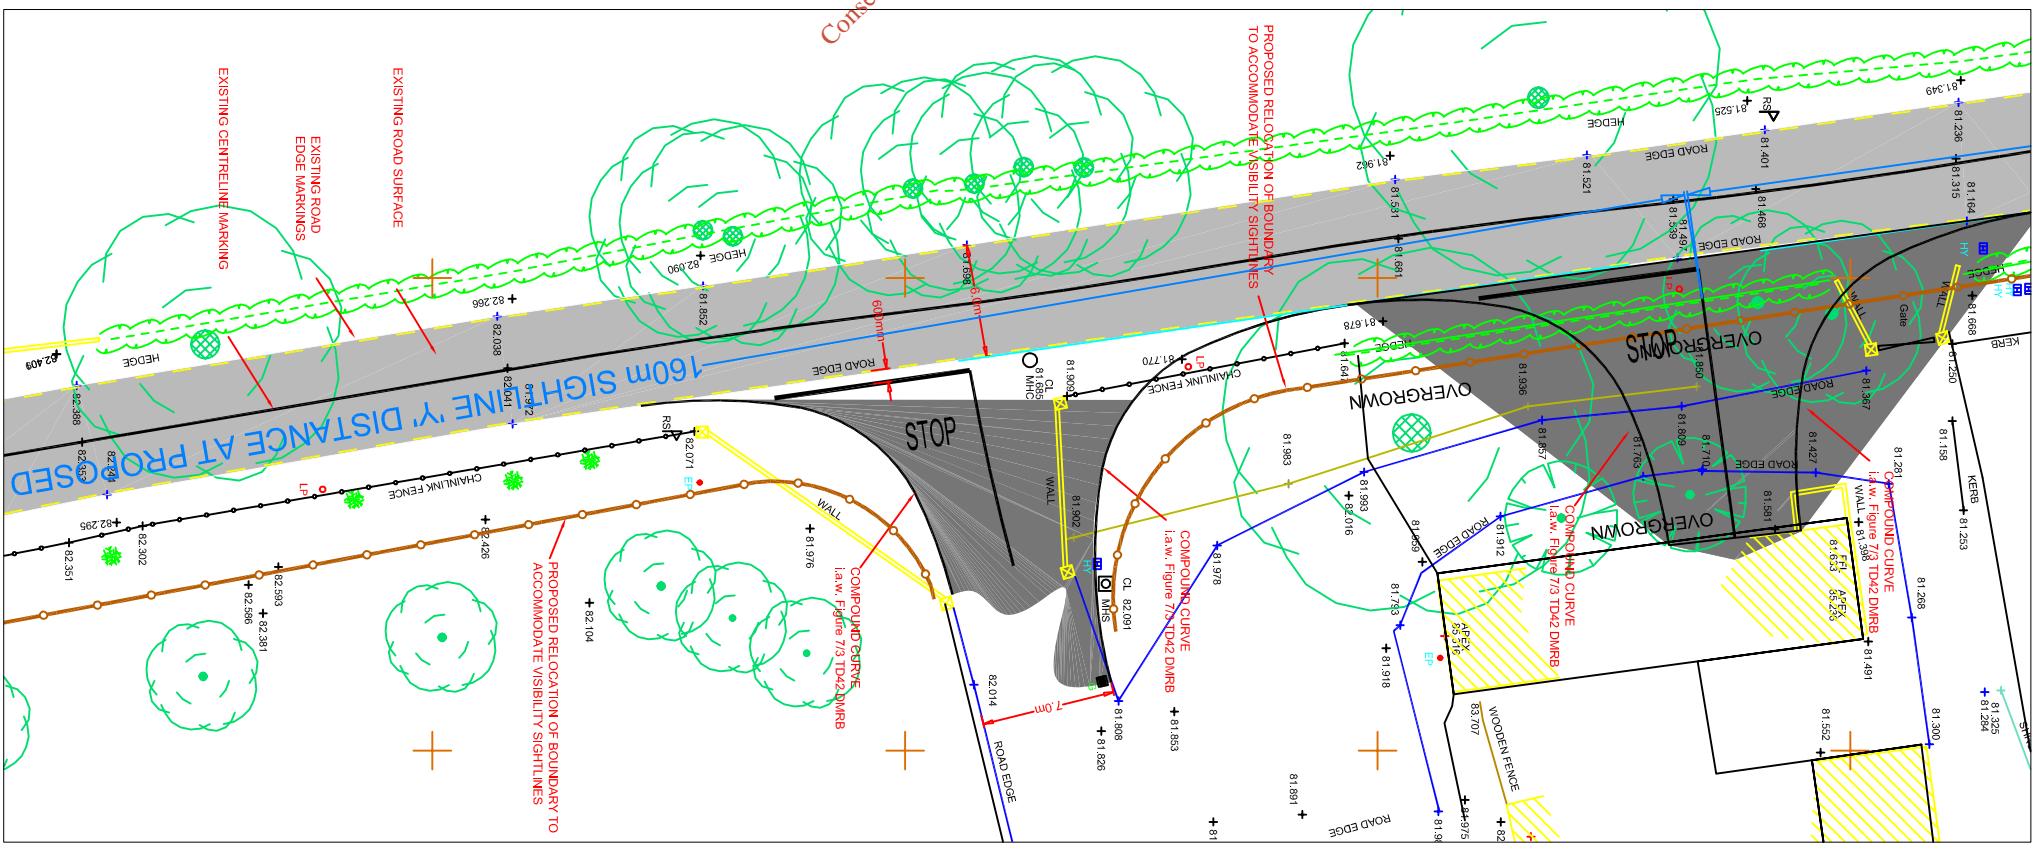

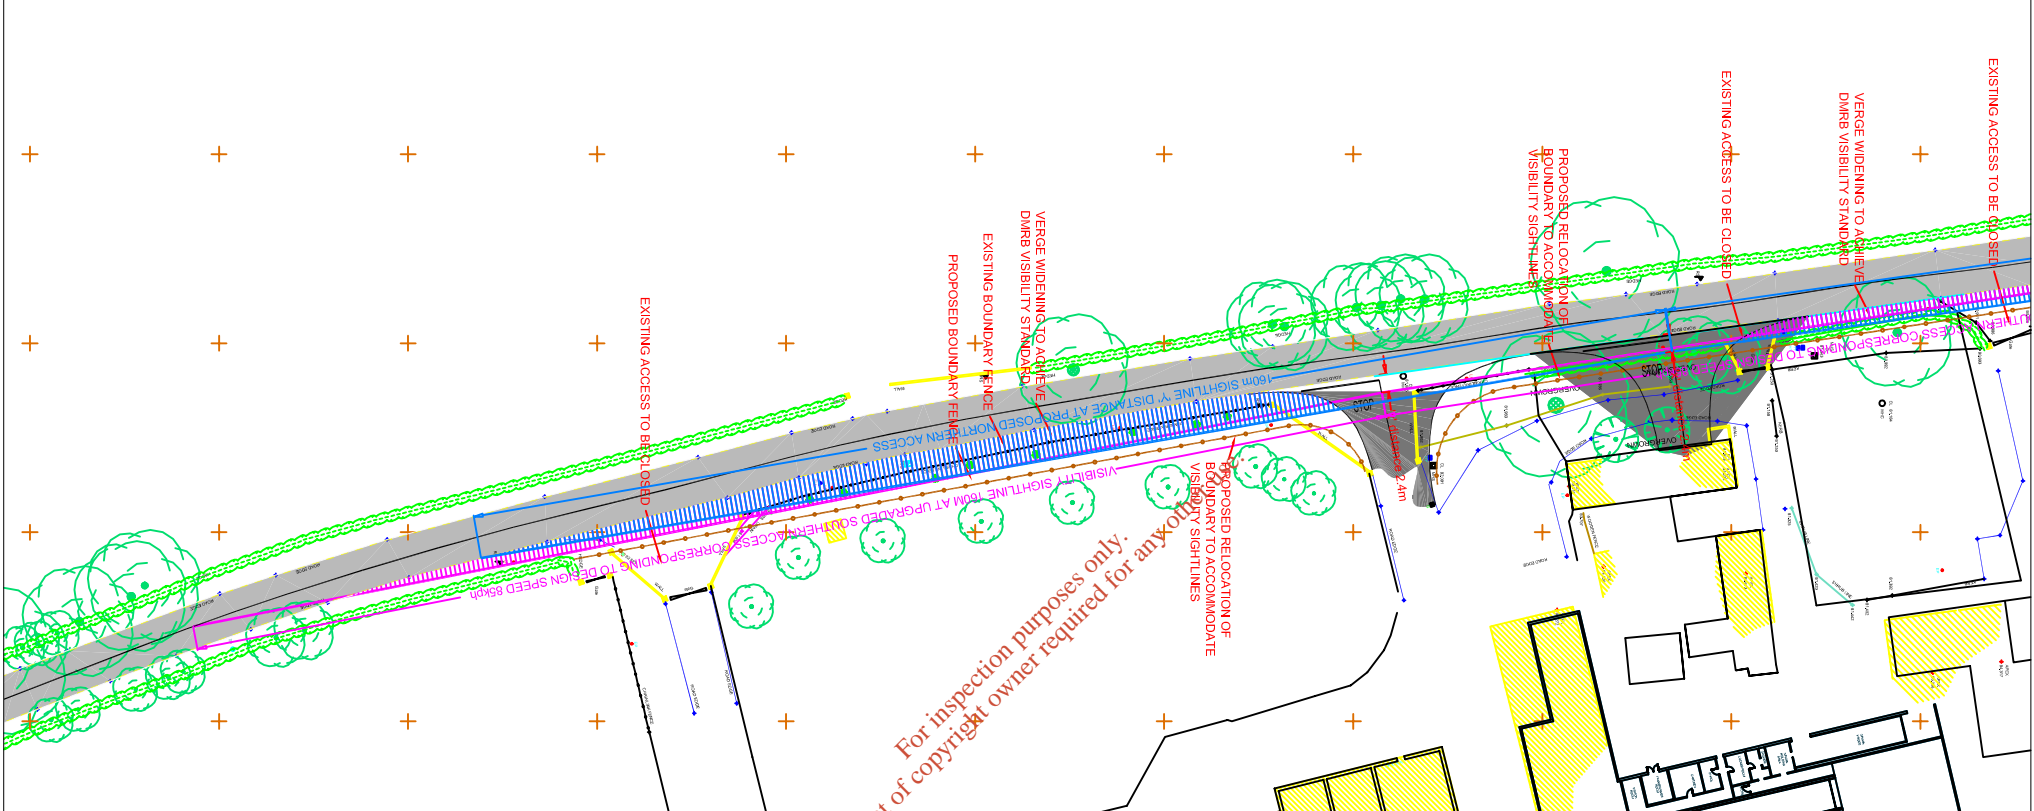GENERAL ARRANGEMENT OF UPGRADED ACCESS (1:200)



VISIBILITY SIGHTLINES TO SOUTH (1:500)

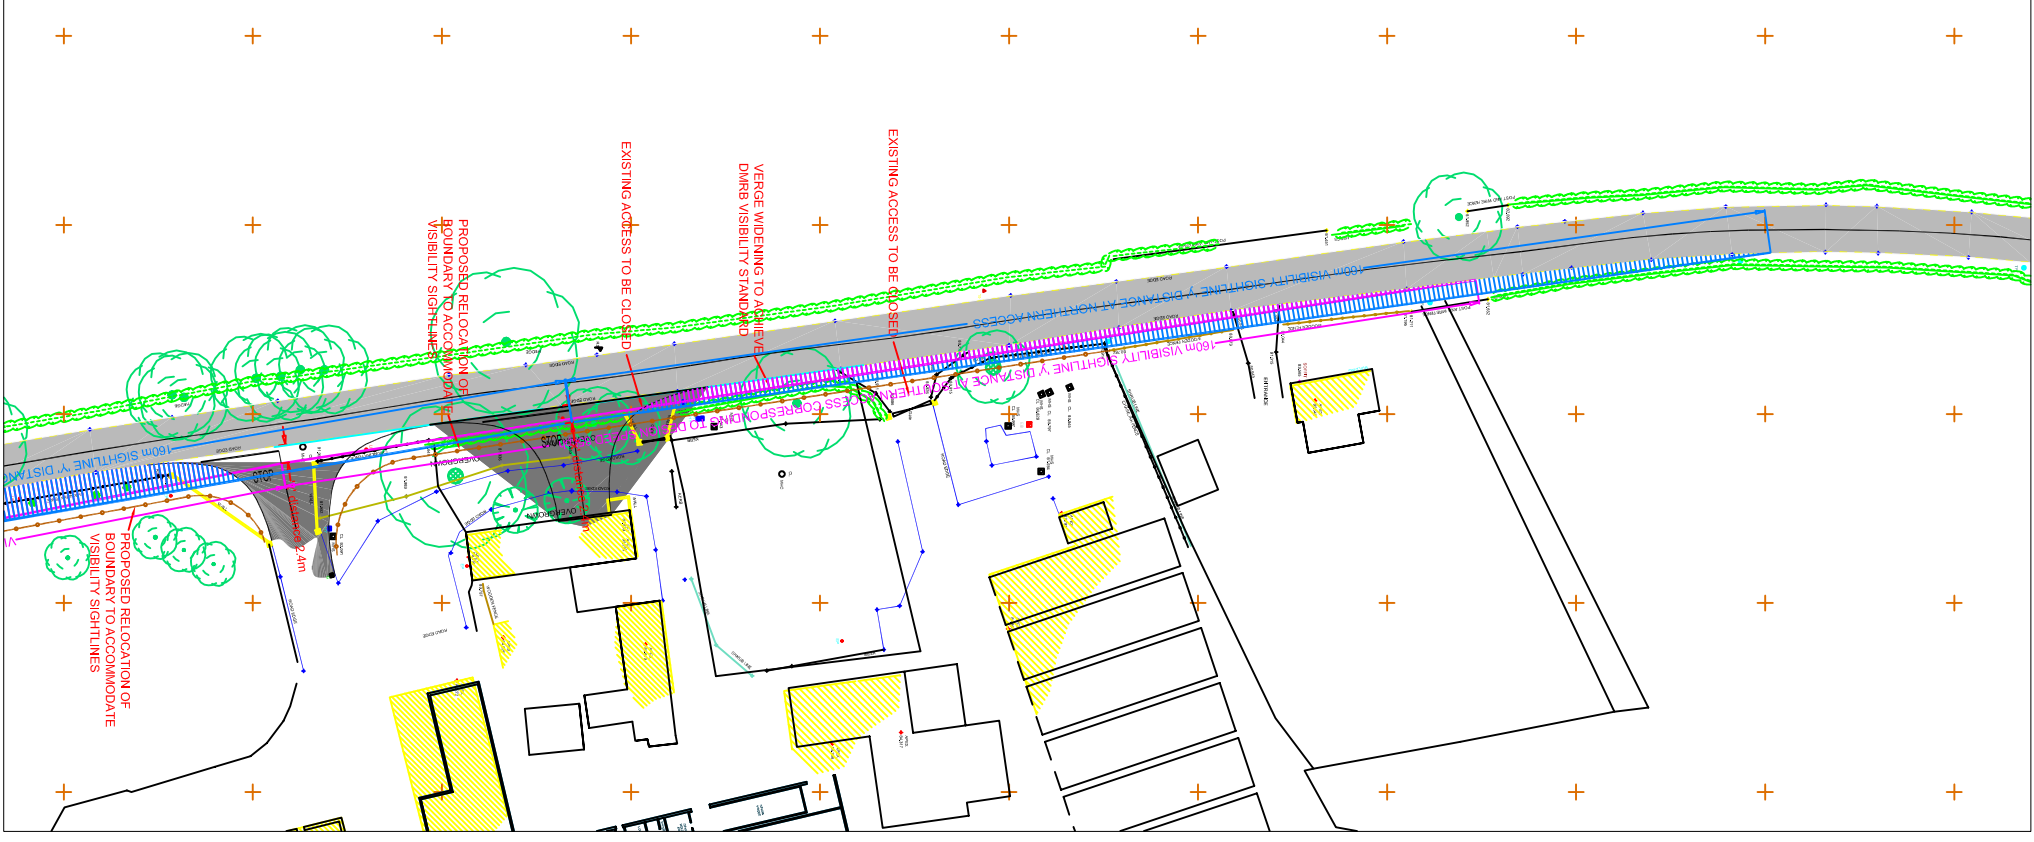

VISIBILITY SIGHTLINES TO NORTH (1:500)

APPENDIX 2.10.1

Photo-plates

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Photo-plates



Photopoint 1



Photopoint 2



Photoprint 3



Photopoint 4



Photopoint 5




Photopoint 6



Photopoint 7

SECTION SIX

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SITE LOCATION PLAN

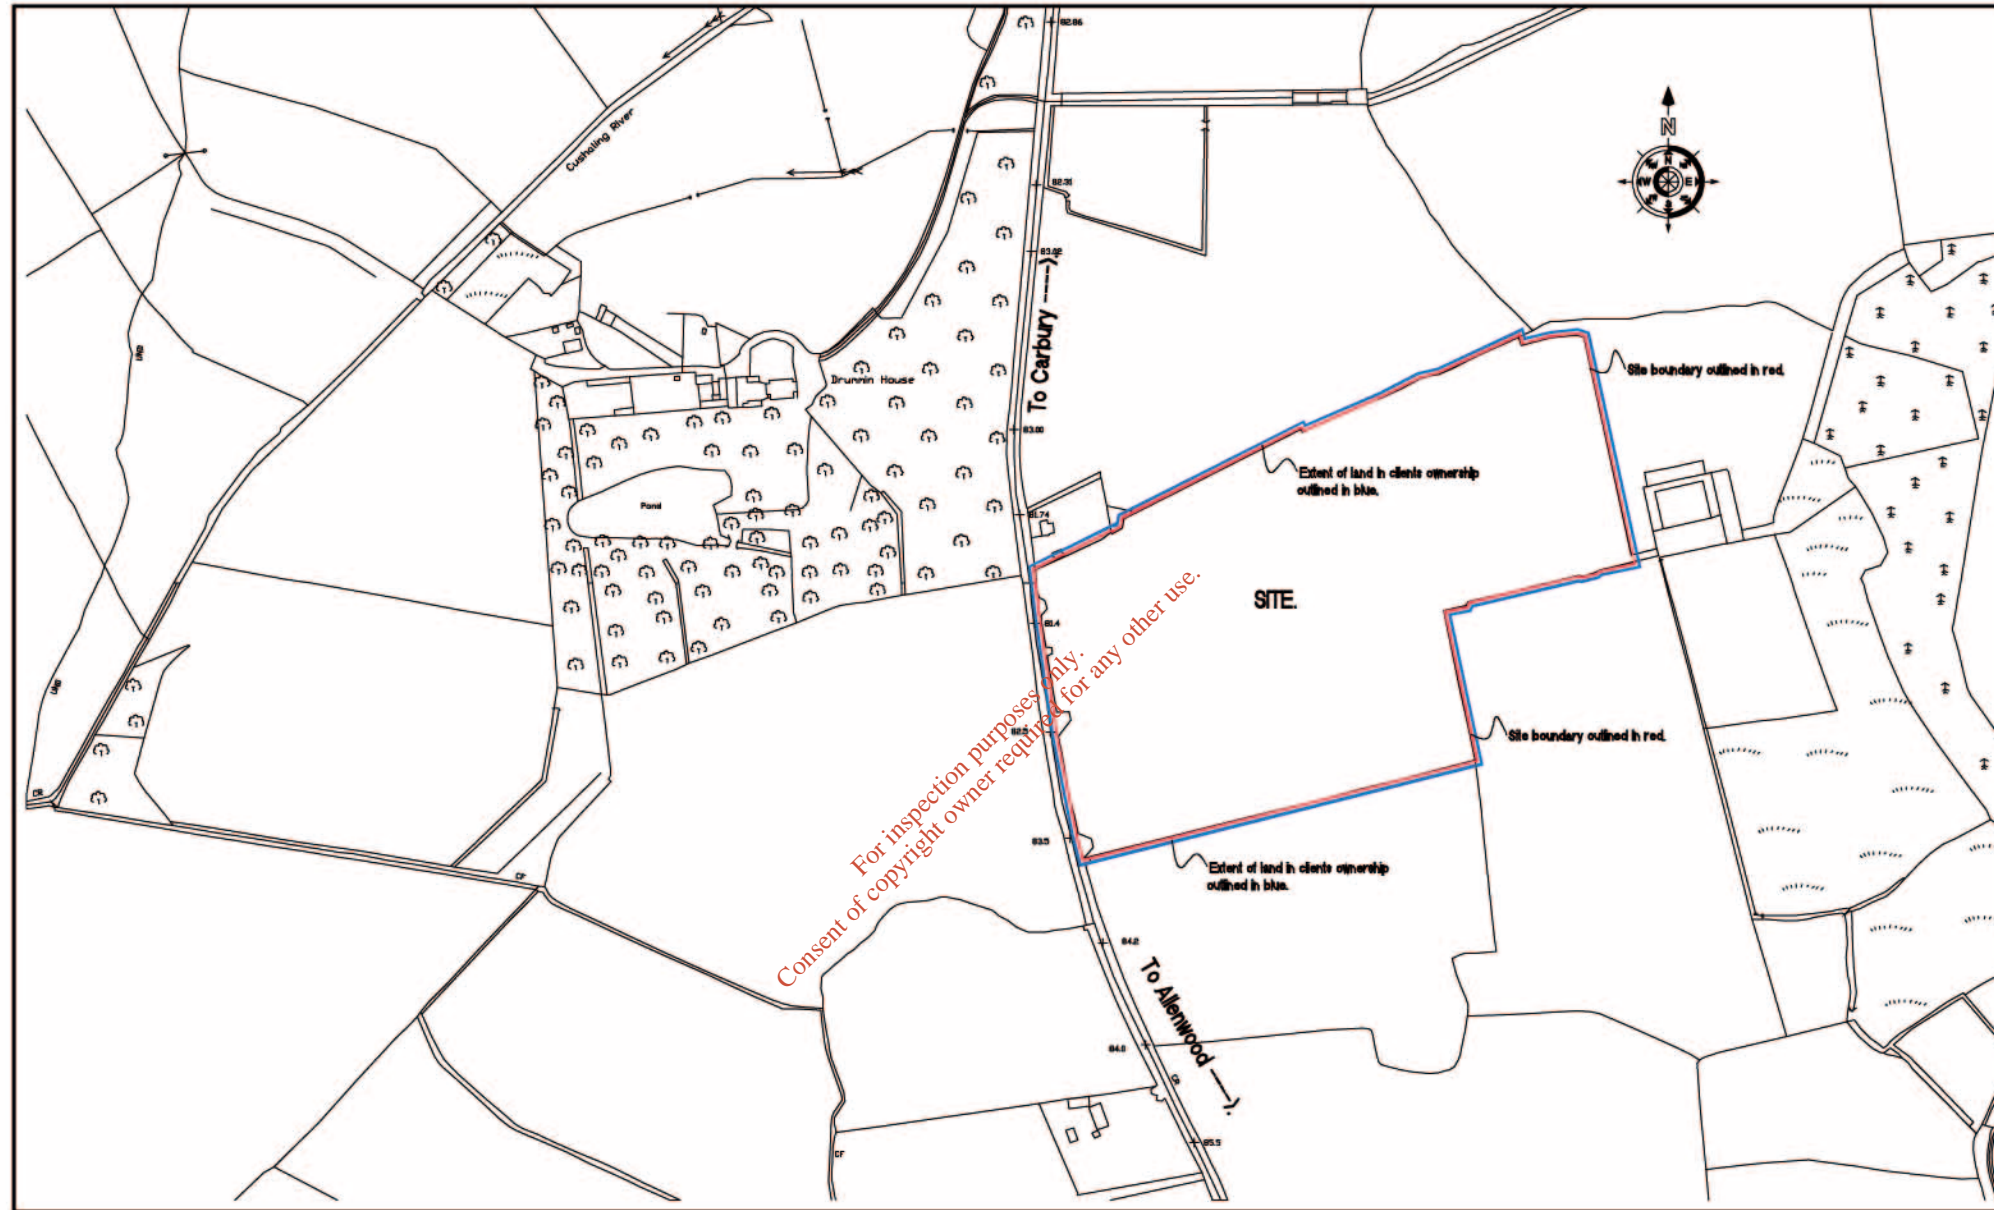SCALE 1:2500
Drumhird Ltd.
O.S. Sheet No. - 337-B, 337-D, 338-A, 338-C.
License No. - EN 007804

Sheet Title:

PLANNING DRAWING ONLY

IMPORTANT:


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Revisions

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Scale: 1:2500	Date: 05-05-2008	Job Title: PROPOSED NEW PHASE 1, 2 + 3 COMPOSTING FACILITY CARBURY COMPOST LTD. DRUMHIRD, KILDARE
Designed by: CARBURY COMPOST LTD.	Drawn by: B. THORNTON	Rev. No.
Dwg. No. 3164PL-08-101 Site Location Plan		

C. S. PRINGLE LTD.
Consulting Engineers, Architects,
Building Surveyors, Fire Engineers.
MONAGHAN RD., CASTLEBLAYNEY,
CO. MONAGHAN, IRELAND.
Tel: 042 9786492
Fax: 042 9786511
E-Mail: cl@cspringle.com



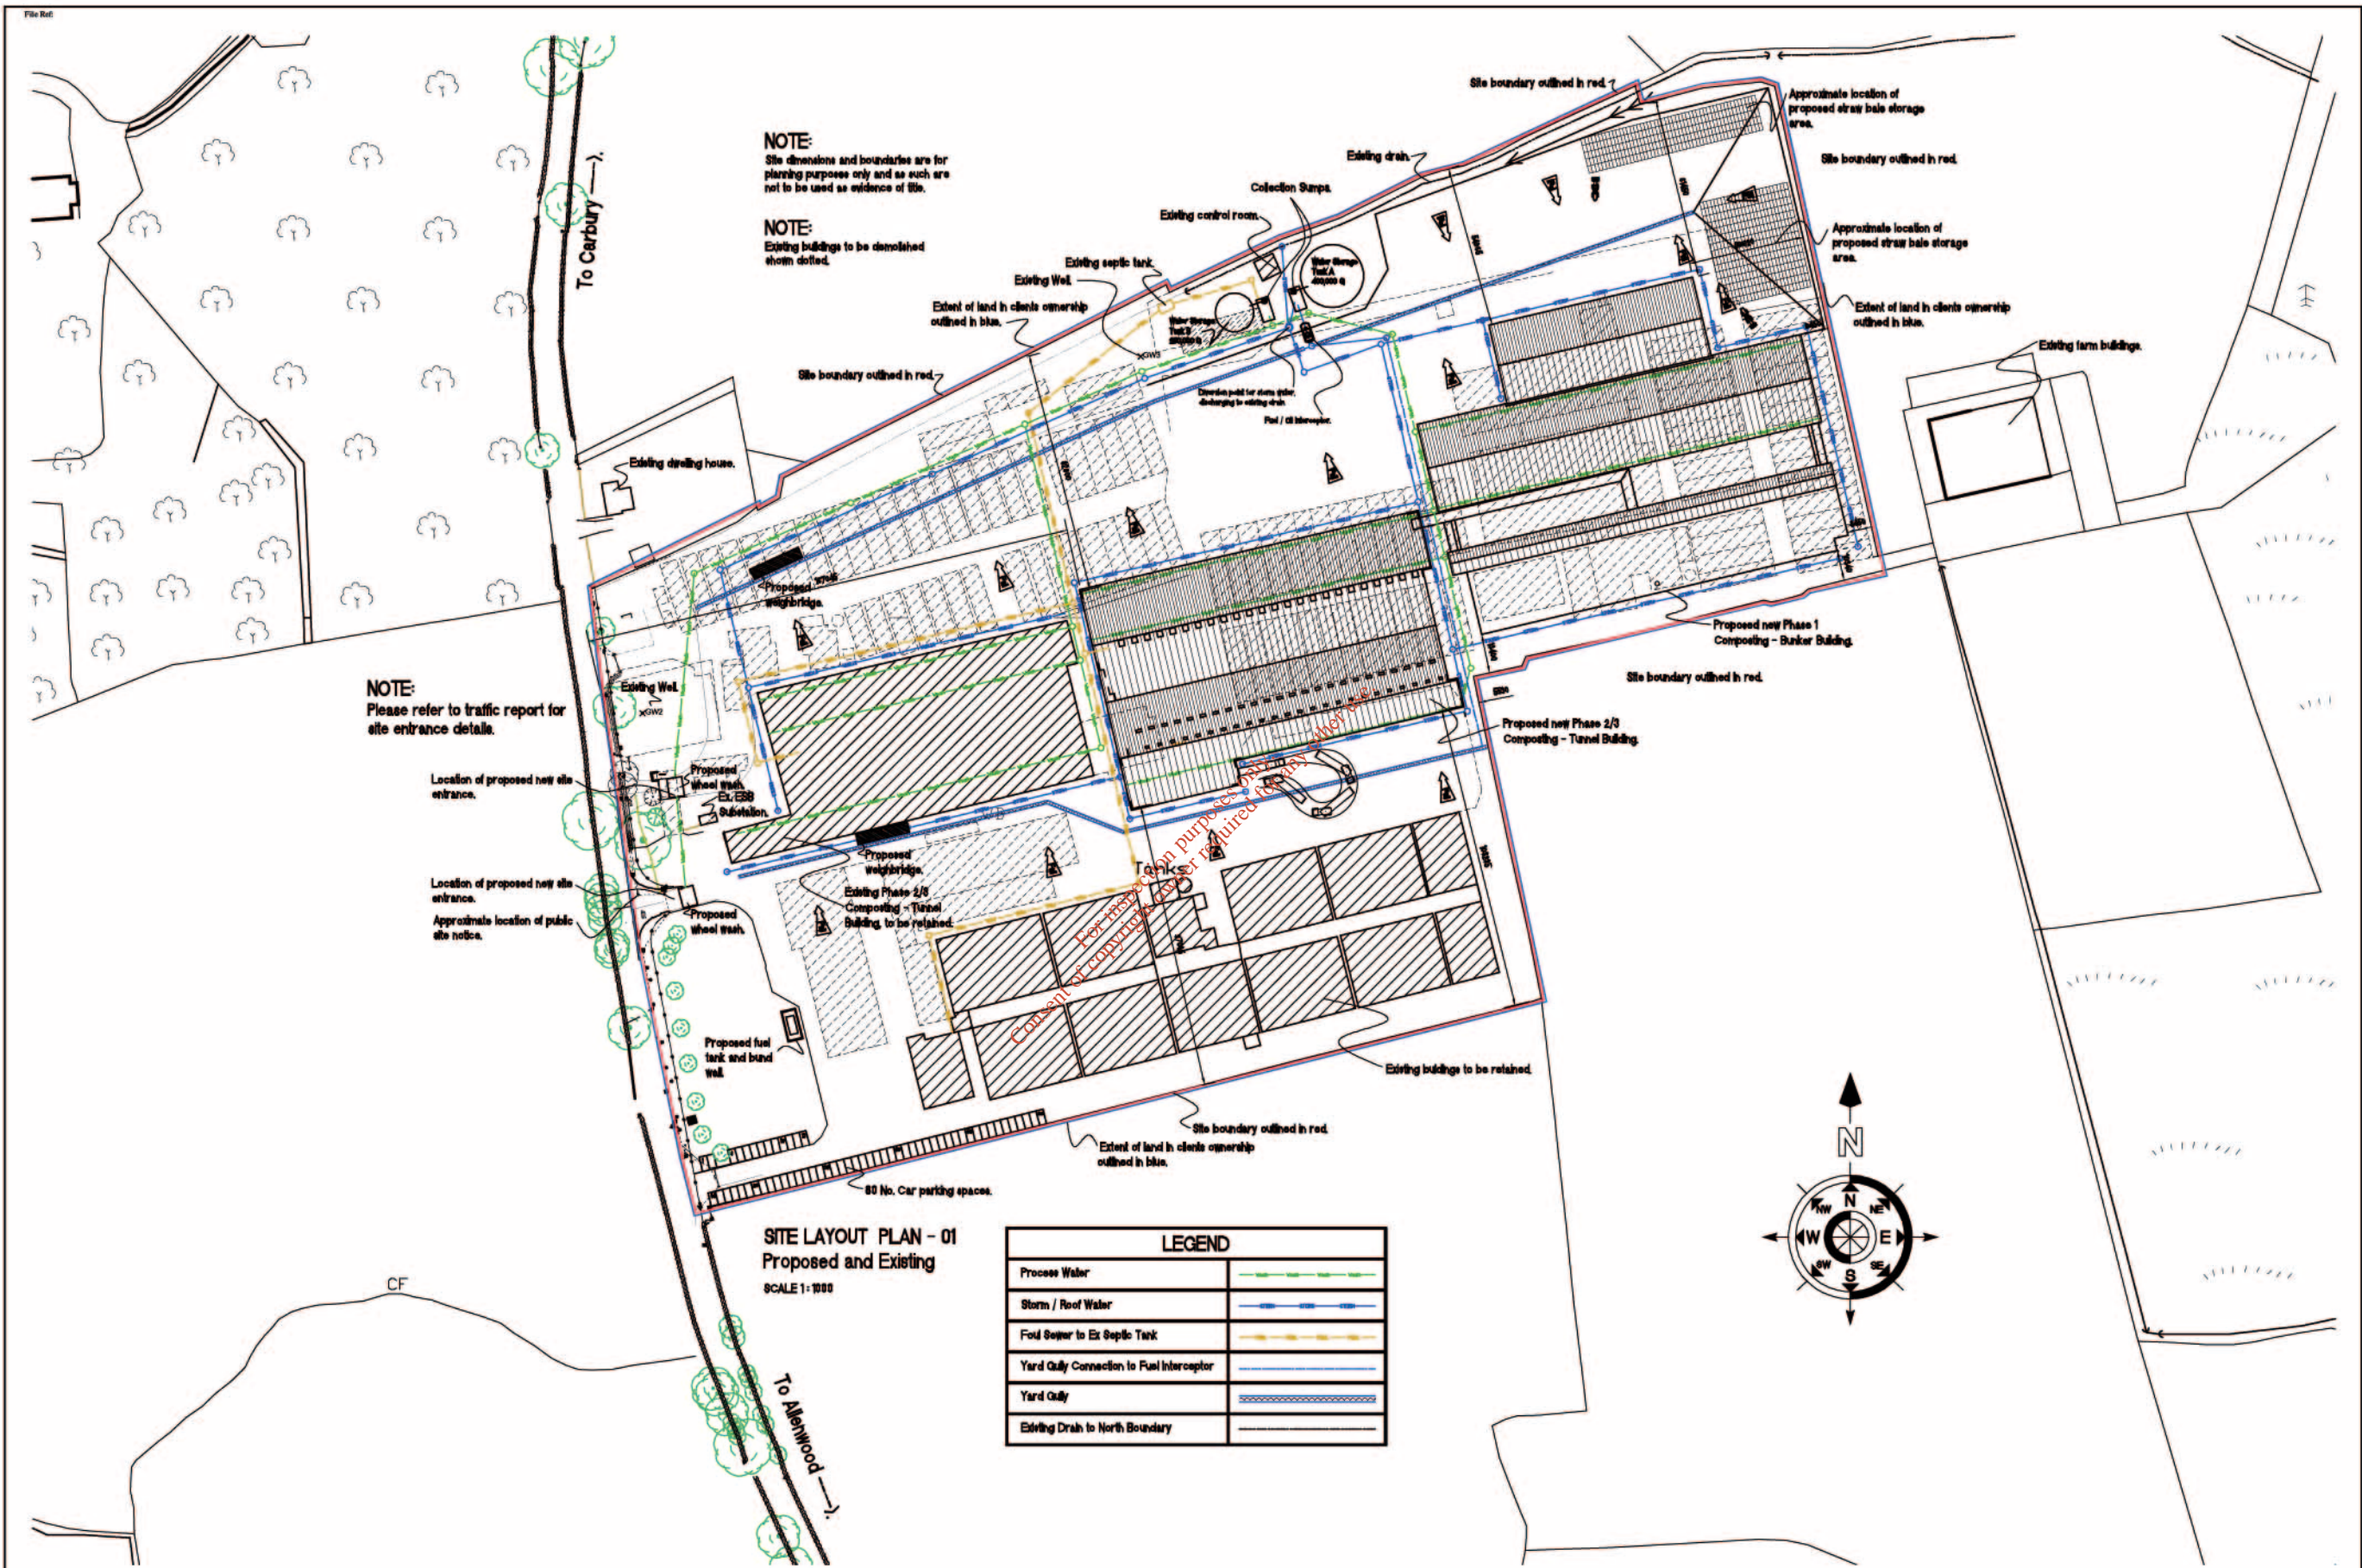NOTE:
Site dimensions and boundaries are for planning purposes only and as such are not to be used as evidence of title.

NOTE:
Existing buildings to be demolished shown dotted.

NOTE:
Please refer to traffic report for site entrance details.


Location of proposed new site entrance.

Location of proposed new site entrance.

Approximate location of public site notice.

SITE LAYOUT PLAN - 01
Proposed and Existing
SCALE 1:1000

LEGEND	
Process Water	— — — — —
Storm / Roof Water	— — — — —
Ford Sewer to Ex Septic Tank	— — — — —
Yard Gully Connection to Fuel Interceptor	— — — — —
Yard Gully	— — — — —
Existing Drain to North Boundary	— — — — —

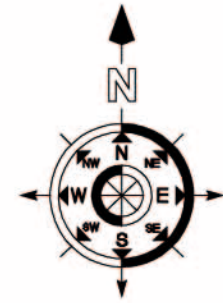


Sheet Title
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	Drawn by:	CARBURY COMPOST Ltd.
	B. THORNTON	DRUMMIN T4, KILDARE.
	Checked:	Dep. No:
		354CPL-08-102
		Site Layout Plan 01
		Rev. No:

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--	--




NOTE:
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NOTE:
Please refer to traffic report for site entrance details.

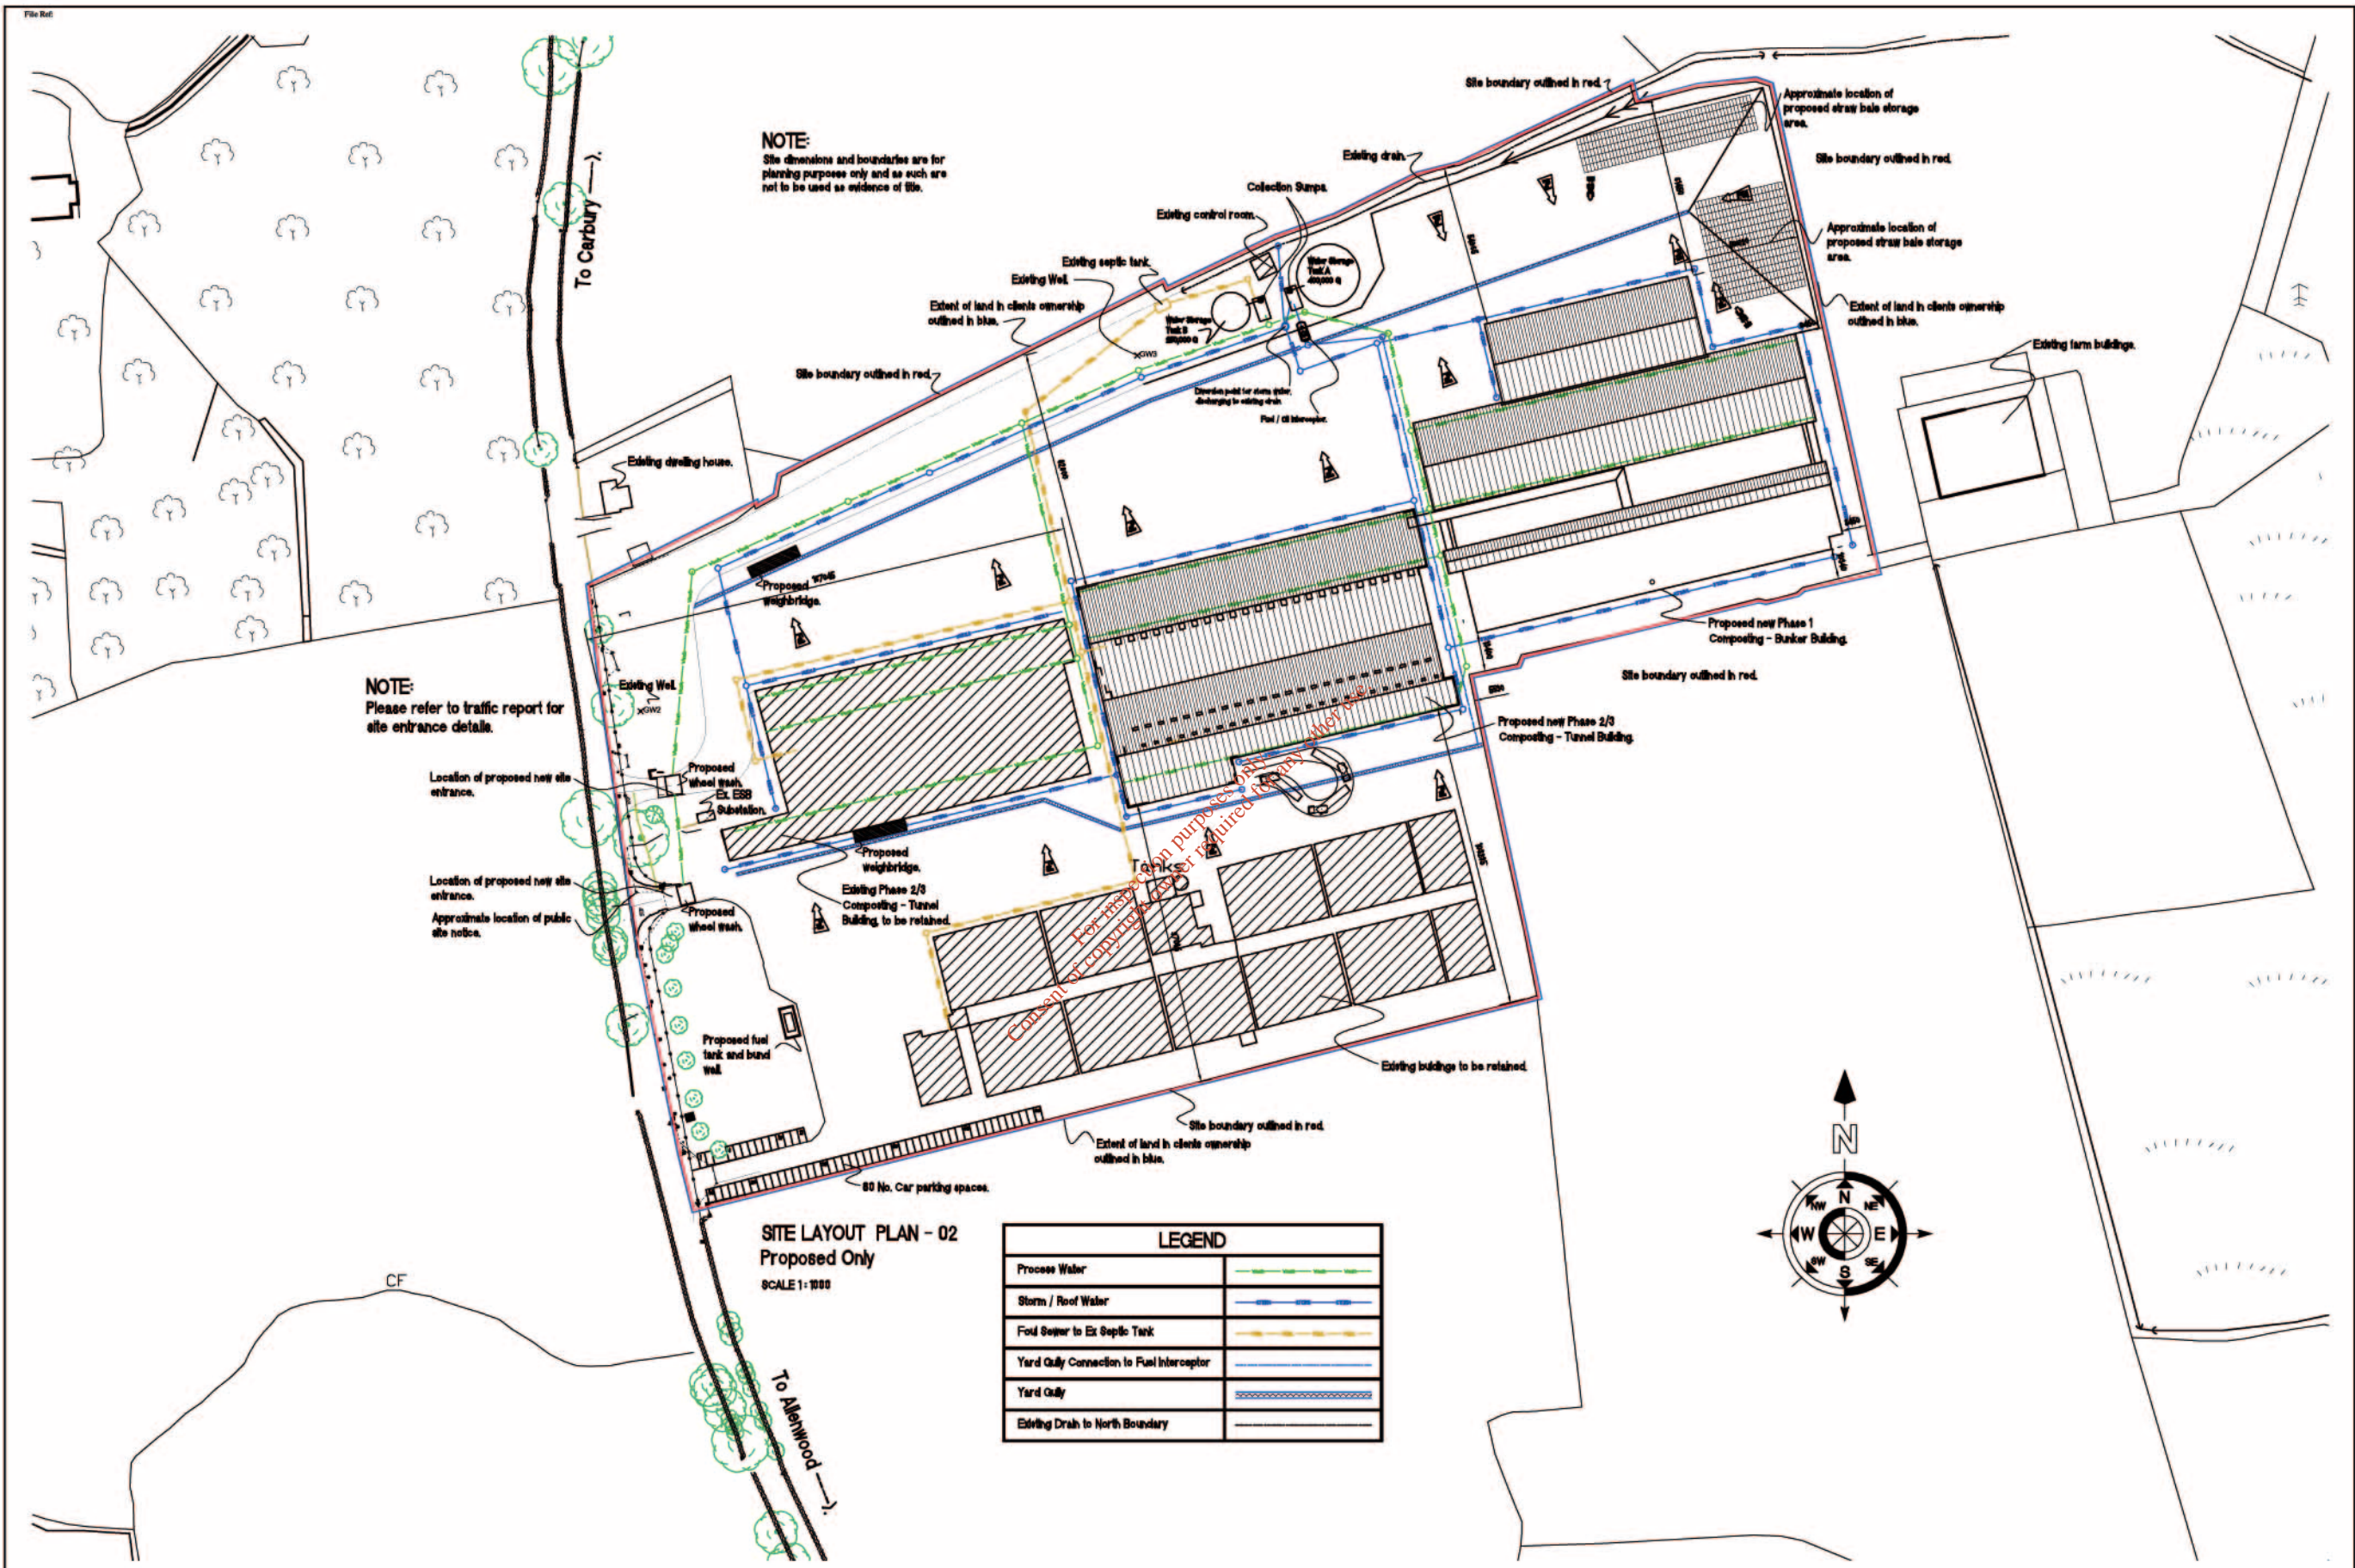SITE LAYOUT PLAN - 02
Proposed Only
SCALE 1:1000

LEGEND	
Process Water	— — — — —
Storm / Roof Water	— — — — —
Ford Sewer to Ex Septic Tank	— — — — —
Yard Gully Connection to Fuel Interceptor	— — — — —
Yard Gully	— — — — —
Existing Drain to North Boundary	— — — — —

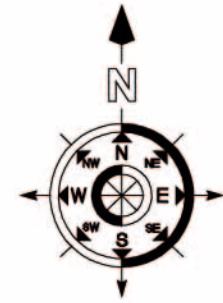

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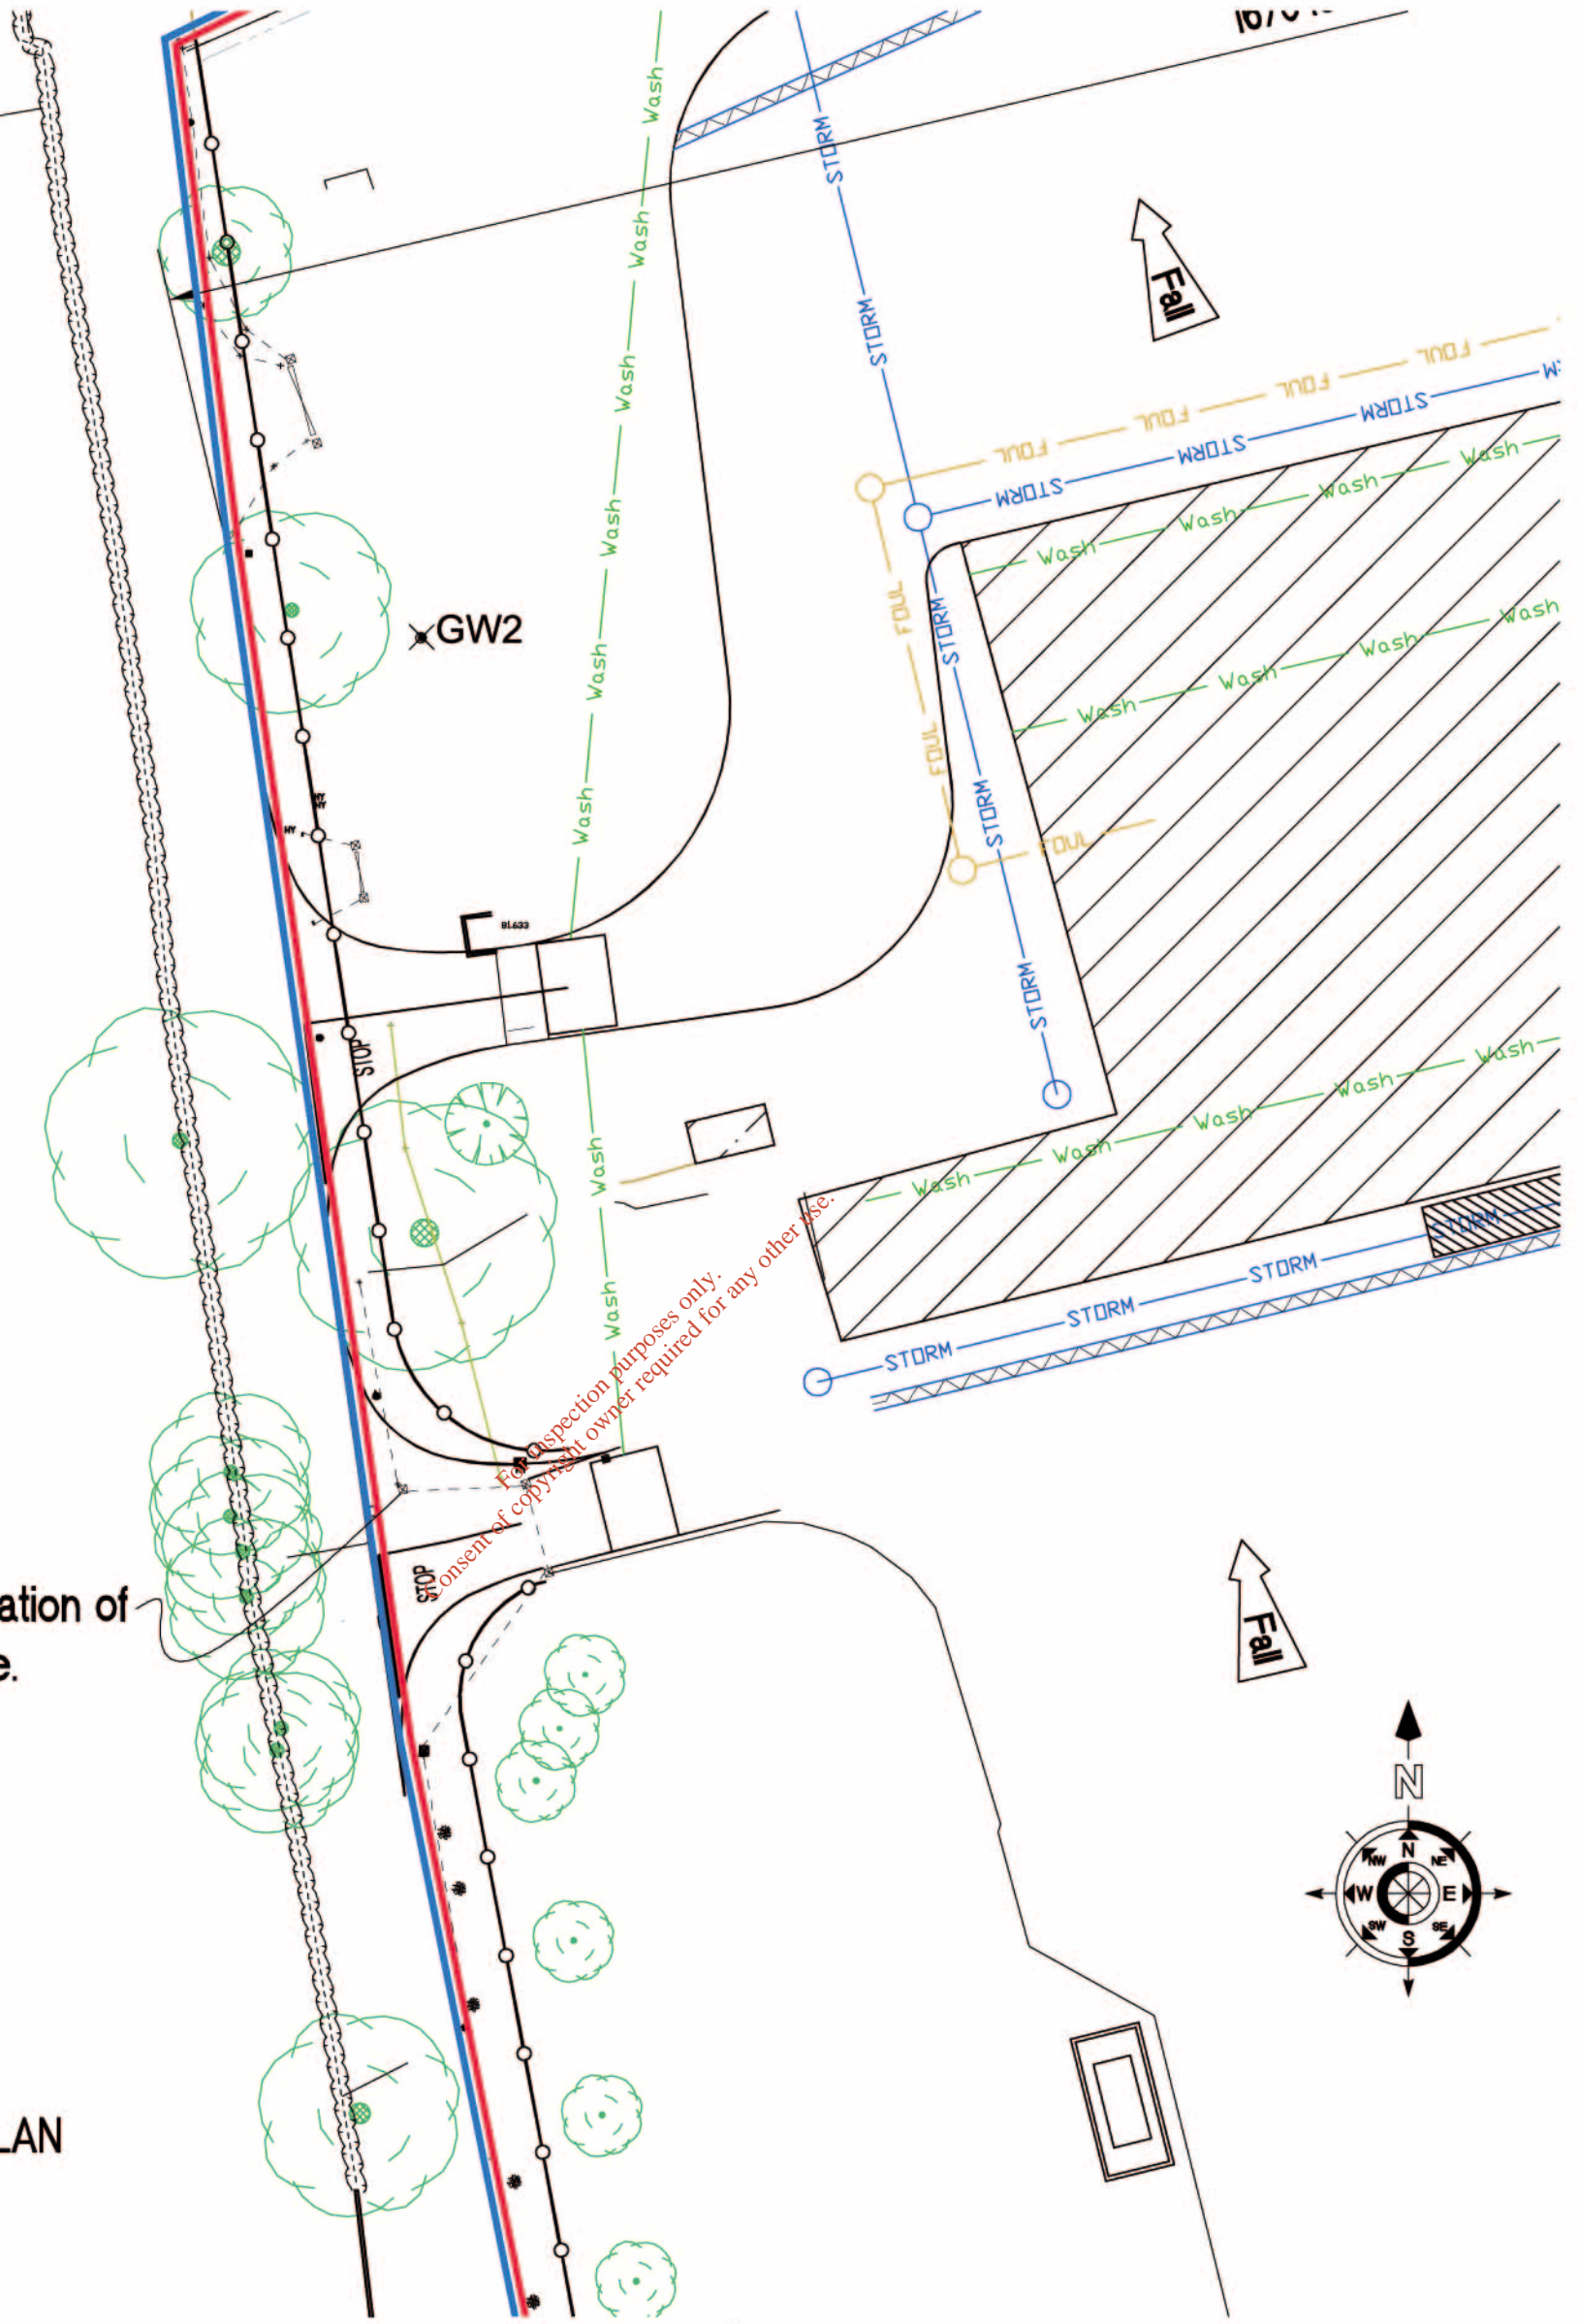
Revisions:	

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Checked by:		Rev. No.:	

Job Title:	PROPOSED NEW PHASE 1, 2 + 3 COMPOSTING FACILITY
Client:	CARBURY COMPOST Ltd. DRUMMIN T4, KILDARE.
Dwg. No.:	3164CPL-08-108
Site Layout Plan 02	

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E-Mail: csl@cspringle.com

File Ref:



Approximate location of Public Site Notice.

SITE NOTICE PLAN

SCALE 1 : 500

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Scales:

1 : 500

Date:

05-05-2006

Job Title:

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 CARBURY COMPOST Ltd.
 DRUMMIN Td., KILDARE.

Designed By:

CARBURY COMPOST Ltd.

Drawn by:

B. Thornton

Checked:


Drg. No.

3154CPL-'06-1.04
 Site Notice Plan

Rev. No.

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 Consulting Engineers, Architects,
 Building Surveyors, Fire Engineers.

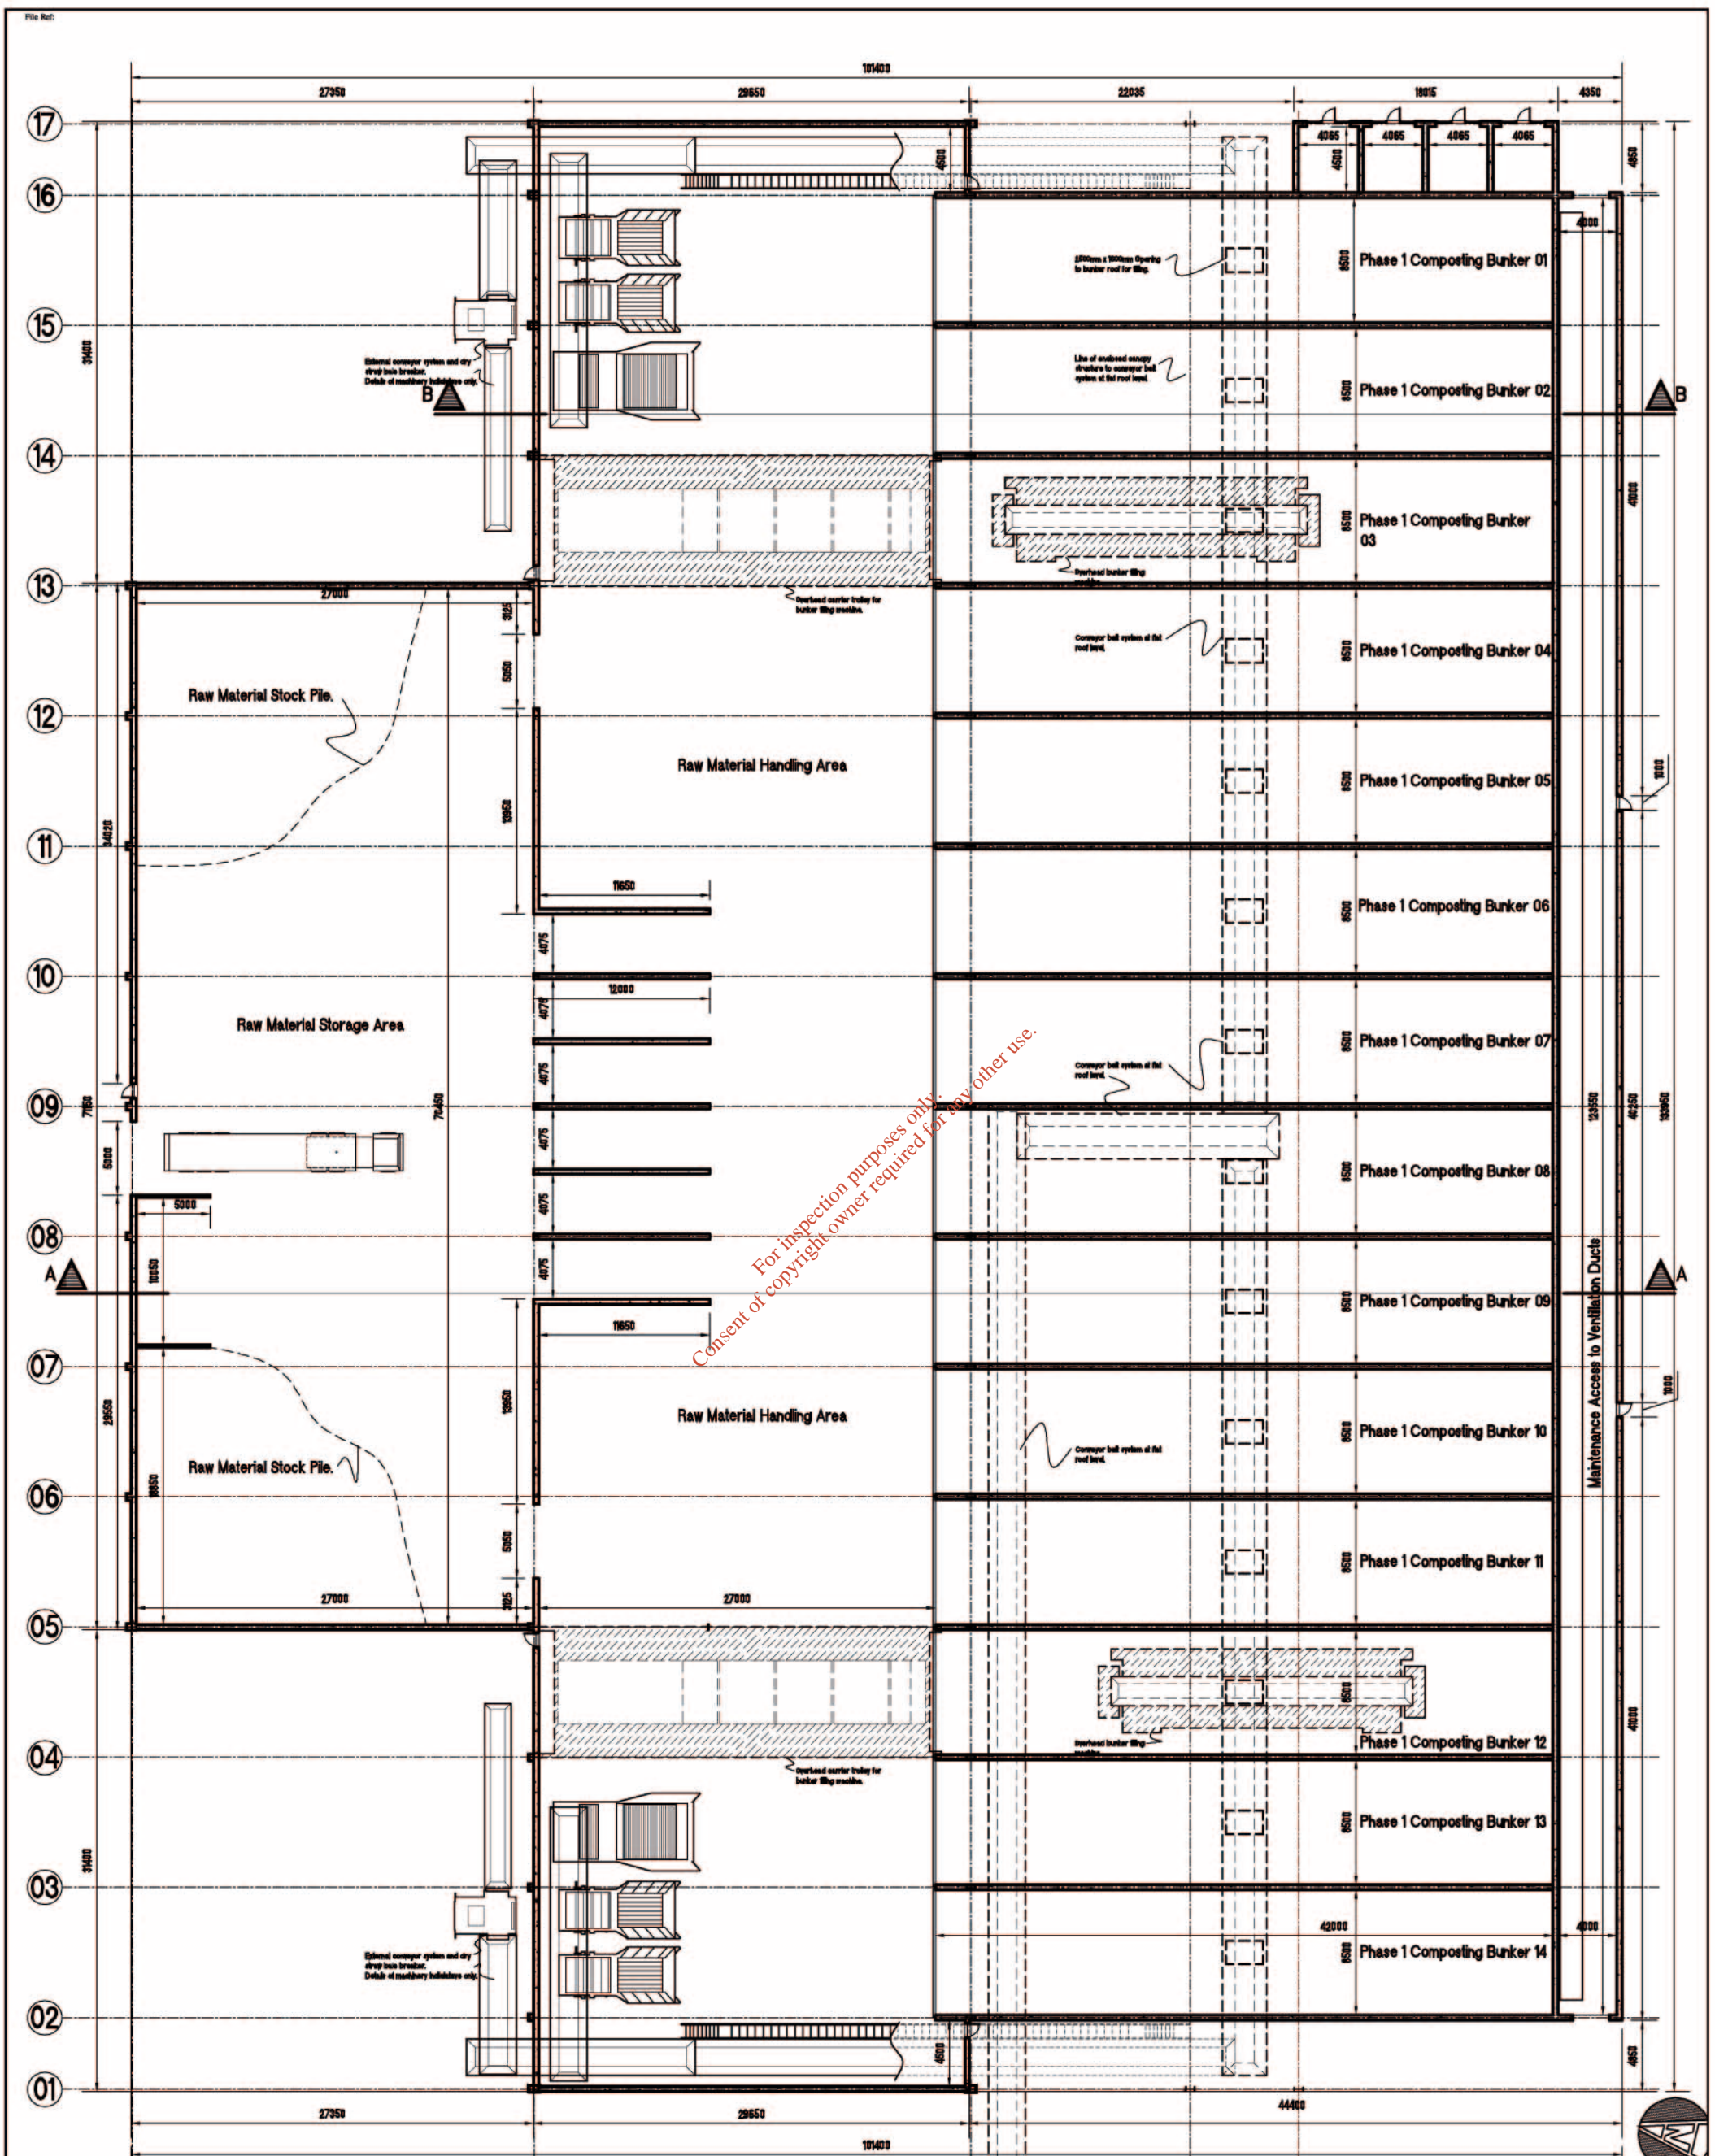MONAGHAN Rd., CASTLEBLAYNEY,
 Co. MONAGHAN, IRELAND.
 Tel: 042-9746492
 Fax: 042-9746511
 E-Mail: cb@cspringle.com




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A Floor Plan - Phase 1 Composting Facility
SCALE 1:200
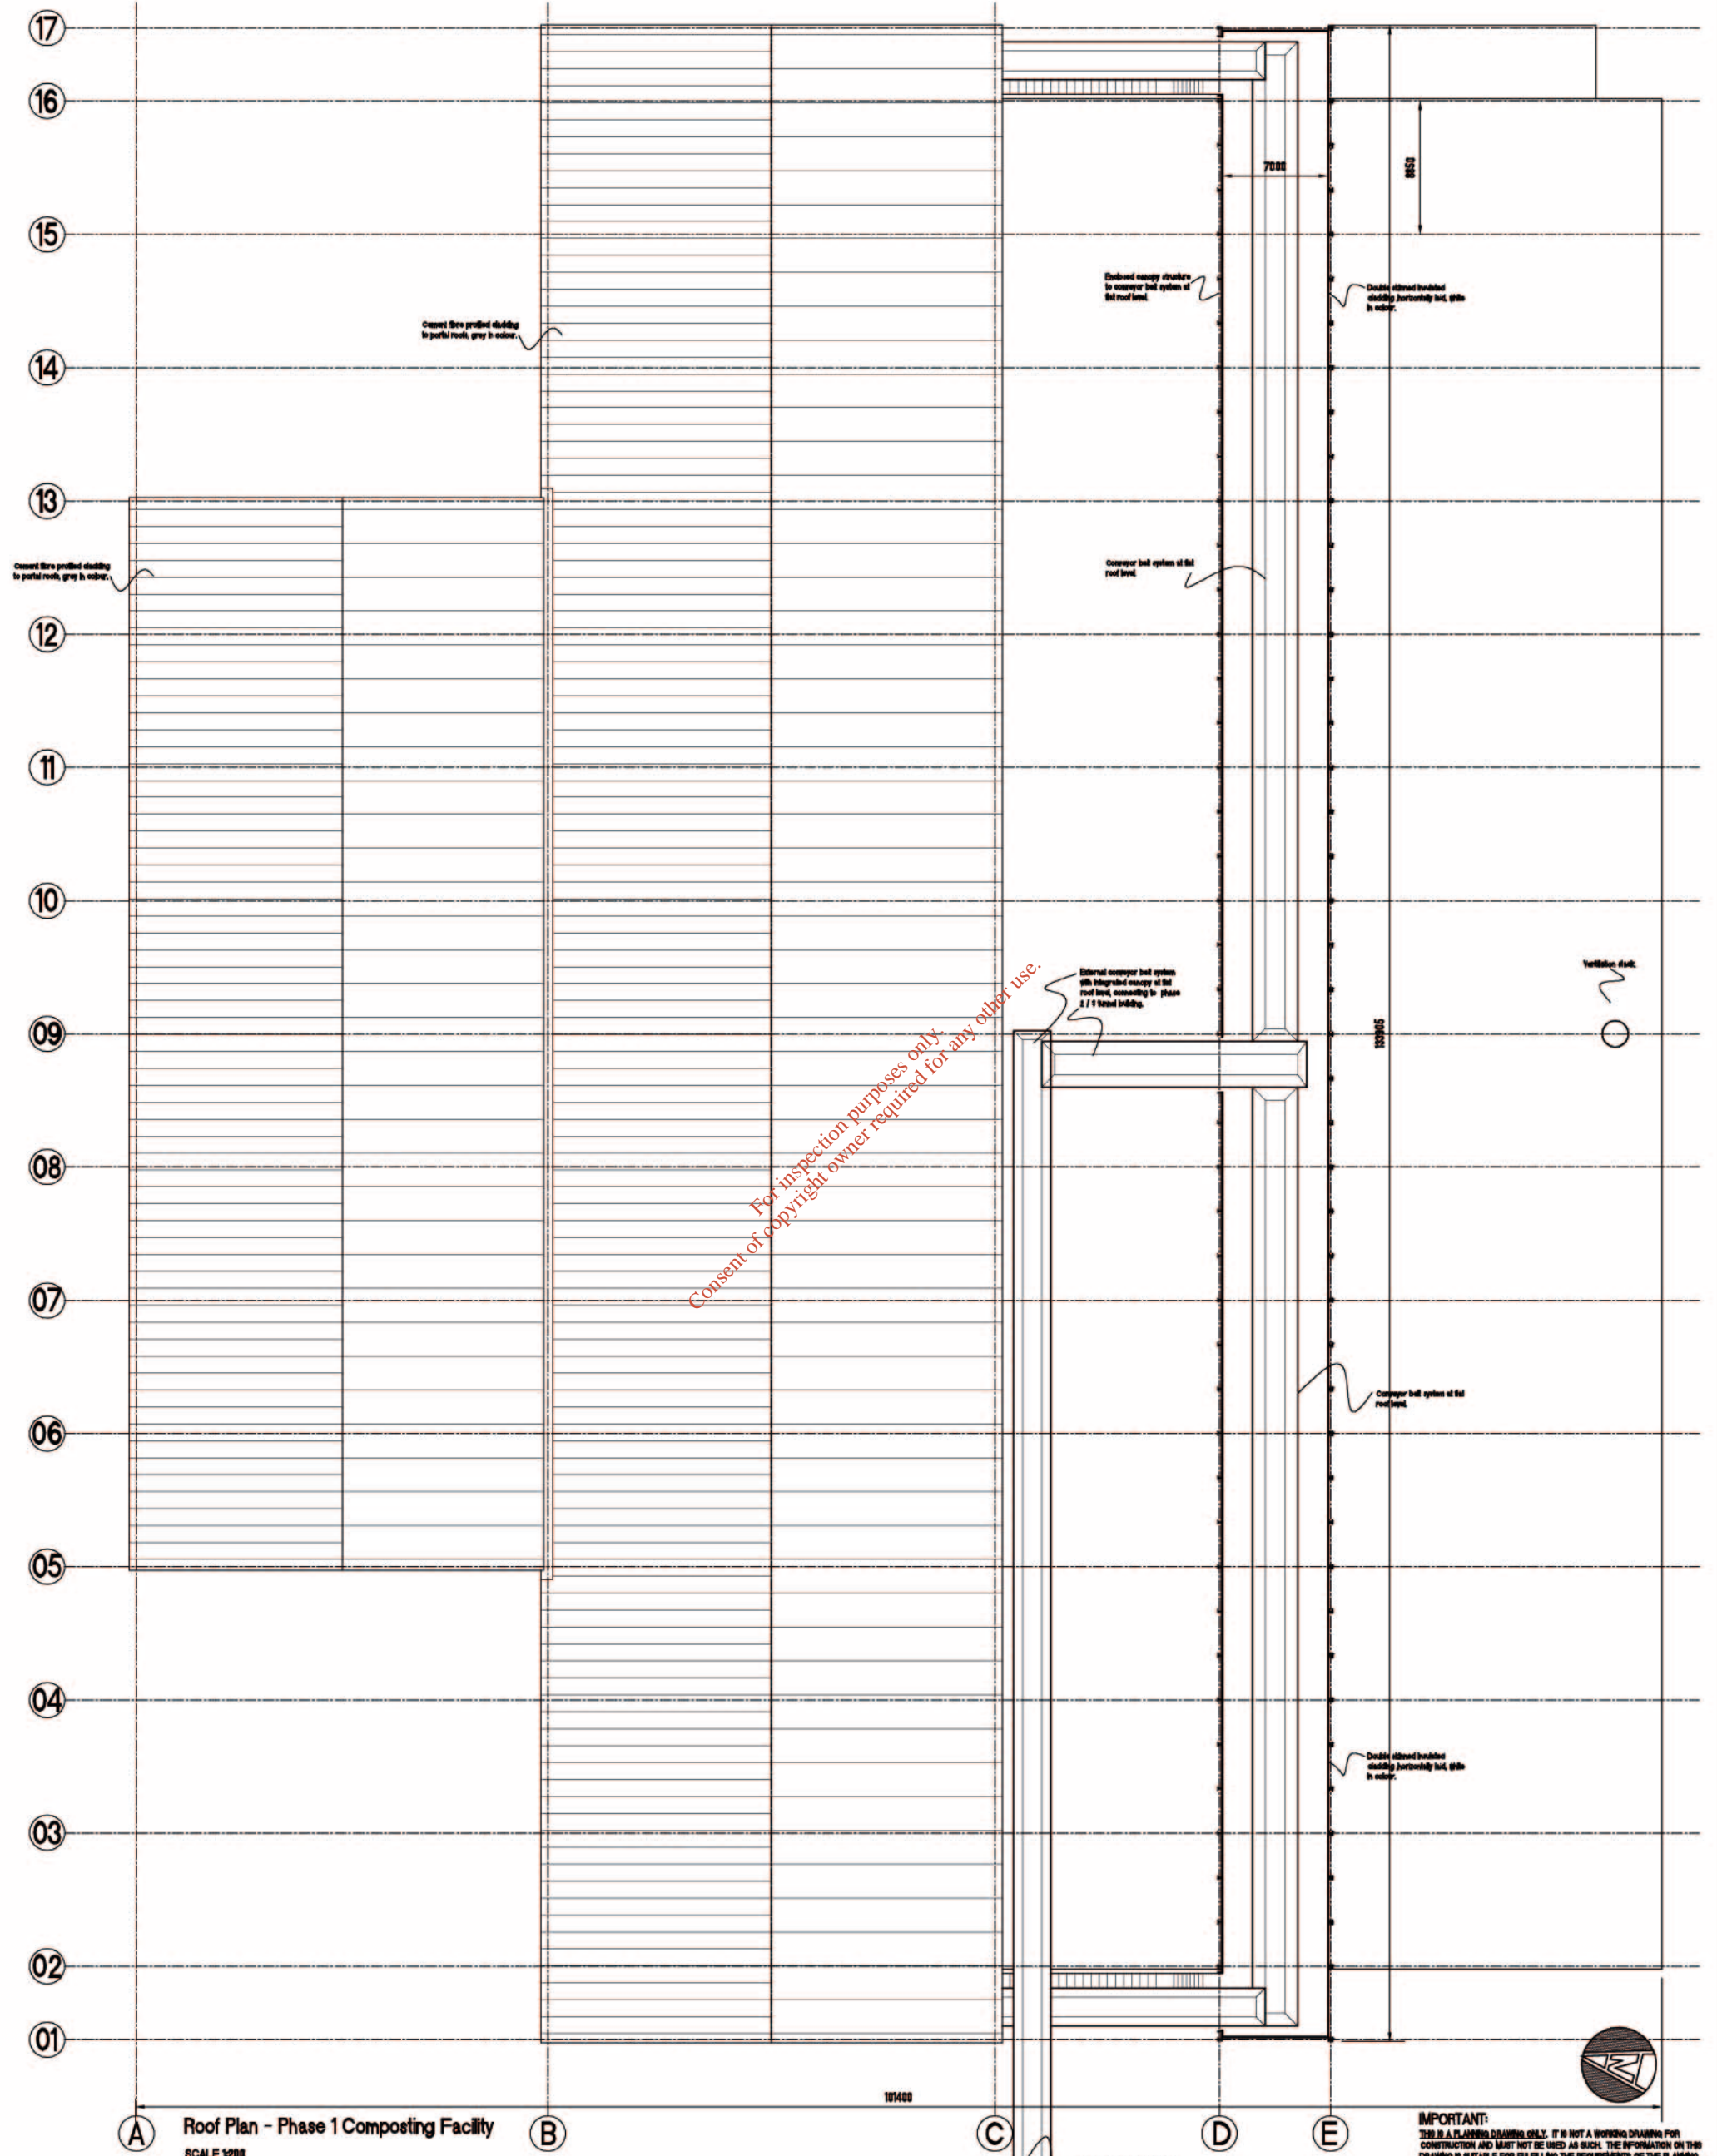
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	Designed By: CARBURY COMPOST Ltd.	Drawn by: B. THORNTON	Checked:	Job Title: CARBURY COMPOST Ltd. DRIAMIN Td, KILDARE.	Dep. No.: 0154CPL-06-2/01		
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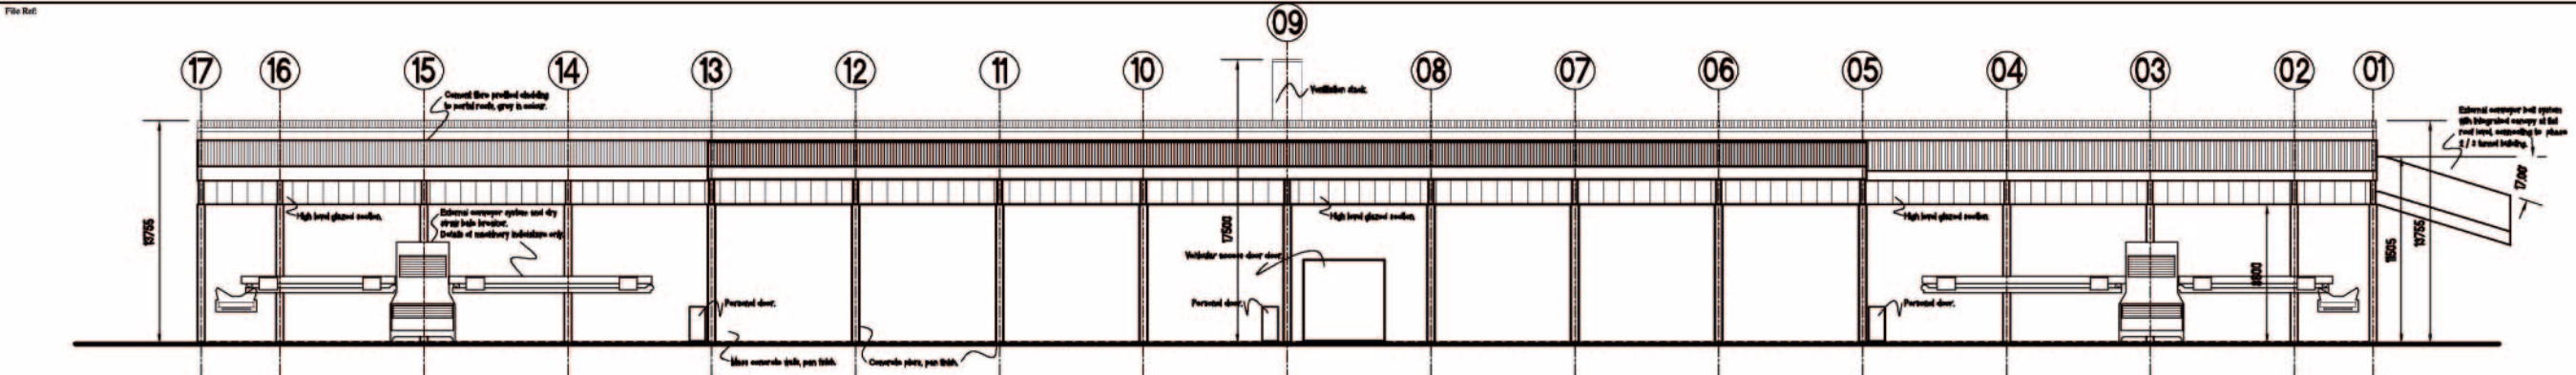
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A Roof Plan - Phase 1 Composting Facility
SCALE 1:200

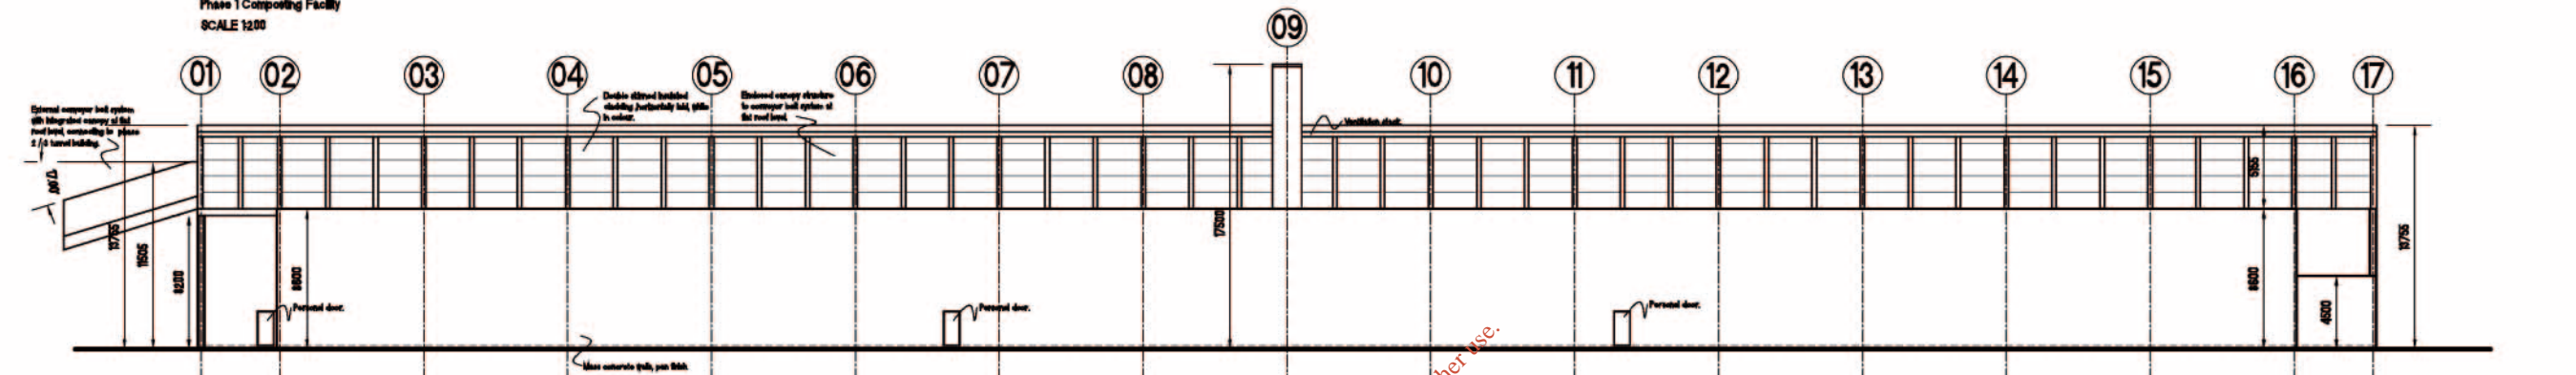
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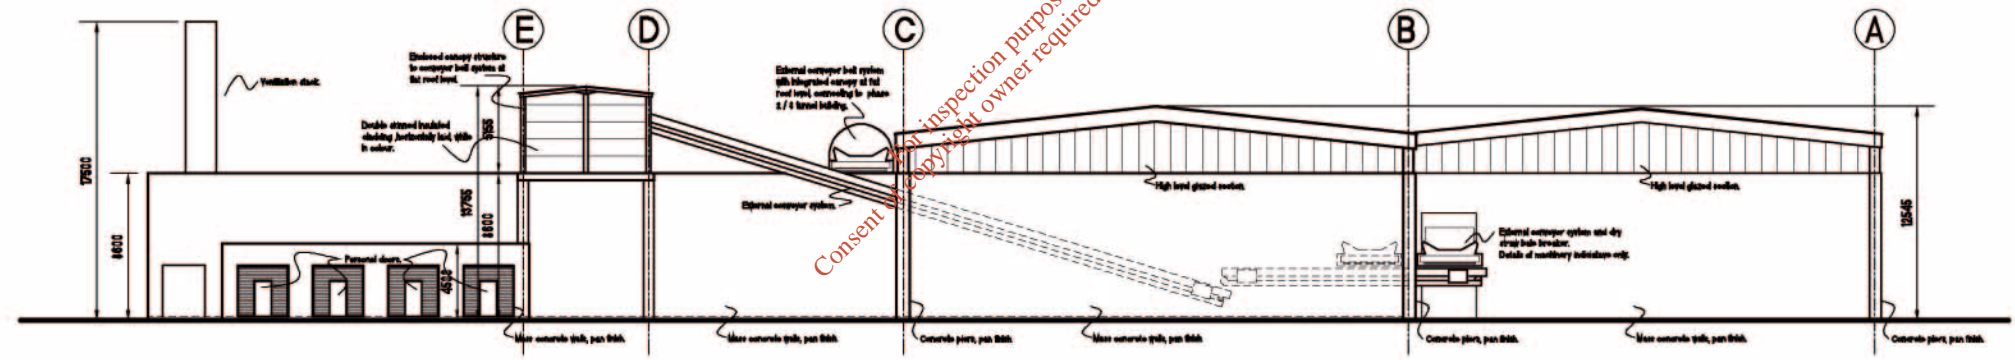
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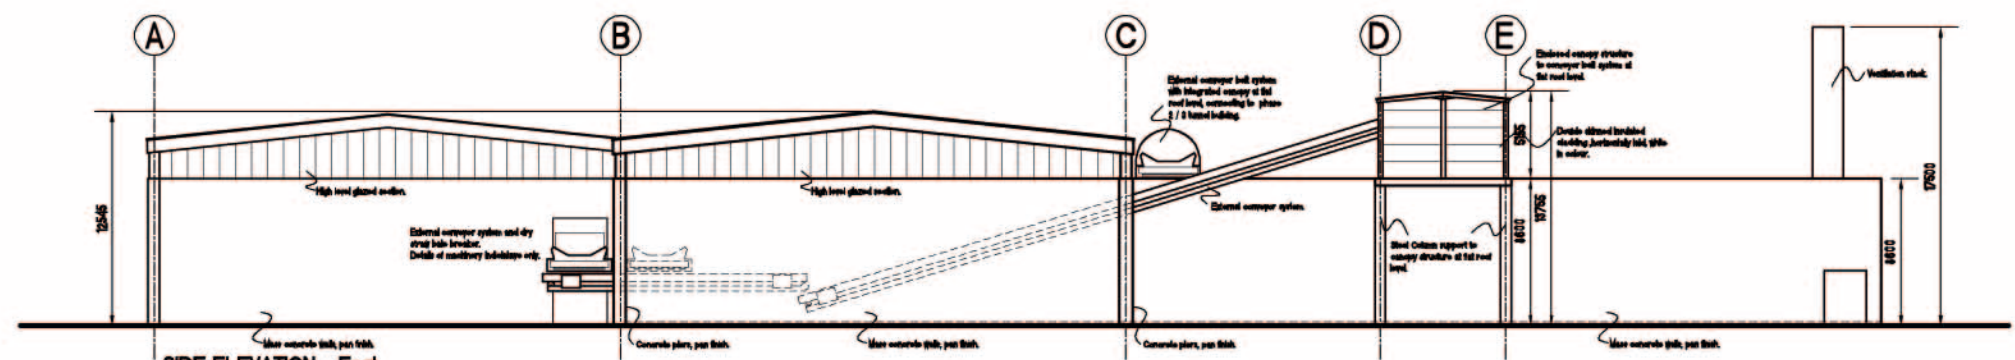
FRONT ELEVATION - North
Phase 1 Composting Facility
SCALE 1:200



FRONT ELEVATION - South
Phase 1 Composting Facility
SCALE 1:200



SIDE ELEVATION - West
Phase 1 Composting Facility
SCALE 1:200



SIDE ELEVATION - East
Phase 1 Composting Facility
SCALE 1:200

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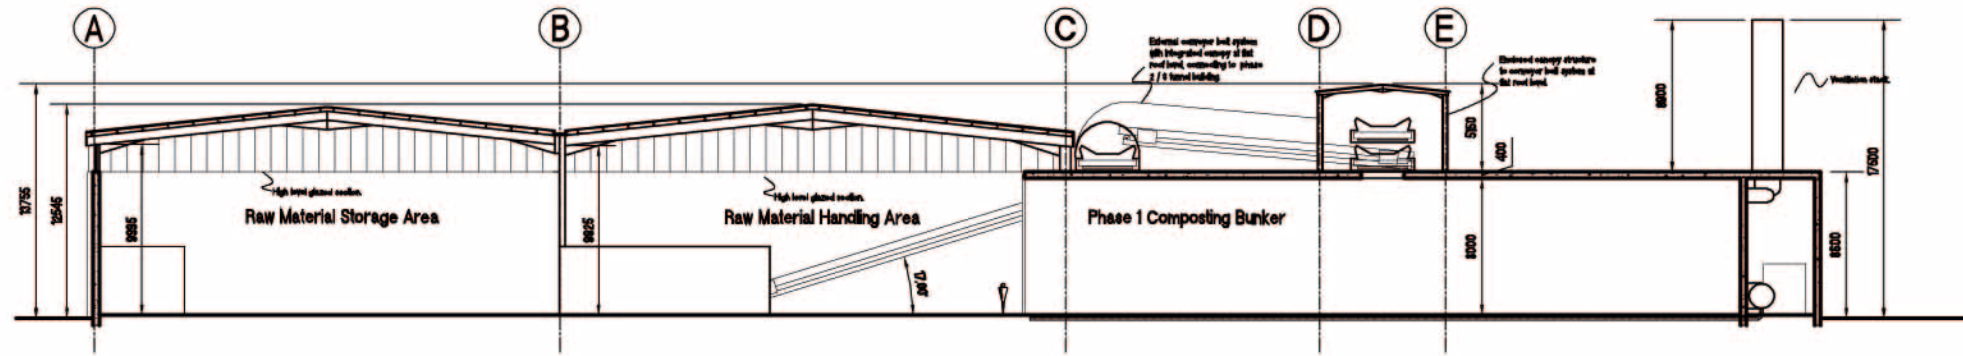
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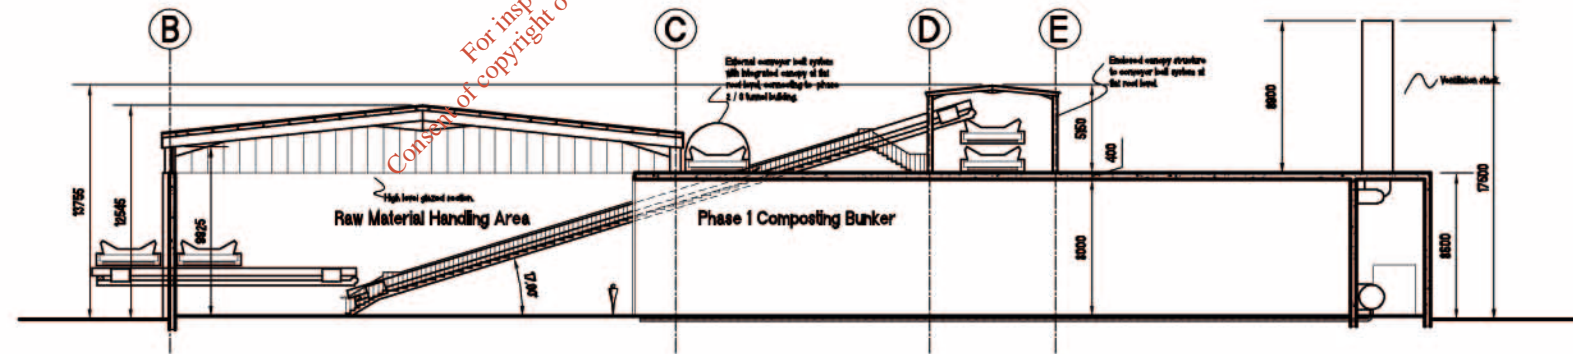
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Dwg. No.:	3154CPL-08-203
Rev. No.:	Bunker Building - Elevations

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SECTION A-A
Phase 1 Composting Facility
SCALE 1:200



SECTION B-B
Phase 1 Composting Facility
SCALE 1:200

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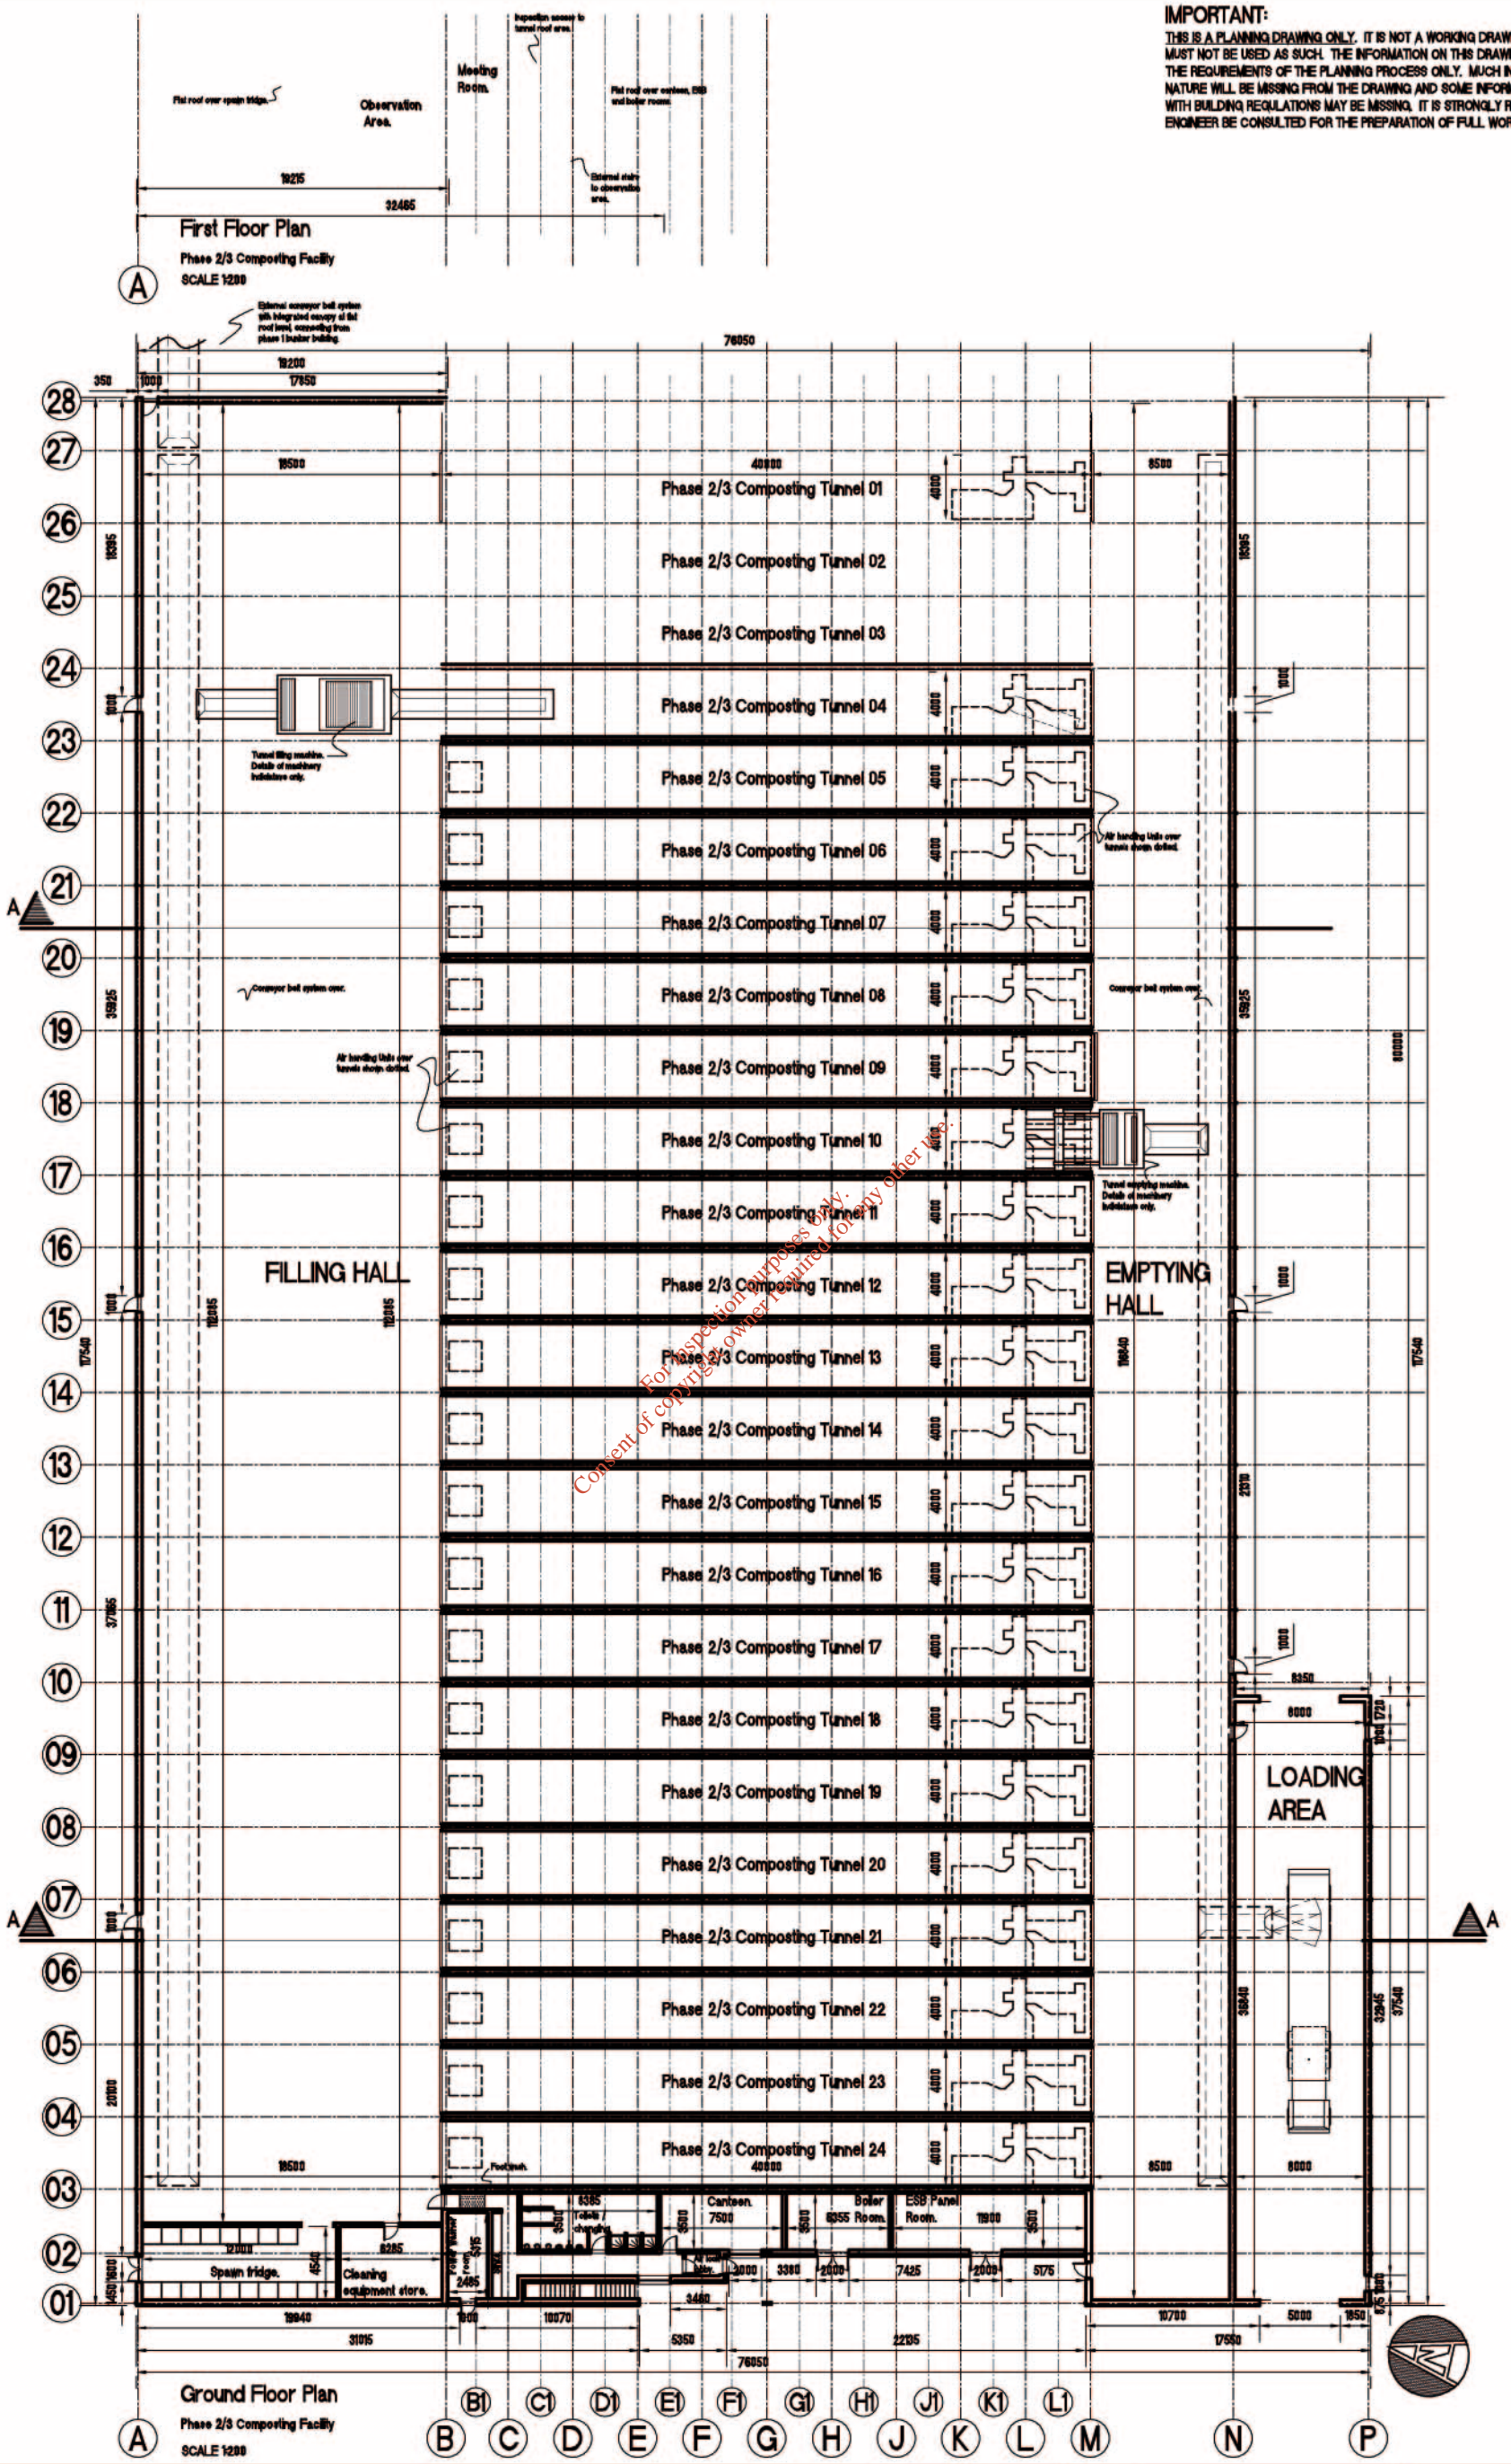
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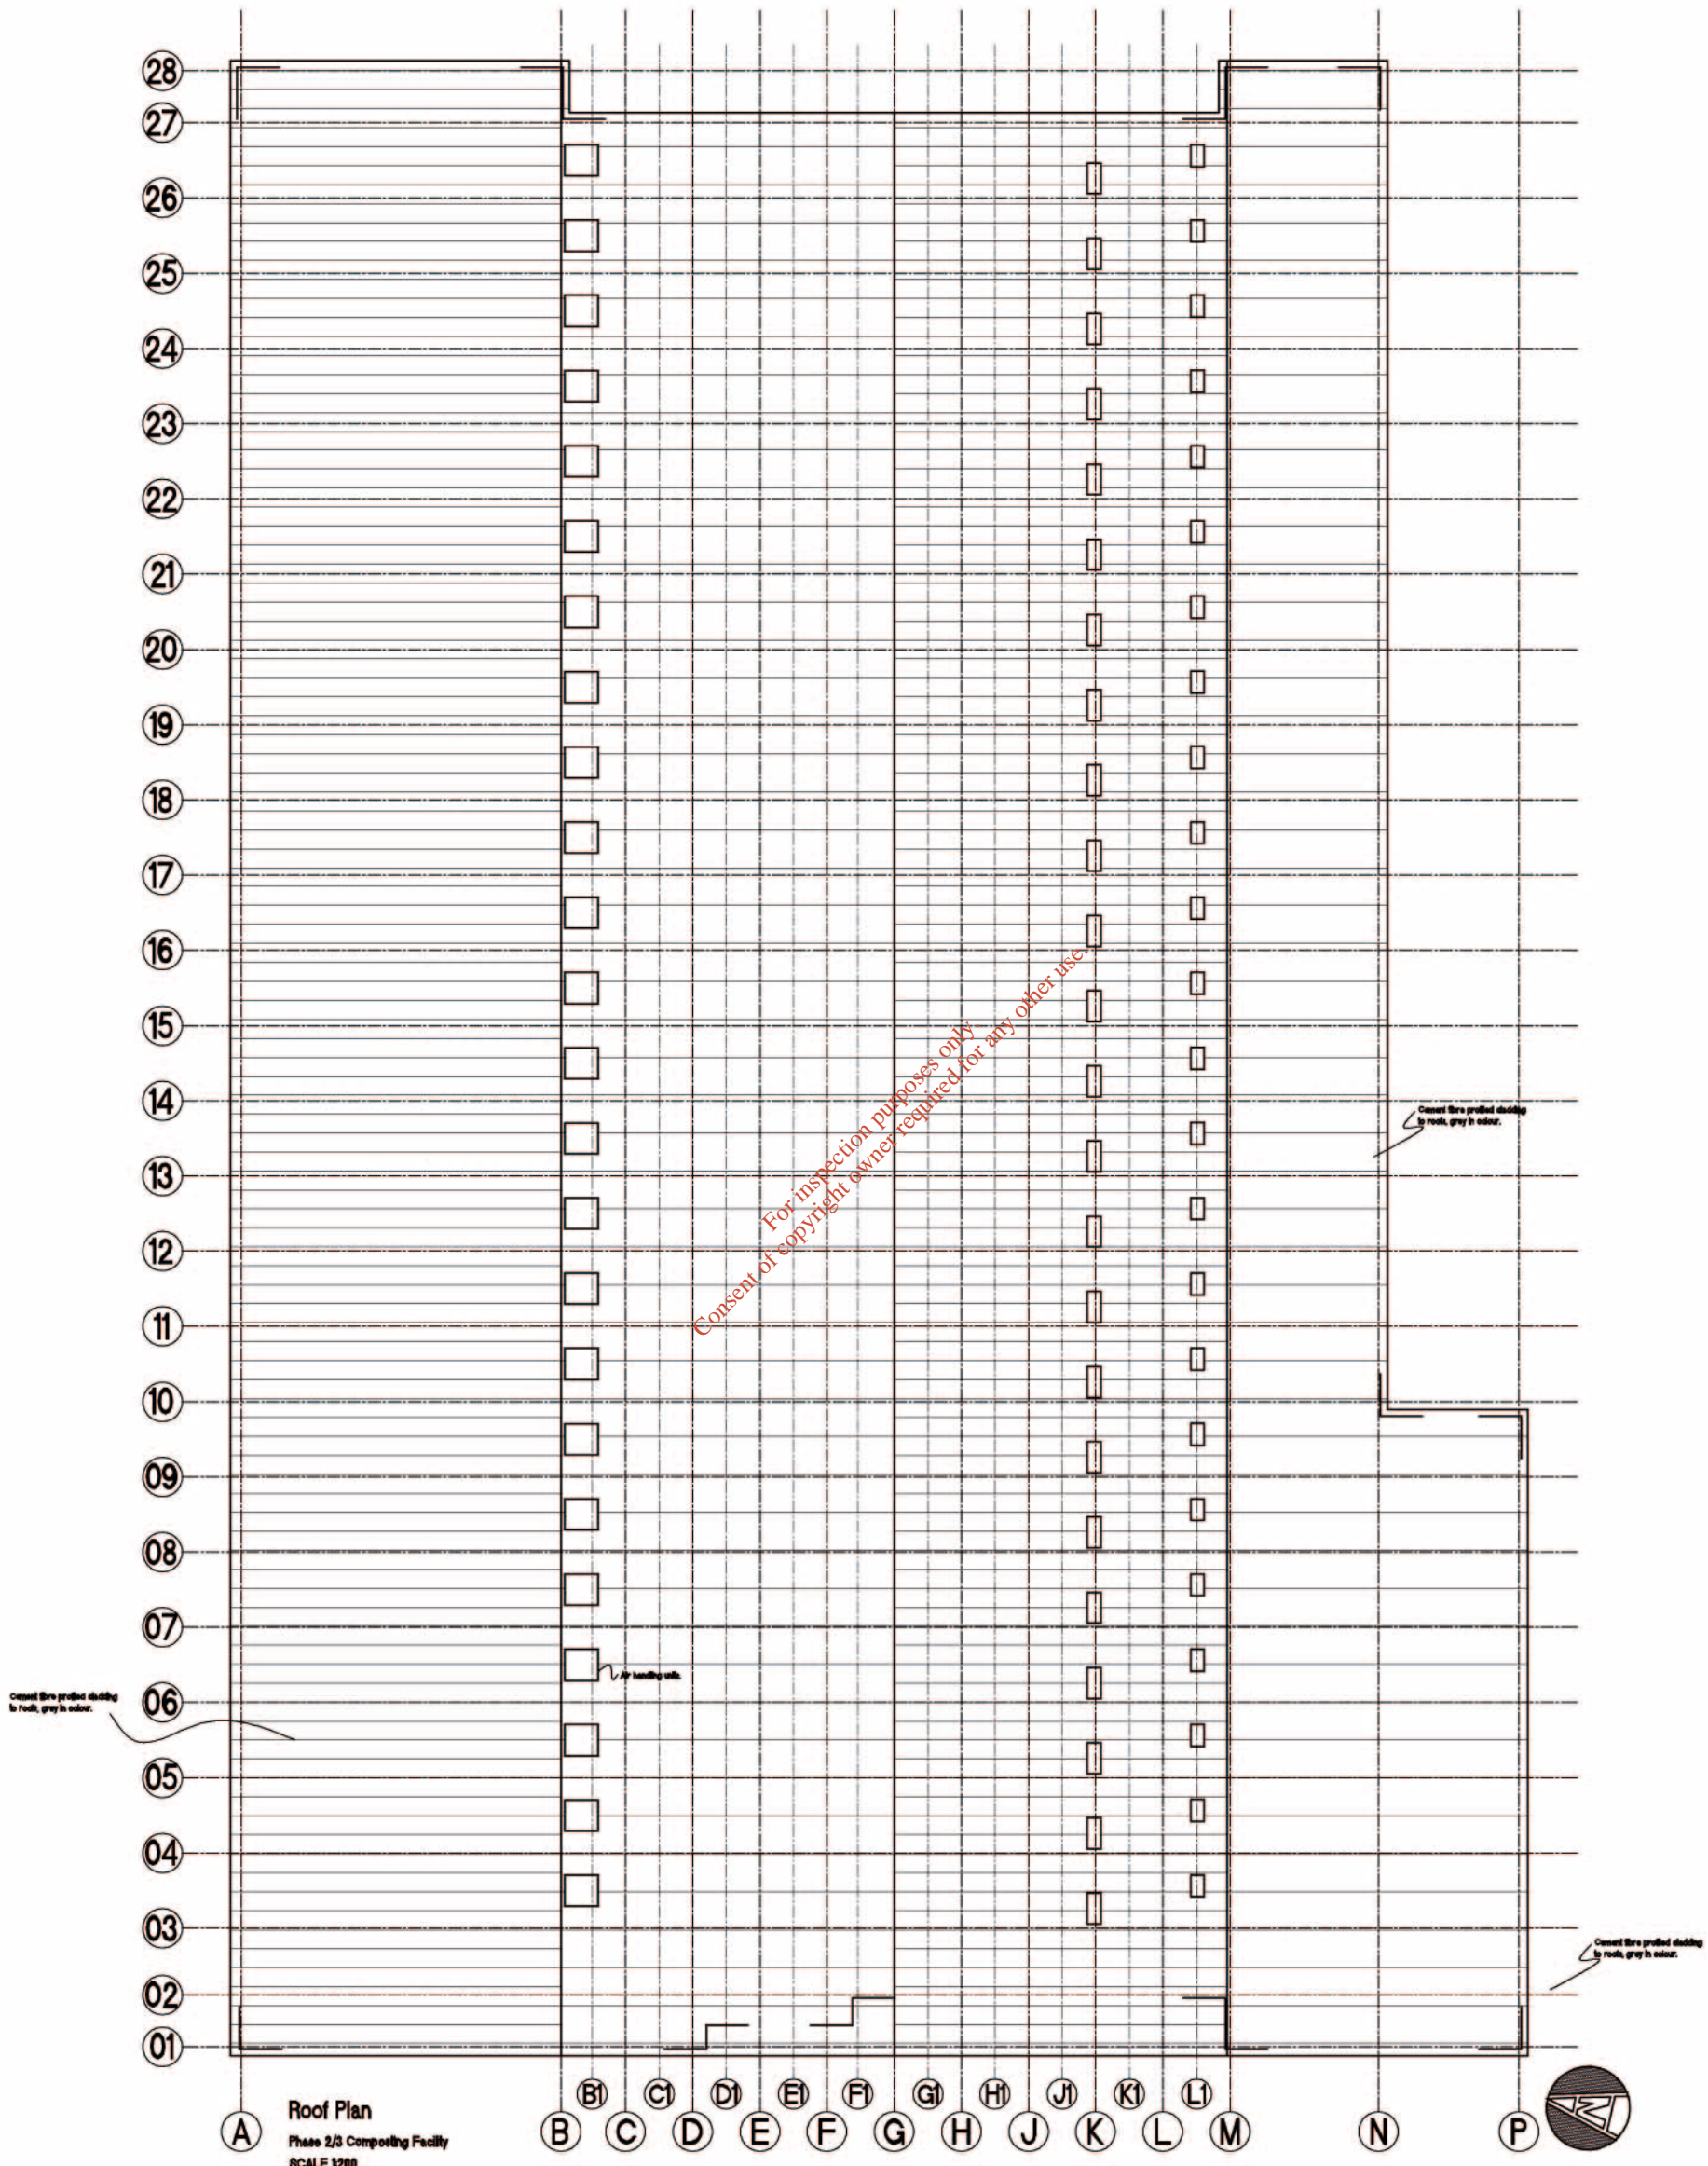
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3154CPL-06-001
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Roof Plan
Phase 2/3 Composting Facility
SCALE 1:200

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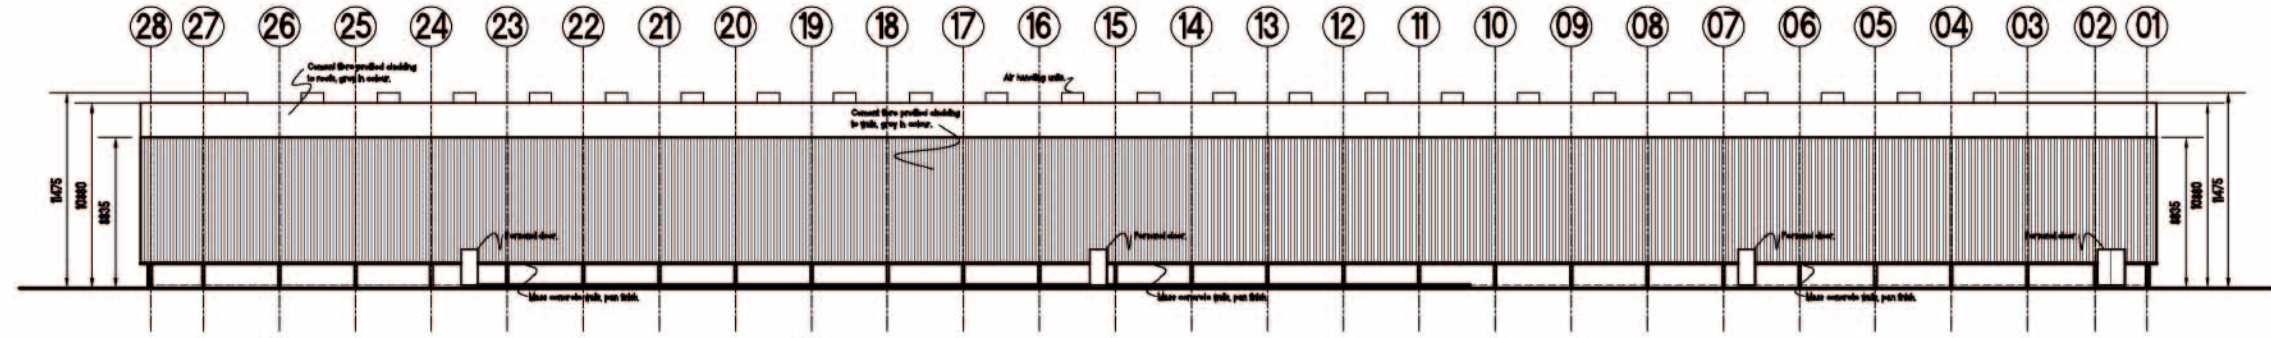
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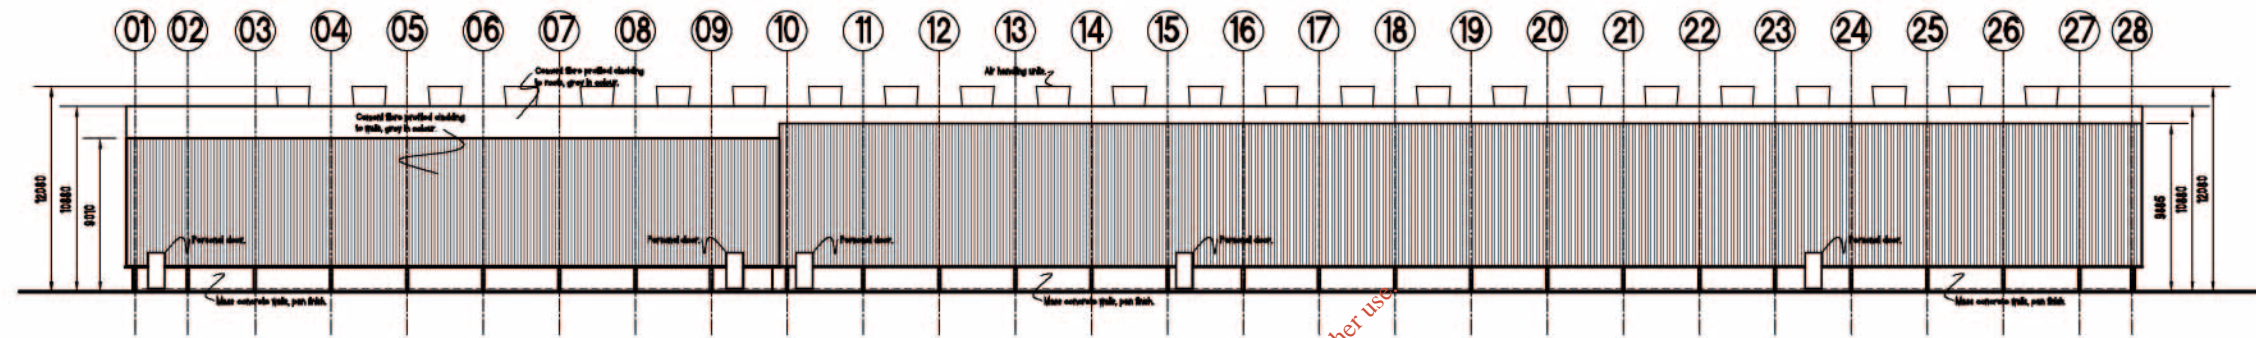
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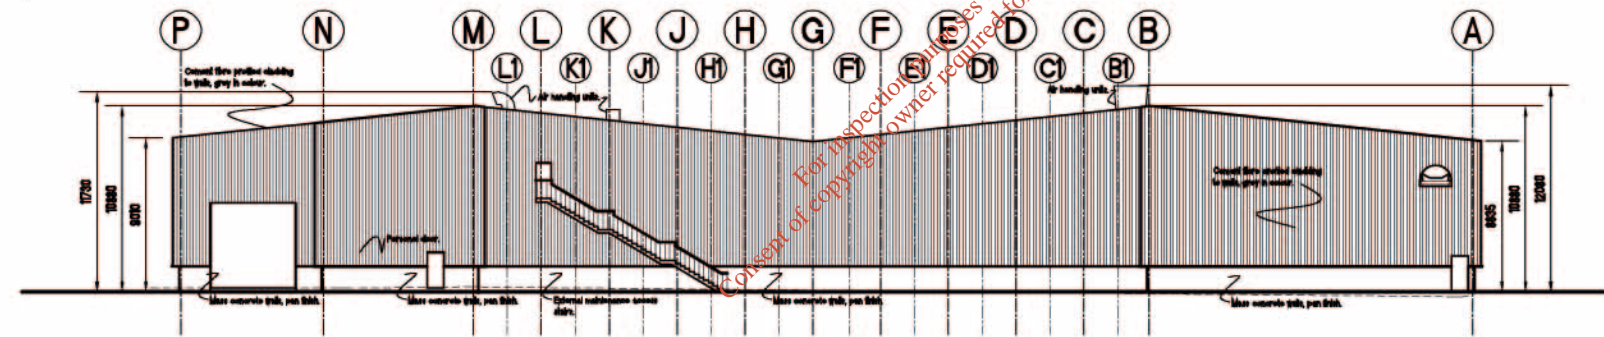
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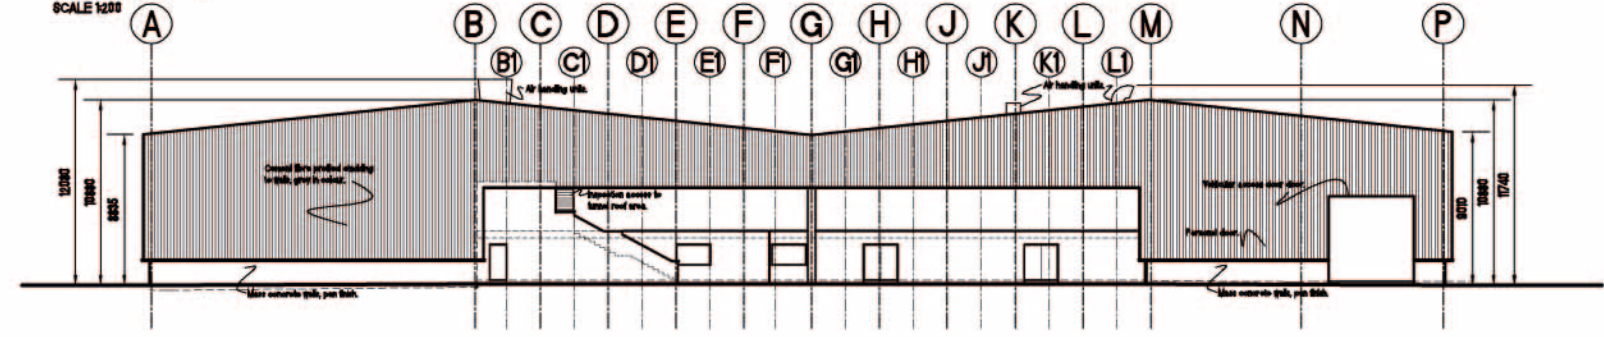
FRONT ELEVATION - North
Phase 2/3 Composting Facility
SCALE 1:200



FRONT ELEVATION - South
Phase 2/3 Composting Facility
SCALE 1:200



FRONT ELEVATION - West
Phase 2/3 Composting Facility
SCALE 1:200



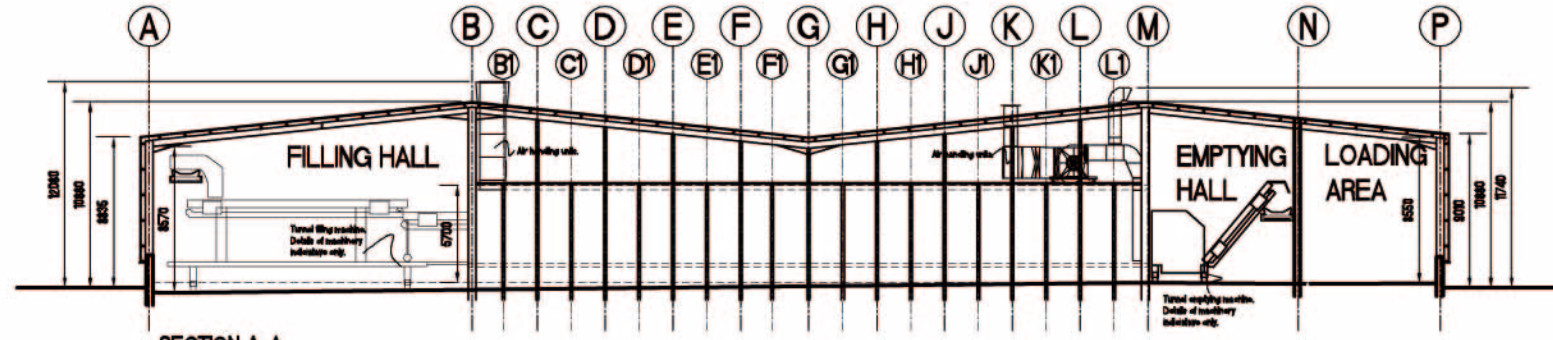
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Phase 2/3 Composting Facility
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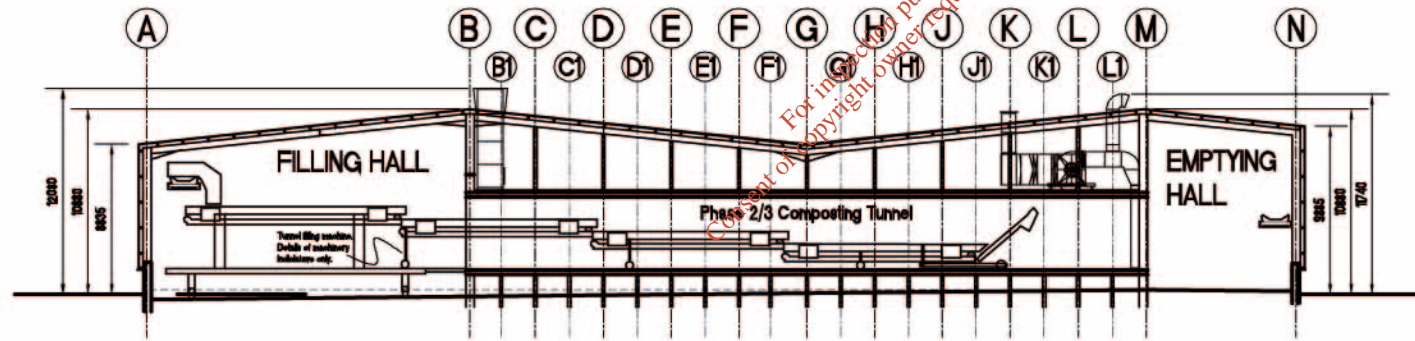
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SECTION A-A
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SECTION B-B
Phase 2/3 Composting Facility
SCALE 1:200

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