

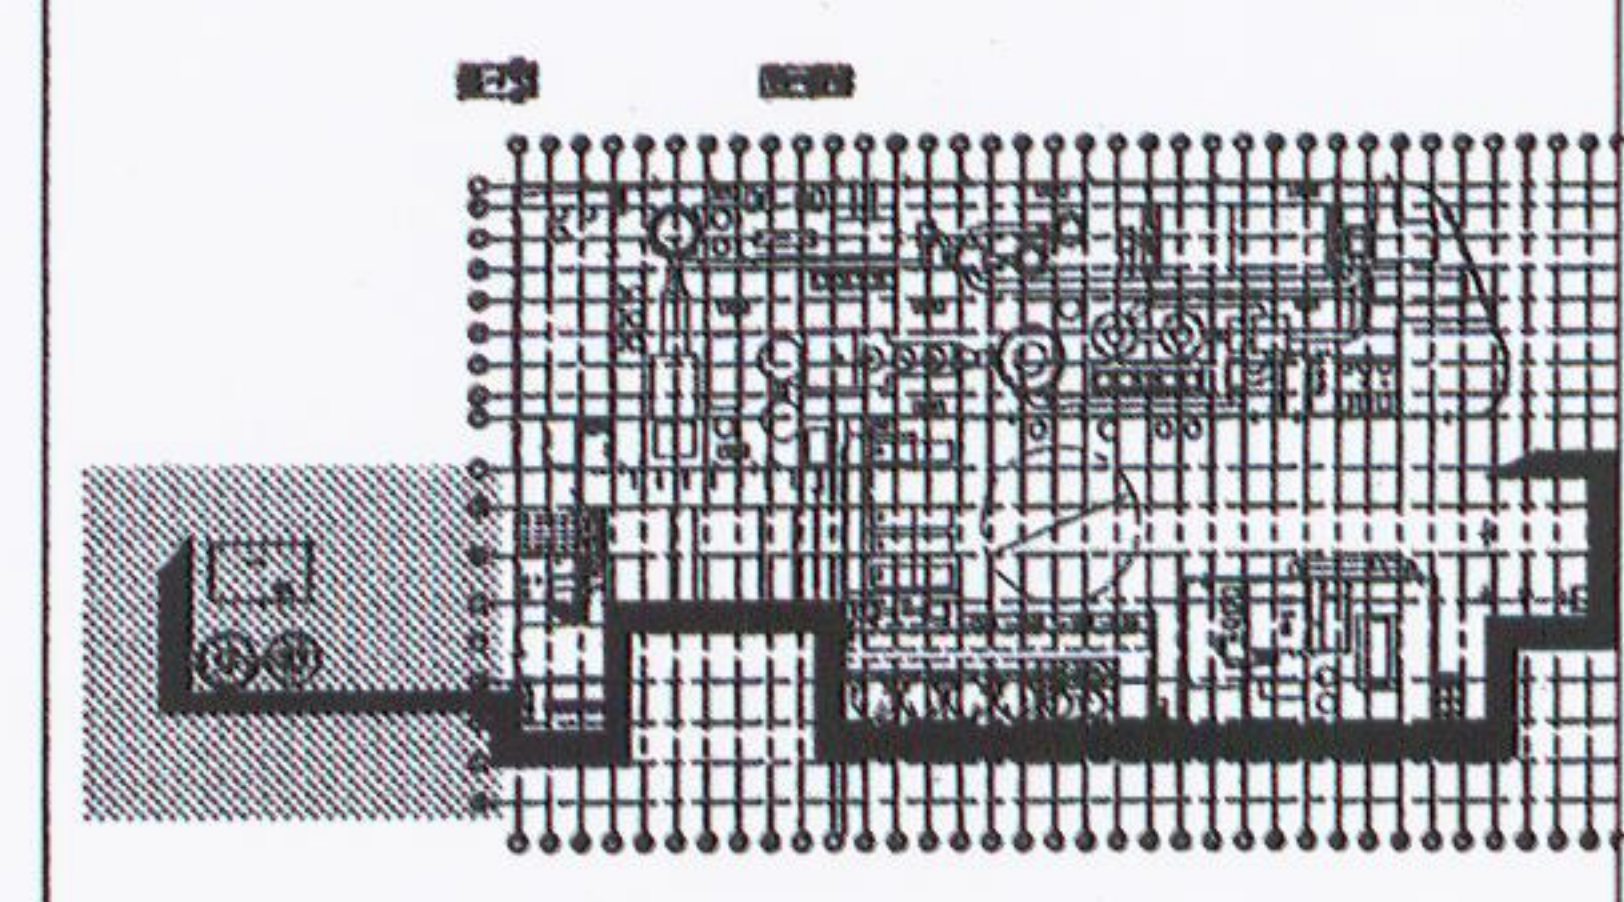


NOTES

1. THIS DRAWING TO BE READ IN CONJUNCTION WITH ALL RELEVANT ARCHITECTS AND ENGINEERS DRAWINGS AND SPECIFICATIONS
2. DO NOT SCALE - USE FIGURED DIMENSIONS ONLY
3. LEVELS ARE GIVEN IN METRES AND RELATE TO O.S. DATUM (BATH HEARS) 0.00
4. ALL DIMENSIONS ARE GIVEN IN METRES
5. ALL DIMENSIONS TO BE CHECKED ON SITE

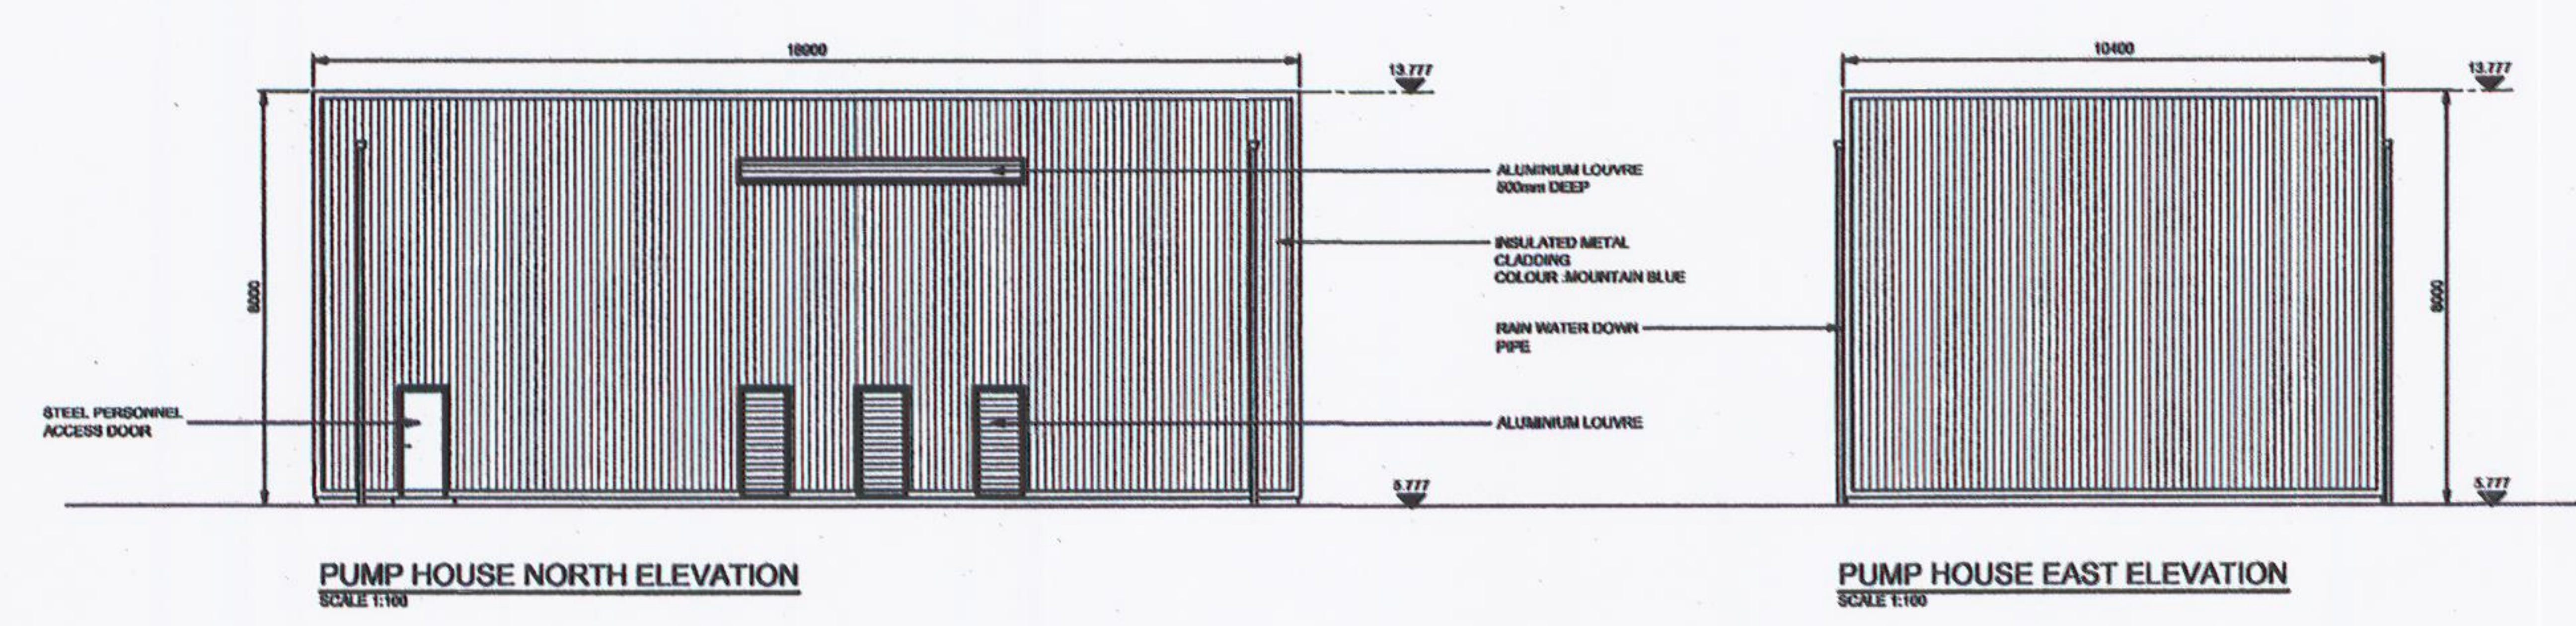


NOTE - ELEVATIONAL PATTERN SHOWN IS INDICATIVE OF EFFECT. FINAL LAYOUT TO BE AGREED WITH PLANNING AUTHORITY

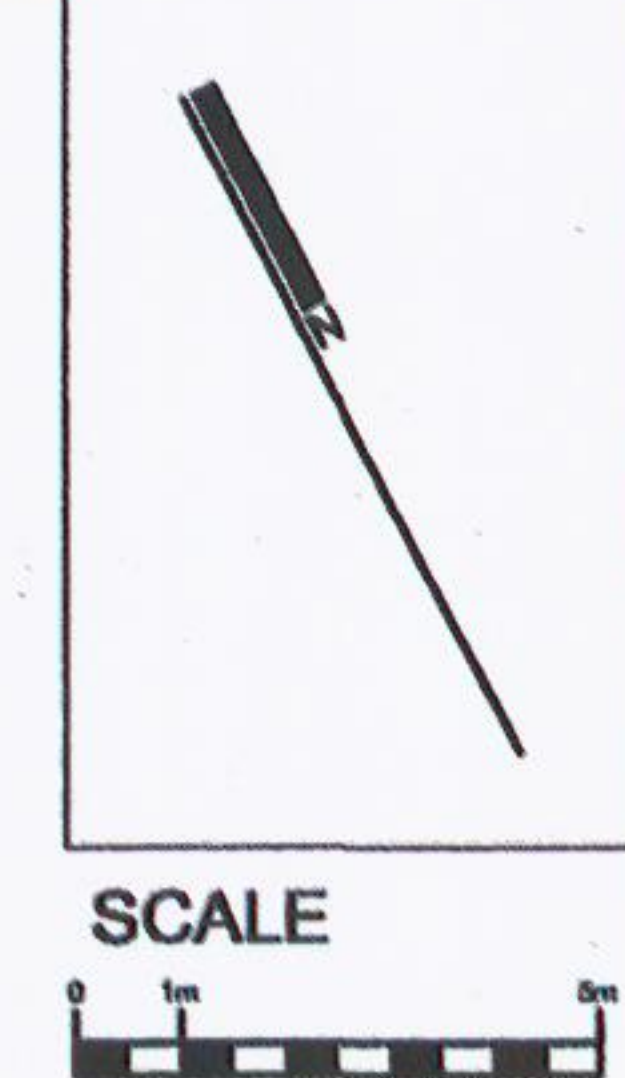


PUMP HOUSE NORTH ELEVATION
SCALE 1:100

PUMP HOUSE EAST ELEVATION
SCALE 1:100

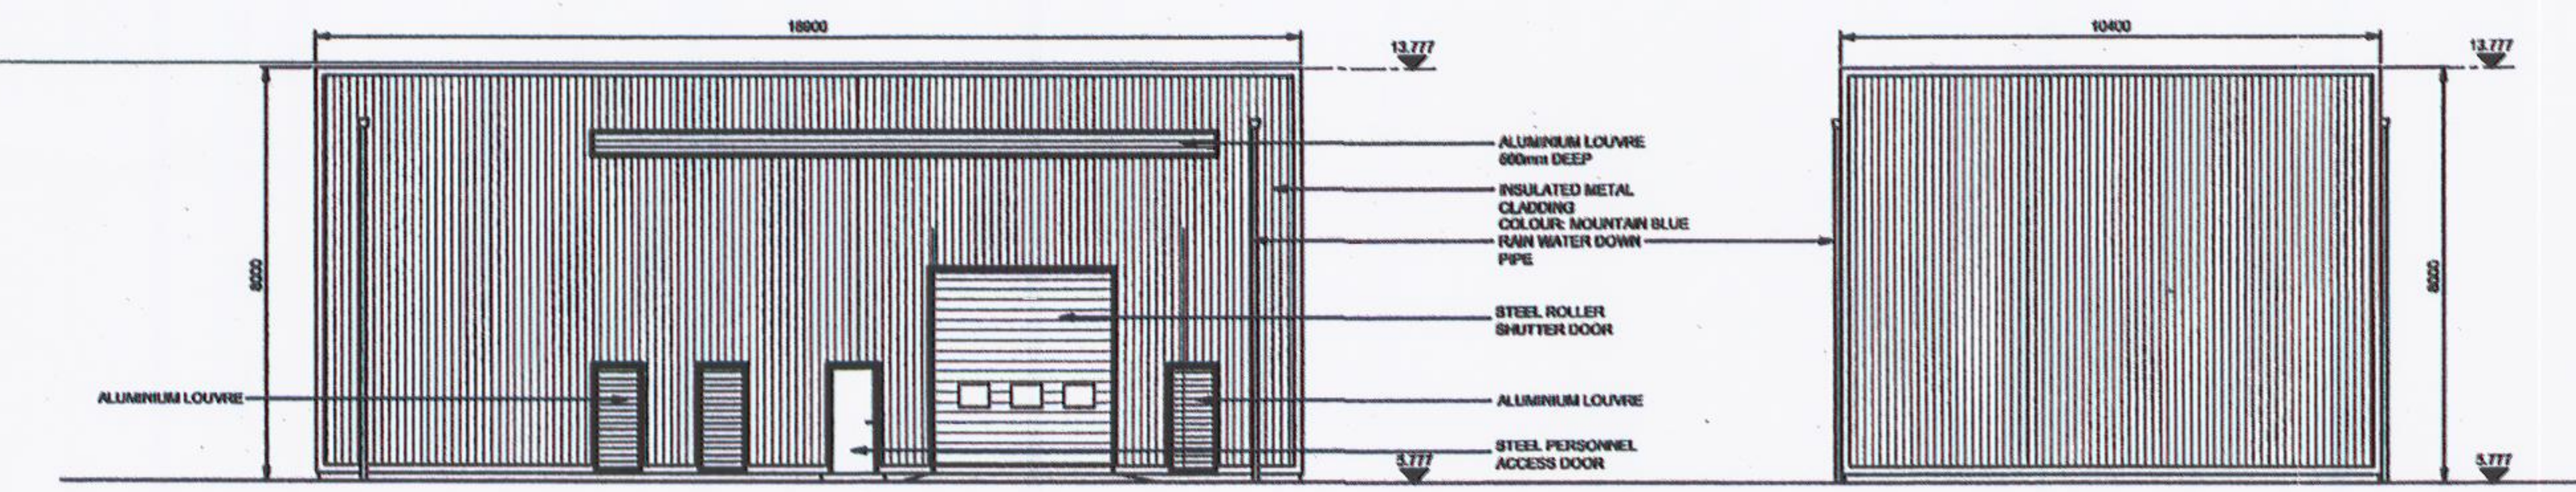


PUMP HOUSE SOUTH ELEVATION
SCALE 1:100


PUMP HOUSE WEST ELEVATION
SCALE 1:100

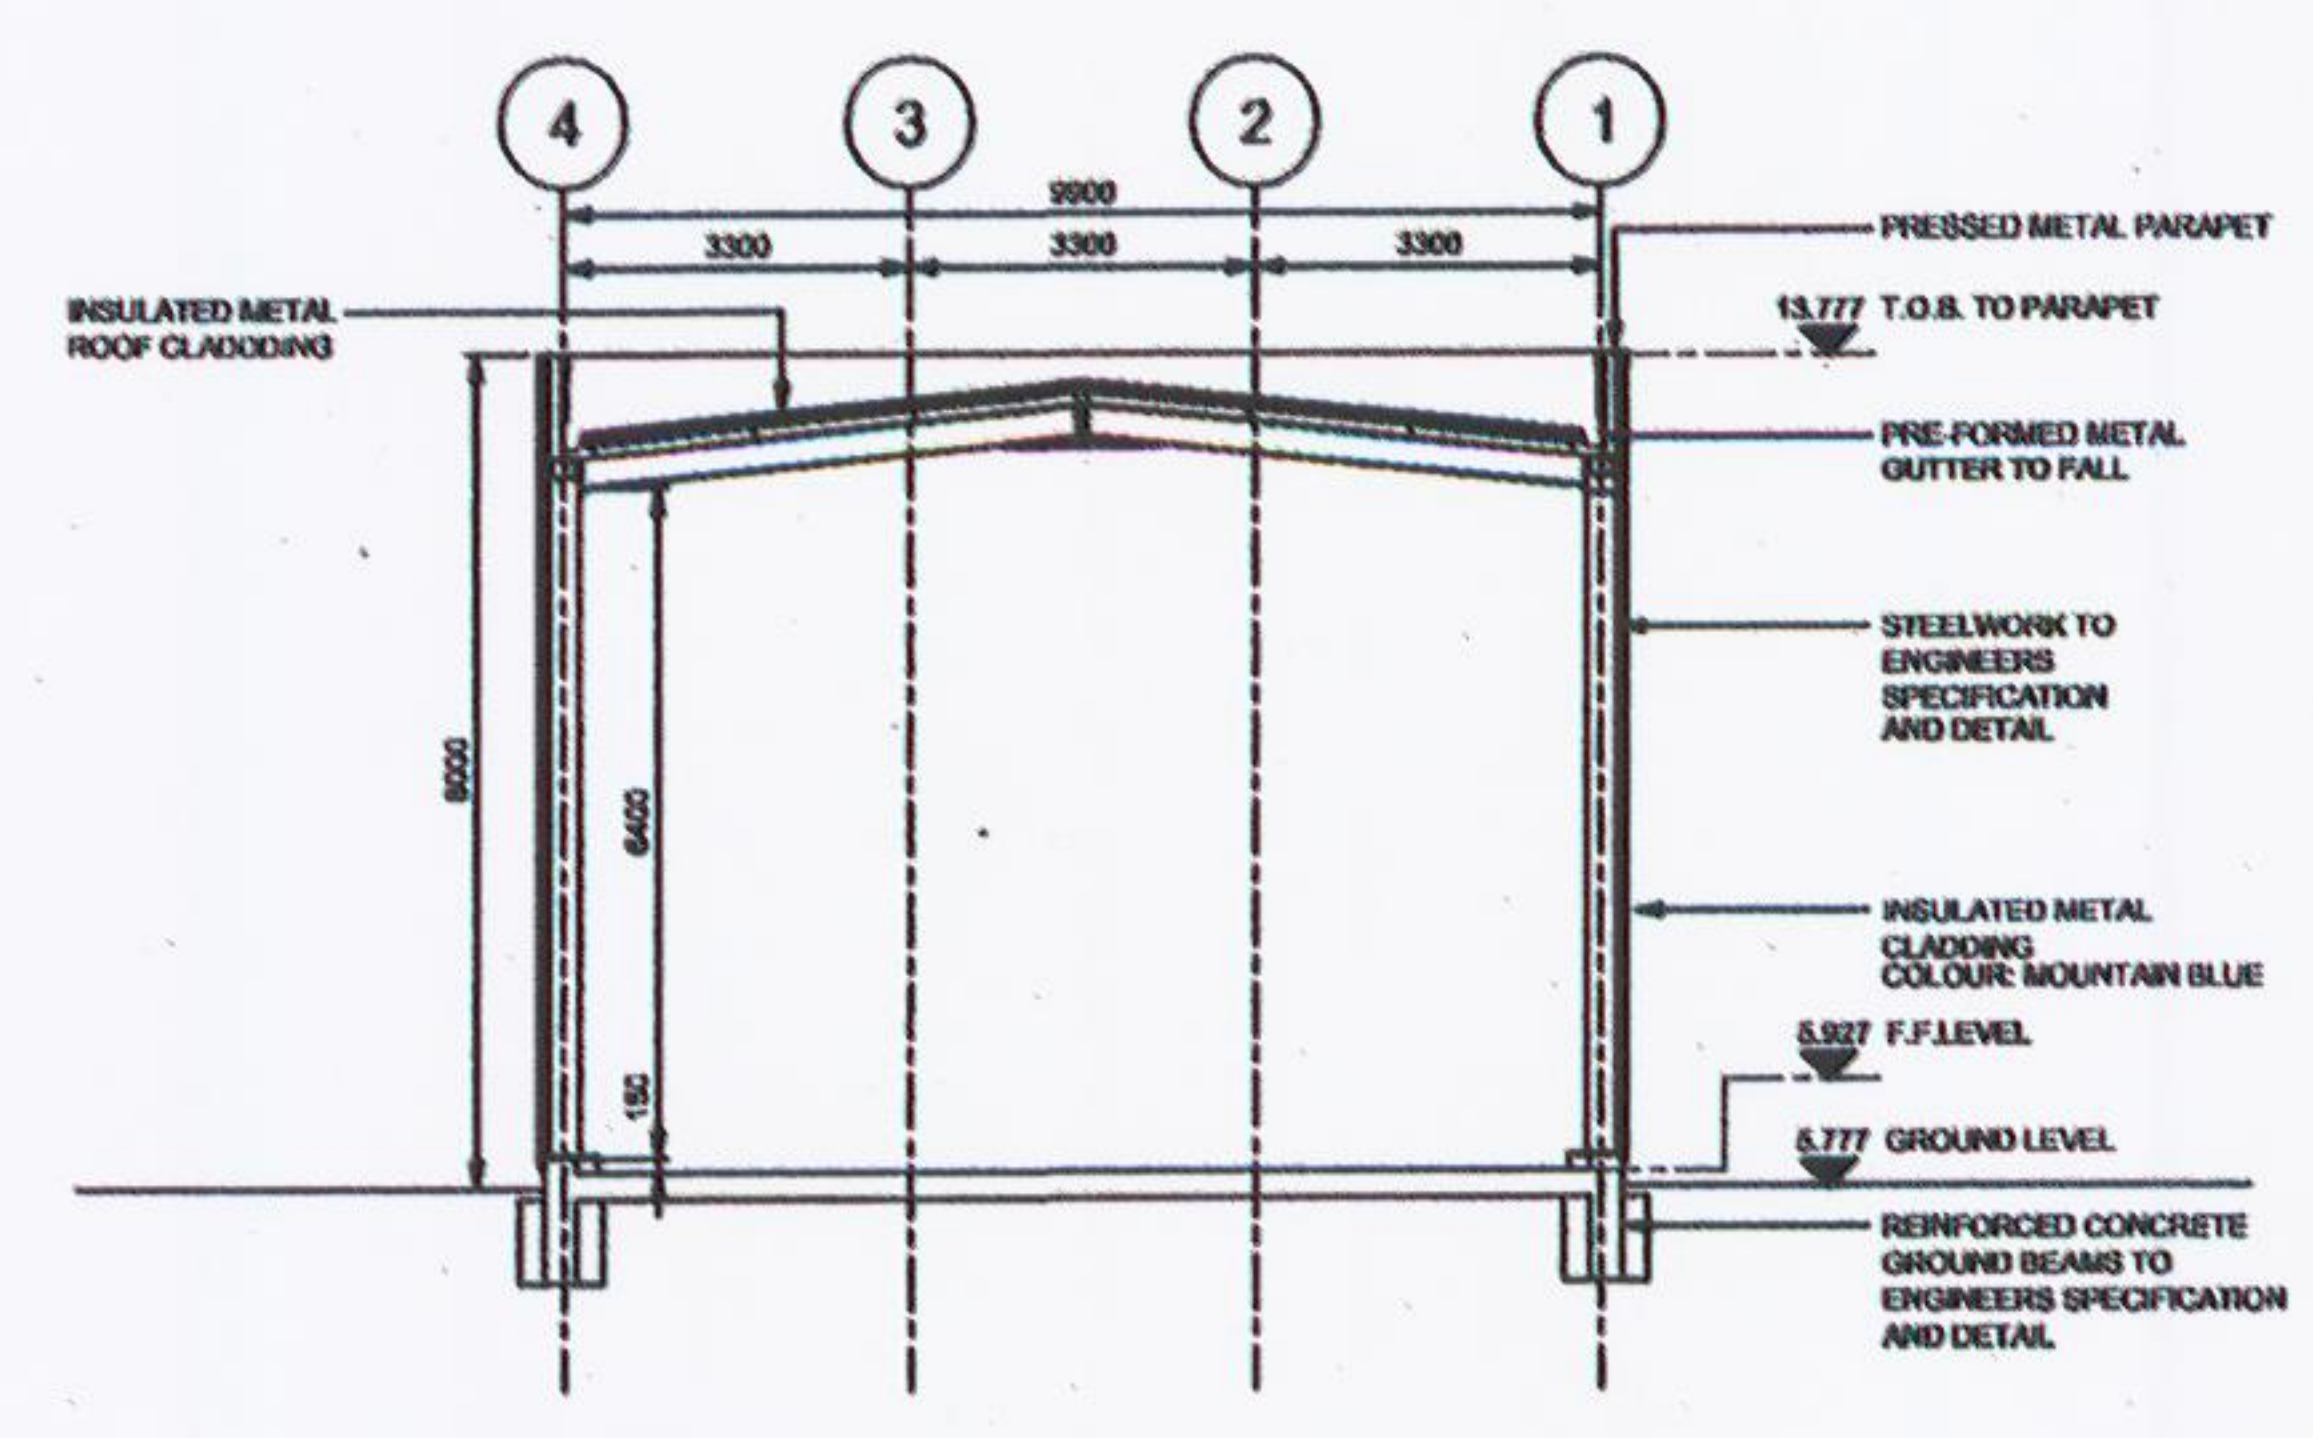


CROSS SECTION A
SCALE 1:100

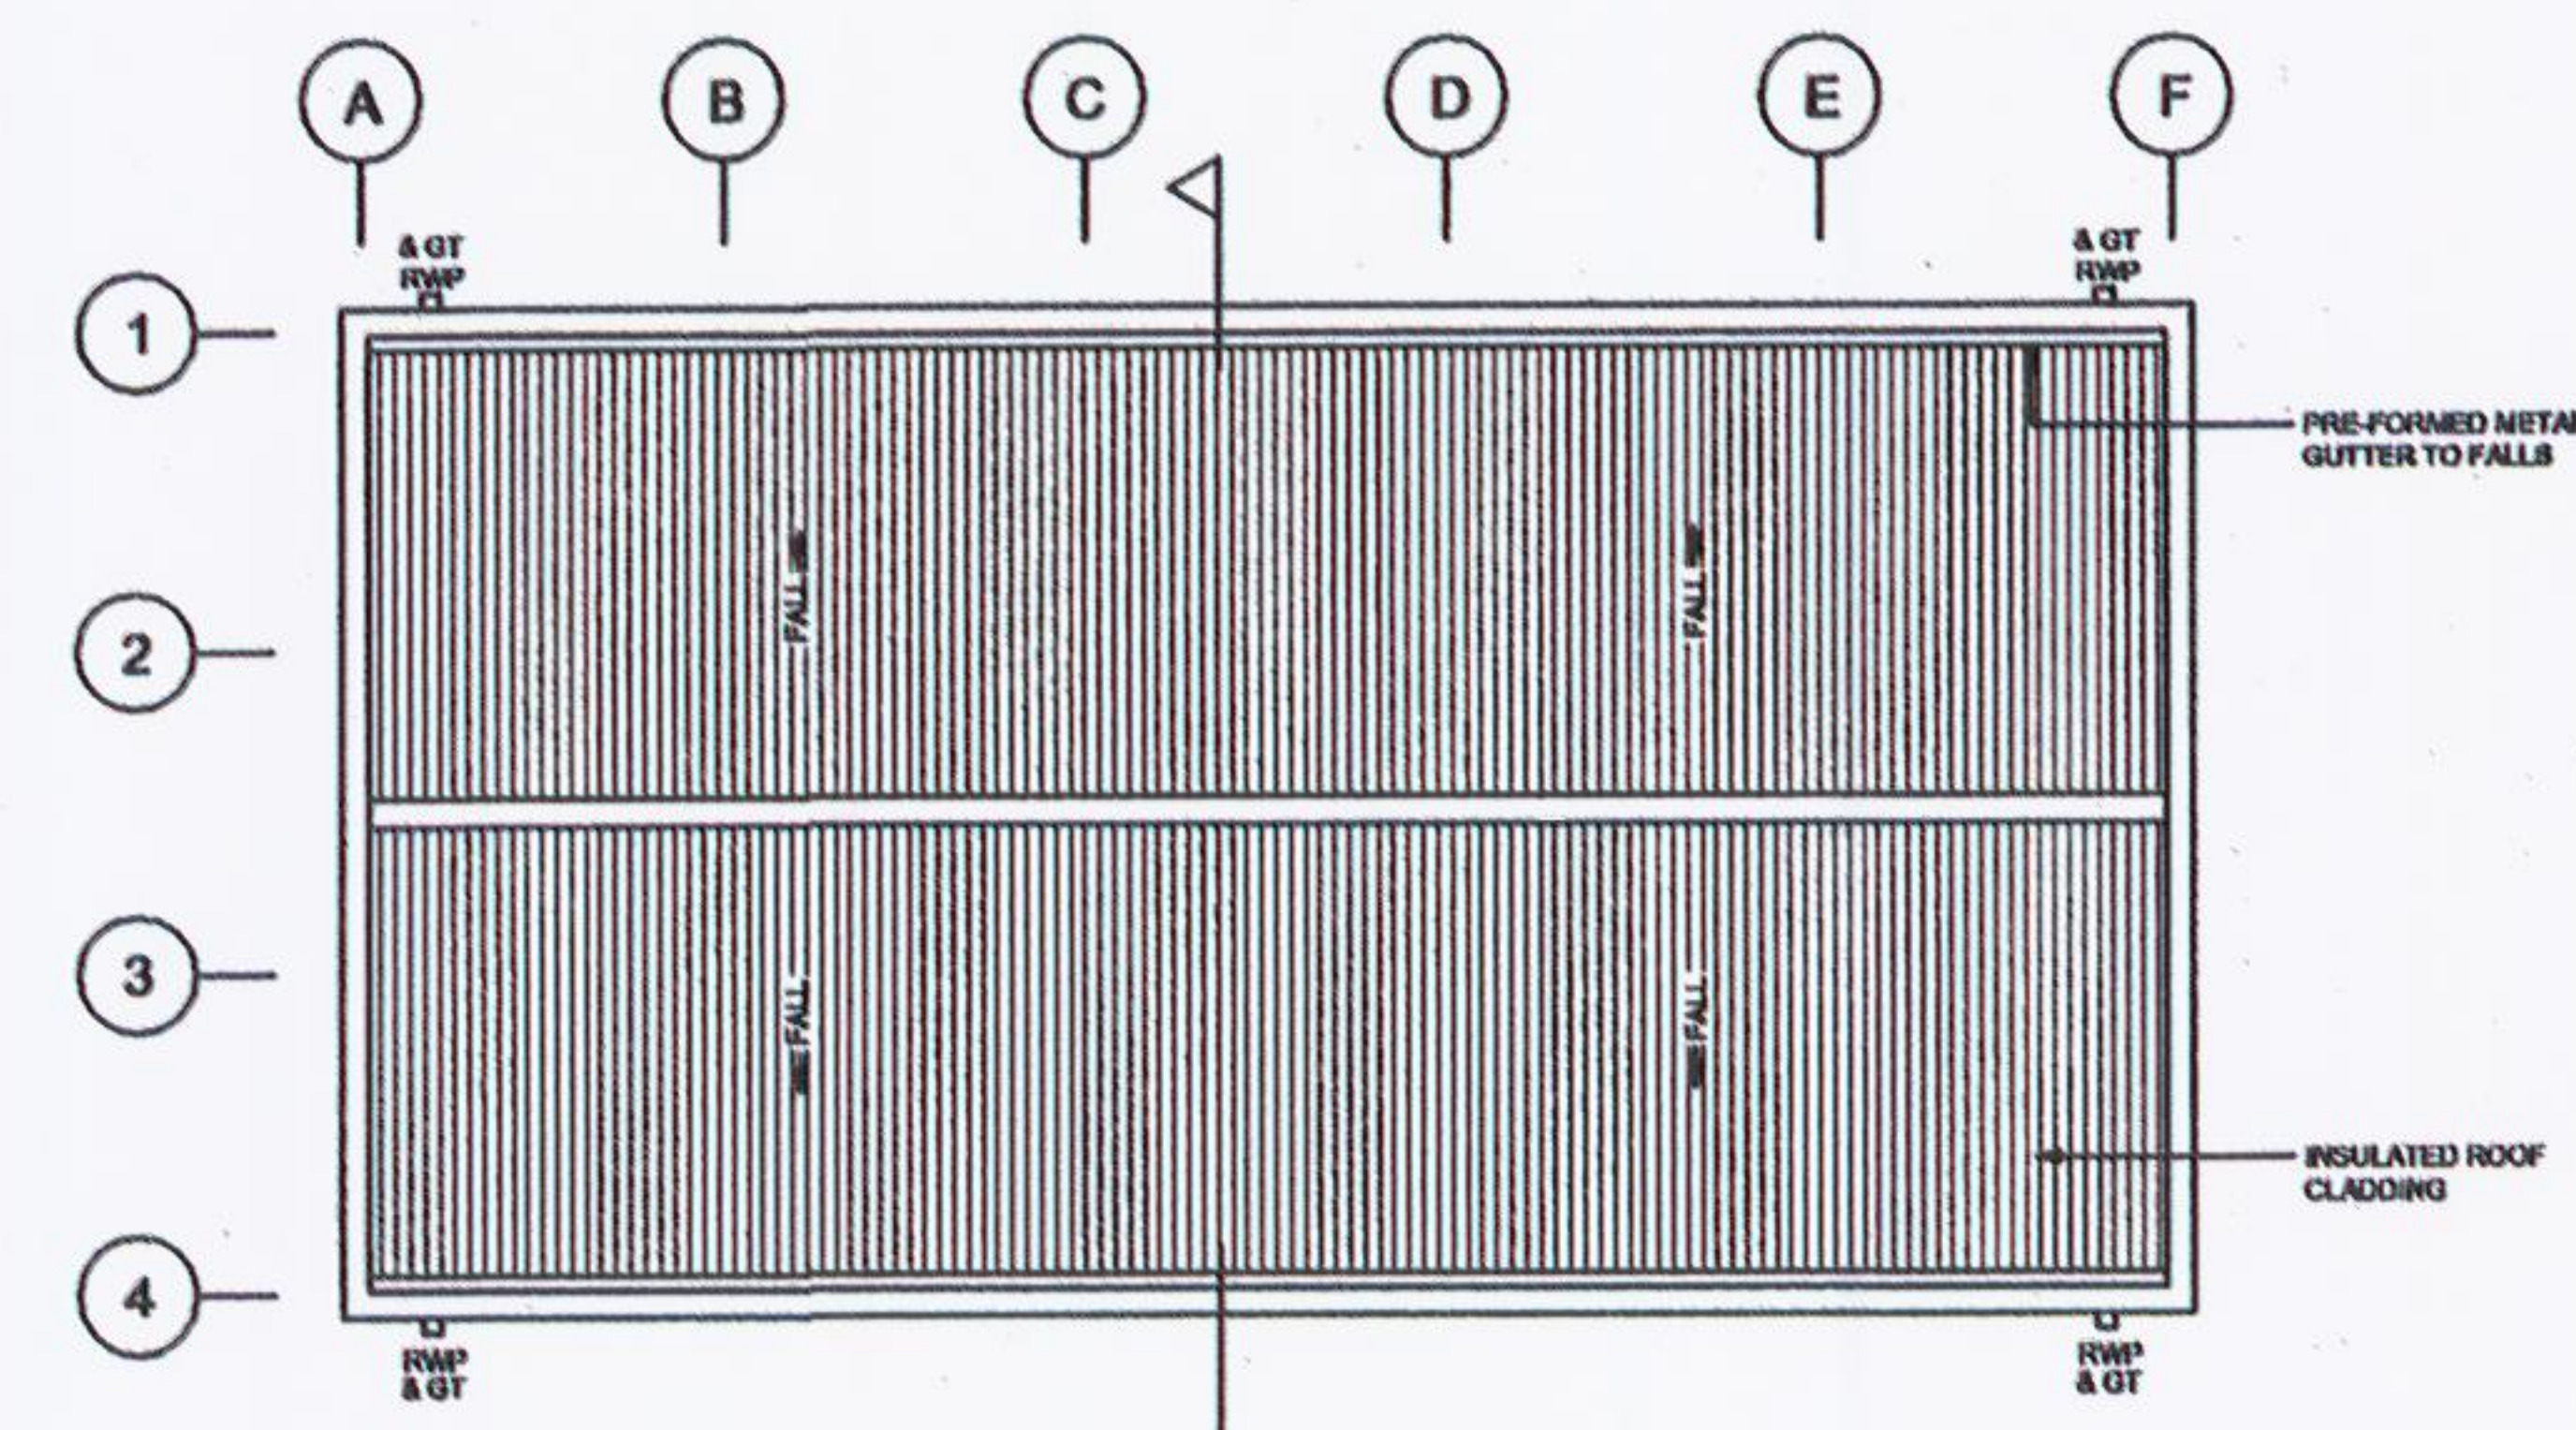

PUMP HOUSE ROOF PLAN
SCALE 1:100

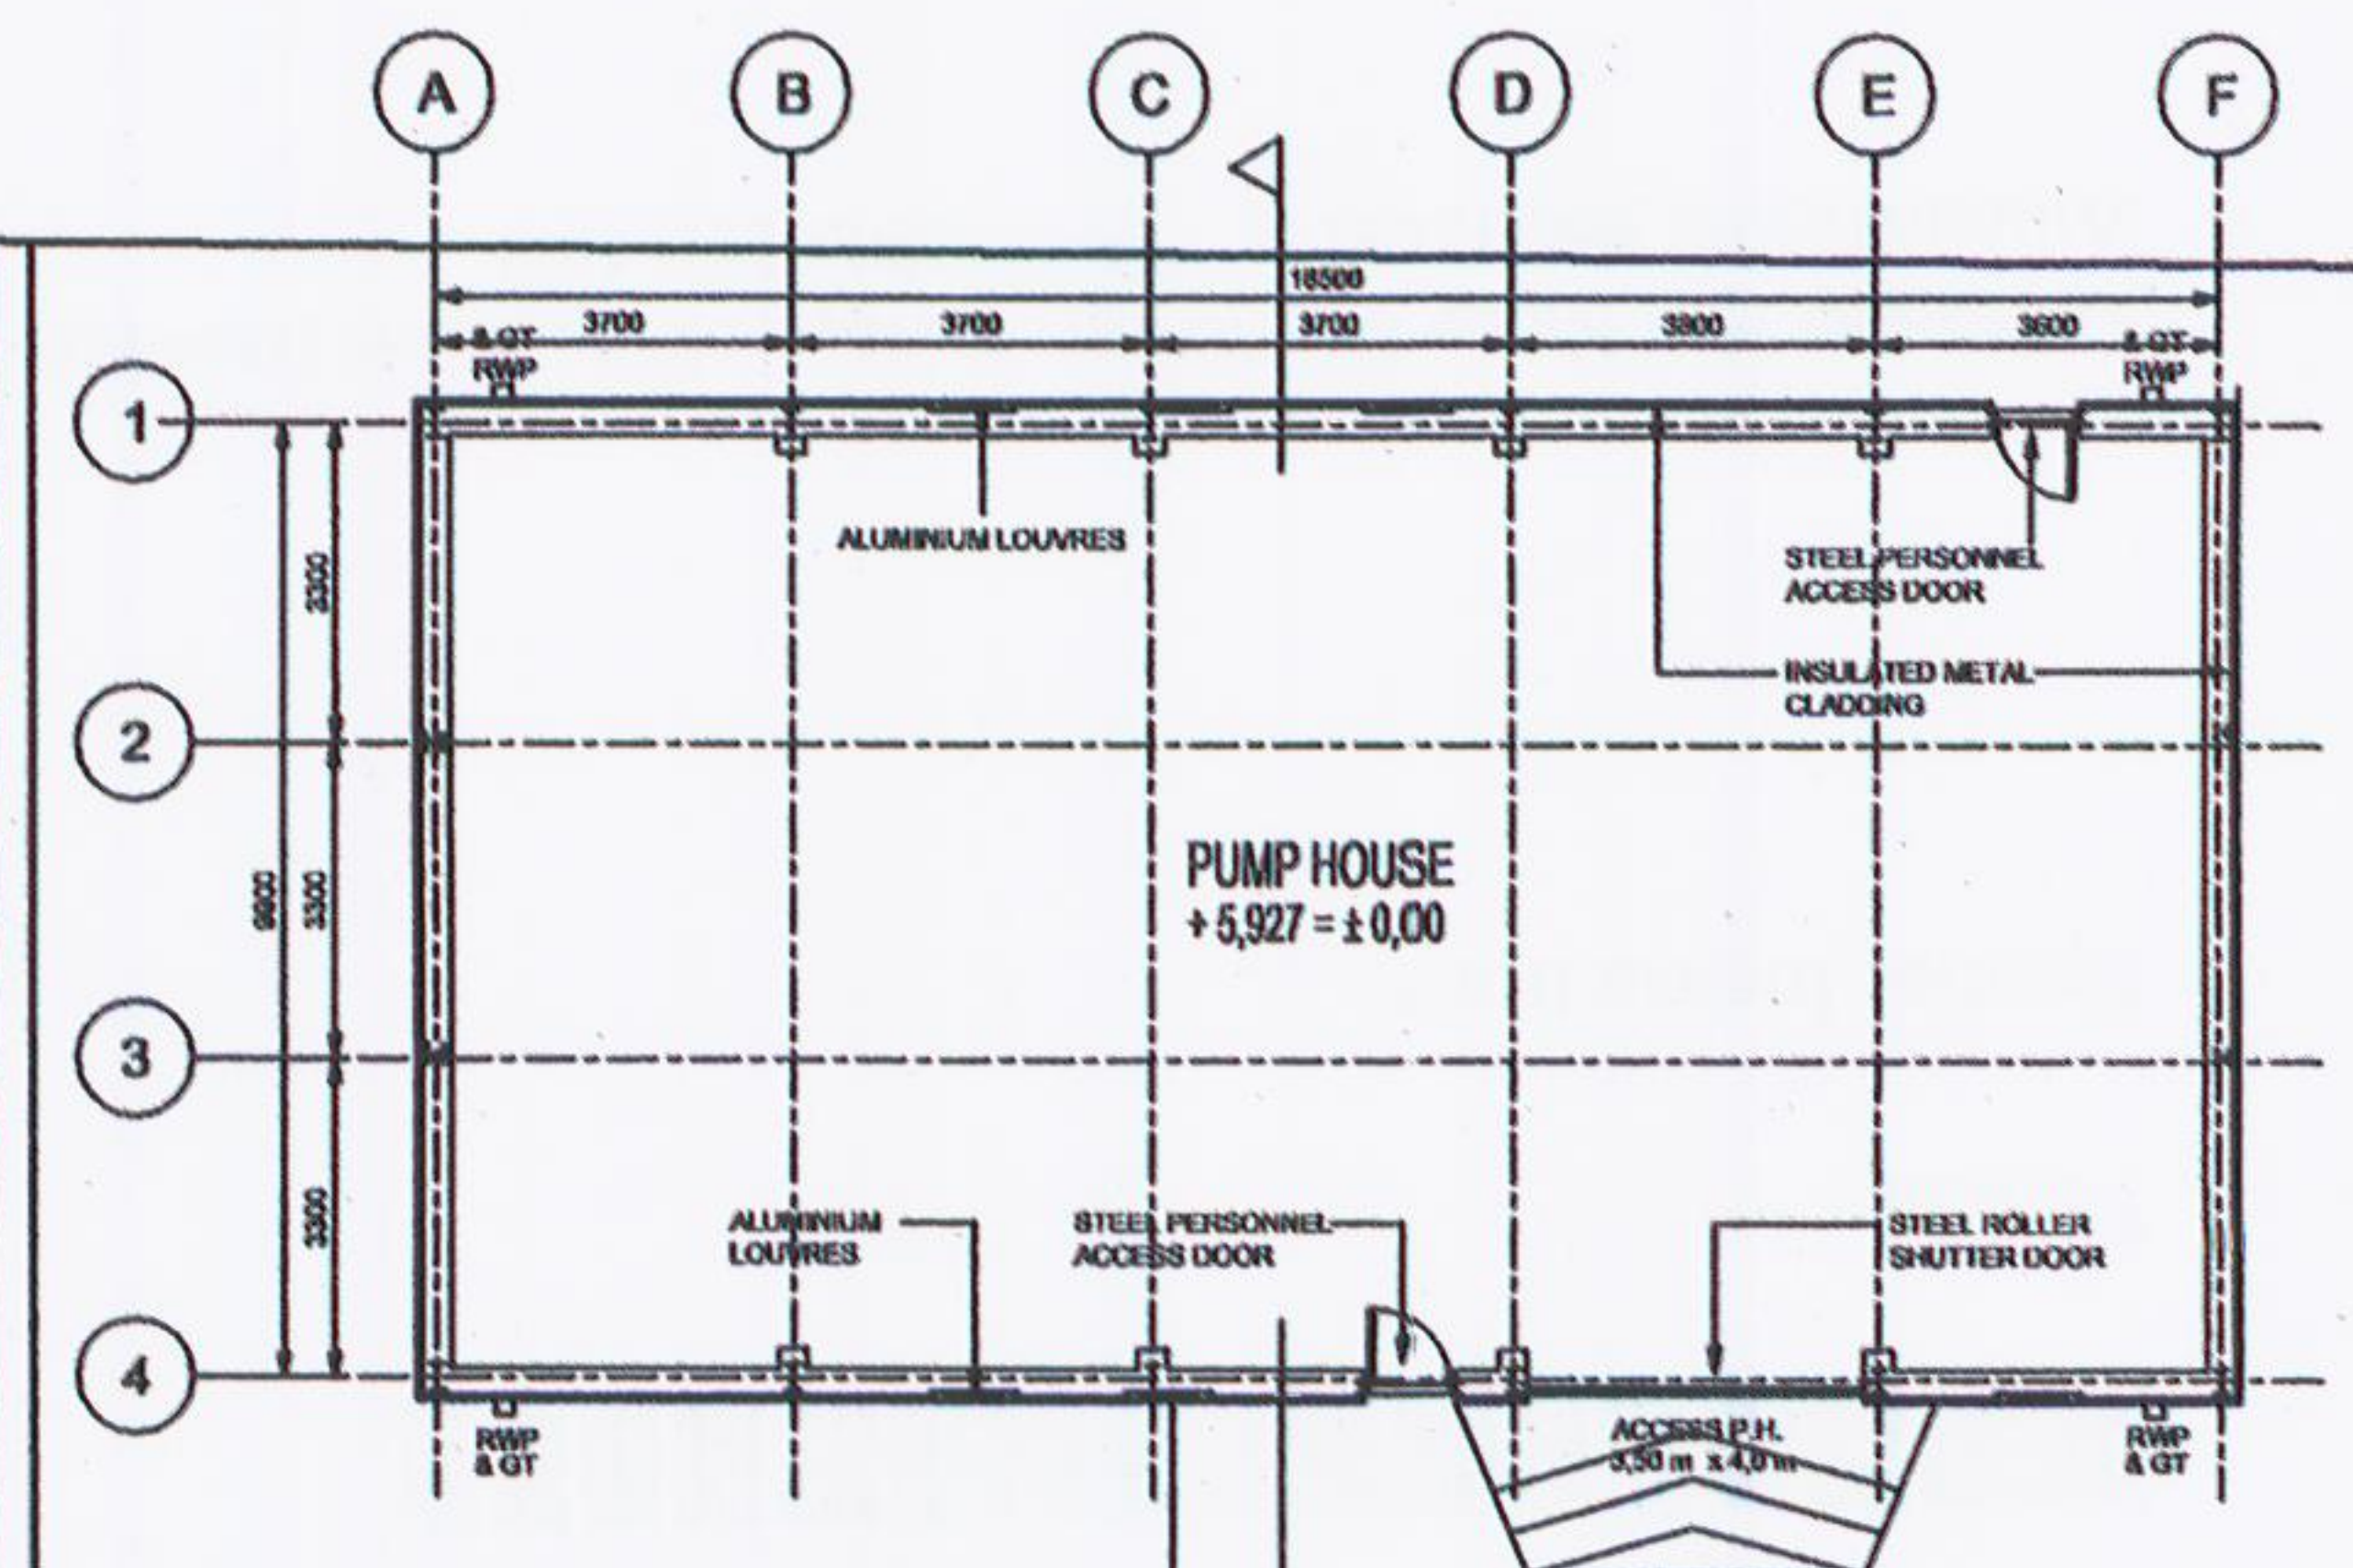


PUMP HOUSE FLOOR PLAN
SCALE 1:100

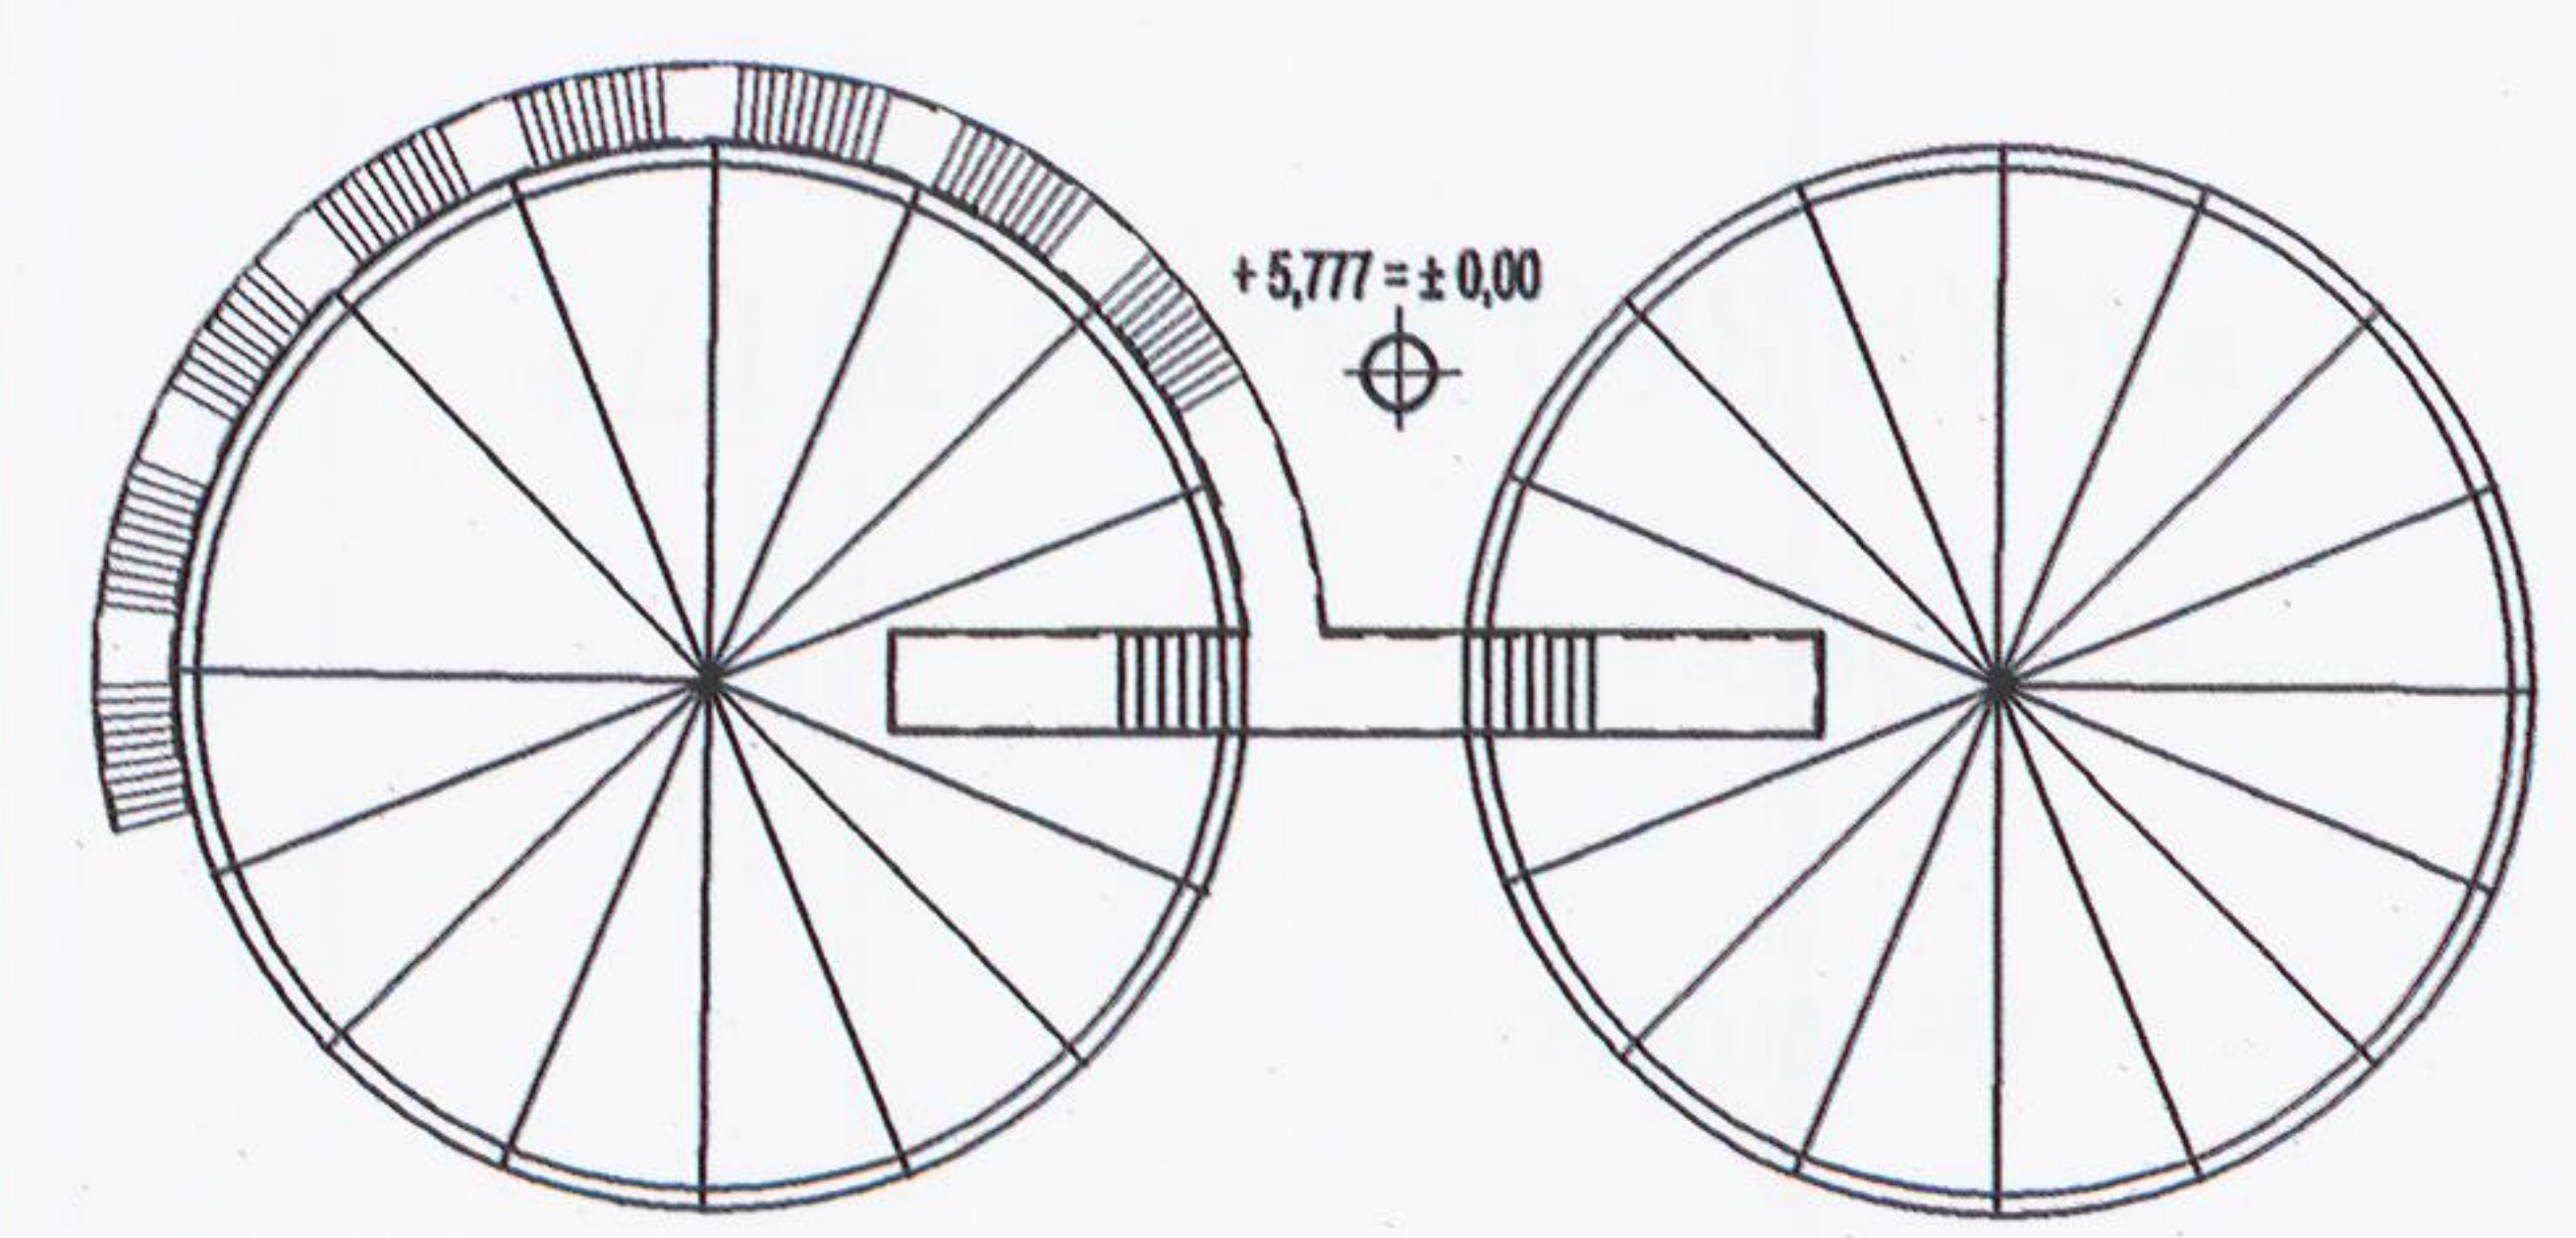

± 5.777 ± 0.00

FIRE ACCESS TURNING AREA

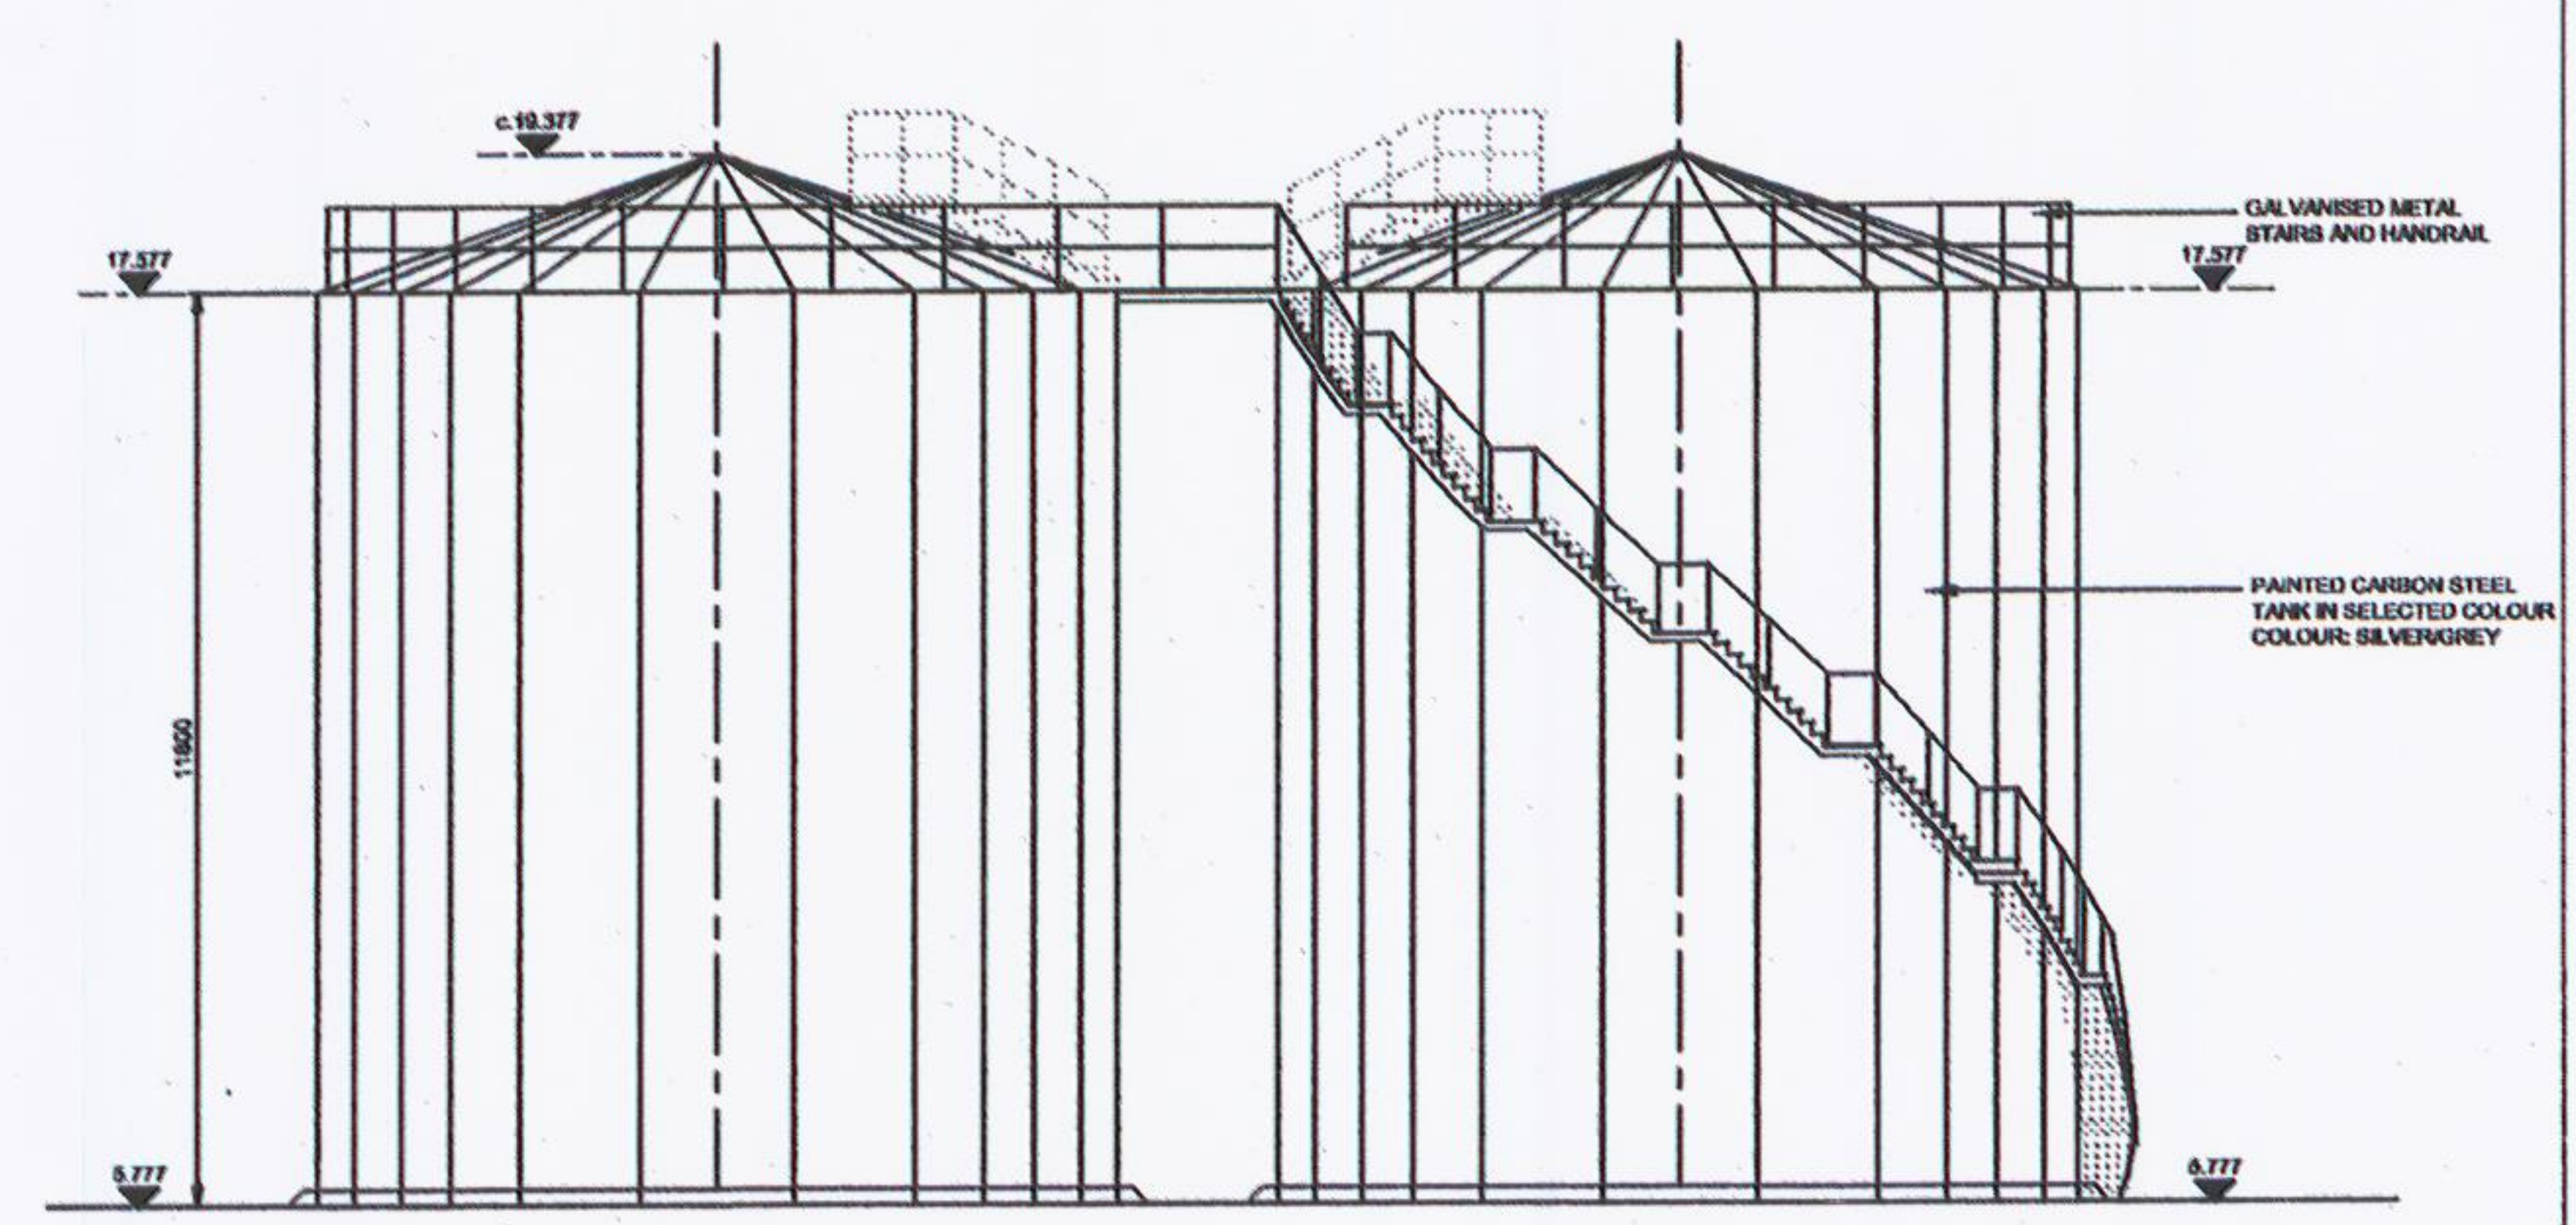

WATER TANKS NORTH ELEVATION
SCALE 1:100

0	ISSUED FOR PLANNING	DC	FCM	LD	13/1/14	
ISSUE	DESCRIPTION	CHK	CHK	AUTH	APP	DATE
INDAVER IRELAND		INDAVER IRELAND 4 HADDINGTON PLACE DUN LAOGHAIRE CO. DUBLIN TEL: +353 1 214850 FAX: +353 1 285985				
ARUP Consulting Engineers		WILSON ASSOCIATES (1273)1273				
PROJECT: WASTE MANAGEMENT FACILITY-RINGASKIDDY						
TITLE: PROPOSED PUMP HOUSE AND STORAGE TANKS PLANS, ELEVATIONS AND SECTIONS						
CLIENT REF.	CLIENT DRG No.					
PROJECT No.	CORTM DRG No. COS/APP/92/270					
AO SCALE	1/100					